City of Mississauga

Agenda



Port Credit Heritage Conservation District Subcommittee

Date: July 7, 2025 **Time:** 9:30 AM

Location: Online Video Conference

Members

Councillor Stephen Dasko Ward 1

Antoine Musiol Citizen Member (Chair)

Louie ManzoCitizen MemberRenee SzuhaiCitizen MemberStuart GarnerCitizen MemberRobert DenhollanderCitizen MemberRobert DoyleCitizen Member

To Request to Speak on Agenda Items - Advance registration is required. To make a Deputation please email Martha Cameron, Legislative Coordinator at martha.cameron@mississauga.ca or call 905-615-3200 ext. 5438 no later than **Thursday, July 3, 2025 before 4:00 PM.**

Questions for Public Question Period – To pre-register for Public Question Period, questions may be provided to the Legislative Coordinator at least 24 hours in advance of the meeting. Following the preregistered questions, if time permits, the public may be given the opportunity to ask a question on an agenda item. Virtual participants must pre-register.

Virtual Participation - Meetings of the Port Credit Heritage Conservation District Subcommittee Advisory Committee will not be streamed or posted. To speak during the virtual meeting or if you do not have access to the internet, contact the Legislative Coordinator and you will be provided with directions on how to participate. Comments submitted will be considered as public information and entered into the public record.

Contact

Martha Cameron, Legislative Coordinator, Legislative Services

905-615-3200 ext. 5438

Email martha.cameron@mississauga.ca

NOTE: To support corporate waste reduction efforts the large appendices in this agenda can be viewed online.

Find it Online

http://www.mississauga.ca/portal/cityhall/heritageadvisory

1. CALL TO ORDER

2. INDIGENOUS LAND STATEMENT

"We acknowledge the lands which constitute the present-day City of Mississauga as being part of the Treaty and Traditional Territory of the Mississaugas of the Credit First Nation, The Haudenosaunee Confederacy the Huron-Wendat and Wyandotte Nations. We recognize these peoples and their ancestors as peoples who inhabited these lands since time immemorial. The City of Mississauga is home to many global Indigenous Peoples.

As a municipality, the City of Mississauga is actively working towards reconciliation by confronting our past and our present, providing space for Indigenous peoples within their territory, to recognize and uphold their Treaty Rights and to support Indigenous Peoples. We formally recognize the Anishinaabe origins of our name and continue to make Mississauga a safe space for all Indigenous peoples."

- 3. APPROVAL OF AGENDA
- 4. DECLARATION OF CONFLICT OF INTEREST
- 5. MINUTES OF PREVIOUS MEETING
- 5.1 Draft Port Credit Heritage Conservation District Subcommittee minutes May 26, 2025
- 6. DEPUTATIONS

Any member of the public interested in making a deputation to an item listed on the agenda must register by calling 905-615-3200 ext. 5438 or by emailing martha.cameron@mississauga.ca by Thursday, July 3, 2025 before 4:00 PM.

Each Deputation to the Subcommittee is limited to speaking for not more than 10 minutes.

Pursuant to Section 57.1 of the Council Procedure By-law 0044-2022, as amended:

Deputations shall be received and the matter shall be referred to staff for a report, unless there is a resolution or recommendation passed to "receive" the Deputation. After a Deputation is completed, Members shall each have one opportunity to make a preamble statement and ask questions to the Deputant(s) or staff for clarification purposes only, and without debate.

6.1 Cherie Ng, Architect of Cherie Ng Architect Inc., with respect to Clarke Memorial Hall Restoration

7. PUBLIC QUESTION PERIOD

Public Comments: Members of the Public that have a question about an item listed on the agenda may pre-register by contacting the Legislative Coordinator at least 24 hours in advance of the meeting. Following the registered speakers, if time permits the Chair will acknowledge members of the public who wish to ask a question about an item listed on the agenda. Virtual participants must pre-register.

Pursuant to Section 58 of the Council Procedure By-law 0044-2022, as amended:

The Port Credit Heritage Conservation District Subcommittee may grant permission to a member of the public to ask a question of the Port Credit Heritage Conservation District Subcommittee with the following provisions:

- 1. Questions may be submitted to the Clerk at least 24 hours prior to the meeting;
- 2. A person is limited to two (2) questions and must pertain specific item on the current agenda and the speaker will state which item the question is related to;
- 3. The total speaking time shall be five (5) minutes maximum, per speaker, unless extended by the Mayor or Chair; and
- 4. Any response not provided at the meeting will be provided in the format of a written response.
- 8. MATTERS TO BE CONSIDERED
- 8.1 161 Lakeshore Road West (Ward 1)
- 9. OTHER BUSINESS
- 10. DATE OF NEXT MEETING

August 25, 2025 at 9:30 AM

11. ADJOURNMENT

Minutes



Port Credit Heritage Conservation District Subcommittee

Date: May 26, 2025 Time: 9:30 AM

Location: **Online Video Conference**

Members Present **Antoine Musiol** Citizen Member

(Chair)

Louie Manzo Citizen Member Renee Szuhai Citizen Member Stuart Garner Citizen Member Robert Denhollander Citizen Member (arrived at 9:59

AM)

Robert Doyle Citizen Member

Members Absent Councillor Stephen Dasko Ward 1

Staff Present

John Dunlop, Manager, Indigenous Relations, Heritage and Museums Paula Wubbenhorst, Heritage Planner Martha Cameron, Legislative Coordinator

2

1. <u>CALL TO ORDER</u>

Antoine Musiol, Chair called the meeting to order at 9:33 AM.

2. <u>INDIGENOUS LAND STATEMENT</u>

Antoine Musiol, Chair recited the Indigenous Land Statement.

3. APPROVAL OF AGENDA

Approved (R. Doyle)

4. <u>DECLARATION OF CONFLICT OF INTEREST</u> - Nil

5. MINUTES OF PREVIOUS MEETING

5.1 Draft Port Credit Heritage Conservation District Subcommittee minutes - March 3, 2025

Approved (S. Garner)

6. <u>DEPUTATIONS</u>

There were no deputations presented.

7. PUBLIC QUESTION PERIOD

There were no questions registered by the public.

8. <u>MATTERS TO BE CONSIDERED</u>

8.1 Request to Alter 18 John Street South (Ward 1)

Subcommittee members spoke to the application and noted concerns with the symmetry of the pitch, proposed parking, window design and divisions of the side lights.

Staff spoke to the concerns of the Subcommittee and permit conditions that would see a redesign on the west Port side elevation.

RECOMMENDATION PCHCD-0003-2025

Moved By S. Garner

- 1. That the request to alter 18 John Street South (Ward 1), as per the memorandum from John Dunlop, Manager of Indigenous Relations, Heritage & Museums, dated April 22, 2025, be approved with the following conditions;
- 2. That the Port Street West elevation be more symmetrical with regards to the roof line:
- That the parking and curb cut on Port Street West be identified on the site plan;
- 4. That if SDL (simulated divided lite) windows are employed, they have clear and proper muntins on both sides of the windows.

<u>Approved</u>

3

9. **OTHER BUSINESS**

Subcommittee members spoke to the recommendation for 42 John Street and the final materials that were chosen and were advised by staff that wood siding would be used.

Subcommittee members expressed concern with a neighbourhood property and were advised of the involvement of compliance and that further communications would occur with the owner through the appropriate departments. Staff also spoke to the heritage approval process for this property once the intention of the owner is determined.

10. **DATE OF NEXT MEETING**

July 7, 2025 at 9:30 AM

11. ADJOURNMENT - 10:20 AM

(L. Manzo)



Clarke Memorial Hall Restoration Port Credit, City of Mississauga

Heritage Building Permit Presentation Port Credit Heritage Conservation District

July 7 & 22, 2025



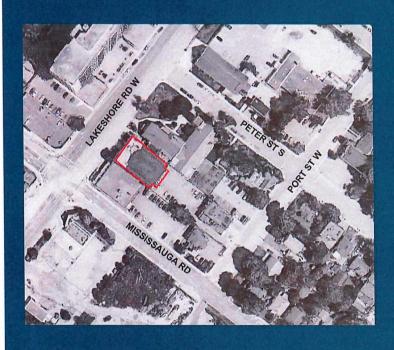








building description



• Address: 161 Lakeshore Rd W

• Built: 1922

• Use: Community Hall

• Architecture: Spanish Colonial Revival Style

• Exterior Elements:

Six Monumental Pilasters and brackets

Classical Frontispiece

Arched Windows

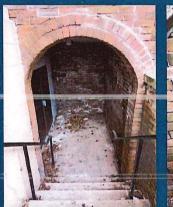




proposed restoration

STAIR

- Replace Front Entrance Stair
 - Not Original: Replaced in the 1990s
 - Existing Stair is Shifting
 - Landing
 - Brick Walls
 - Railings to Meet FADS


















proposed restoration






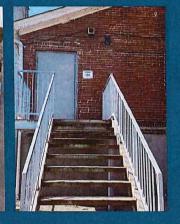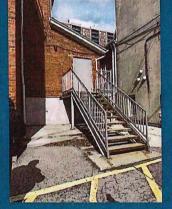








STAIR

- Replace Emergency Stair
 - Rusting
 - Meet FADS

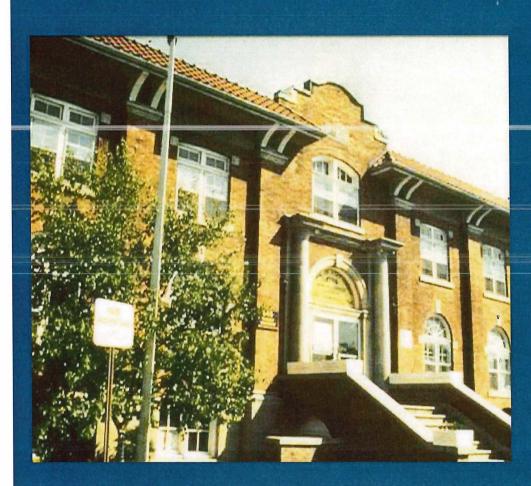CHERIE NG





conservation strategy

STAIRS

- To be Rebuilt to Match Existing
 - Use the Existing Stair and Landing as a Model to Reproduce the Stair with the Same Materials
 - Existing Columns Supported on Landing to be Maintained and Shored
- Railing Extended to Meet FADS
- Bronze Railing same as Existing
- Stair Risers to be Even to Meet FADS





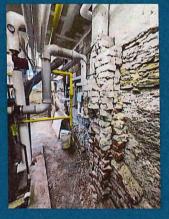
proposed restoration

WALLS

- Repointing
 - Stone Masonry from Grade to Ground Floor
 - Refill Original Filled Window Openings
 - Reinstate Concrete Foundation at Utility Room

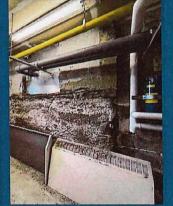


















proposed restoration

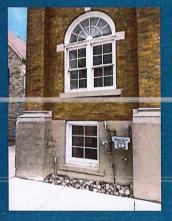





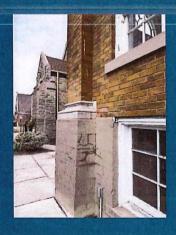- Parging and Repairs
 - Remove Parging on above Grade Stone Masonry to Expose Original Stone Masonry
 - Remove and Replace Corroded Window Lintels










conservation strategy

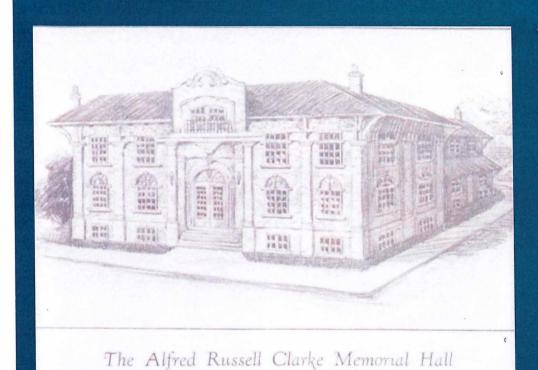


WALLS

- Repair Damaged Exterior Wall
 - Remove Parging to Expose Original Stone
 - Repointing Masonry where Deteriorated
- Repairs to Match Existing Work as Closely as Possible, both Physically and Visually

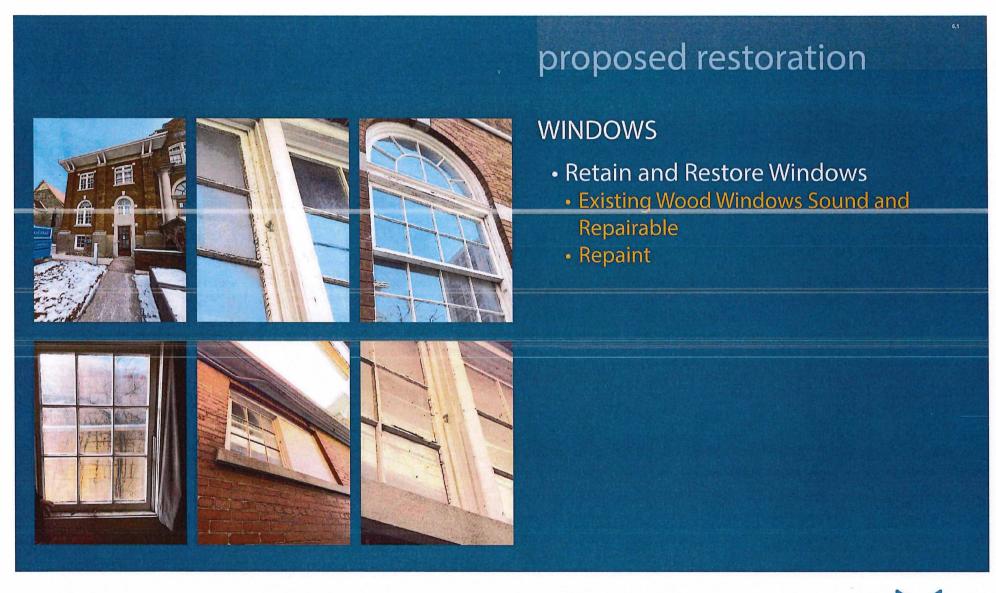CHERIE NG ARCHITECT











conservation strategy

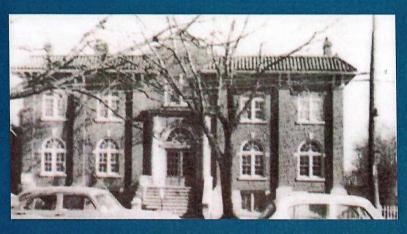

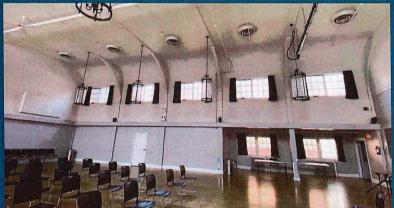

WINDOWS

- To be Restored
 - Remove Dirt, Debris, Deteriorated Paint
 - Selective Repair of Damaged Wood
 - Repaint Wood Frames to Match the Existing
 - Existing Caulking to be Removed, and Re-sealed.
 - Install Wood-Framed Interior Storm Windows on all Fixed Units

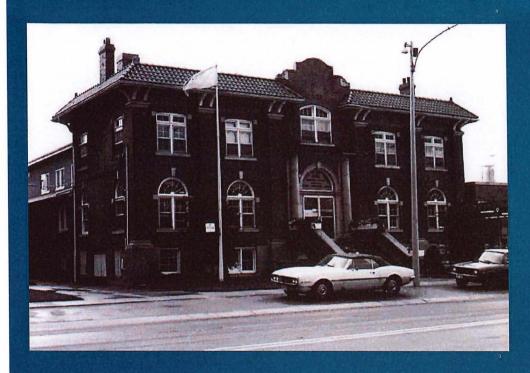




proposed restoration **ROOF** Attic Doors Replace Two Wood Doors Roof Fascia and Soffit Repairs Wood Fascia and Soffit








conservation strategy

ROOF

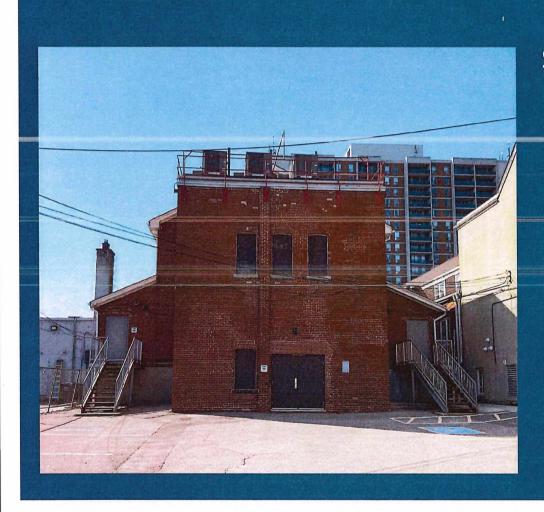- Attic Doors
 - Install Two New Cedar Doors
- Roof Fascia and Soffit
 - Selective Repairs of Existing Wood Fascia and Soffit in Cedar







rear signage

SIGNAGE

- Wayfinding
 - Direct Users from Parking Lot to

Accessible Entrance

- Mounted at Mortar Joints
- Comply with FADS
- Exit Sign
 - Two "Emergency Exit" Signs on Exterior Face of Fire-Exit Doors
 - Comply with FADS







Discussion | Feedback





City of Mississauga

Memorandum



Date: June 24, 2025

To: Chair and Members of Port Credit Heritage Conservation District

Subcommittee

From: John Dunlop, Manager, Indigenous Relations, Museums and Heritage

Meeting date: July 7, 2025

Subject: 161 Lakeshore Road West (Ward 1)

Recommendation

That the request to alter the property at 161 Lakeshore Road West (Ward 1), as per the memorandum from John Dunlop, Manager of Indigenous Relation, Heritage and Museums, dated June 24, 2025, be approved.

Background

The subject property is designated under Part V of the Ontario Heritage Act as it forms part of the Old Port Credit Village Heritage Conservation District (HCD). It is considered a contributing property. Changes to the property are subject to the Old Port Credit Village HCD Plan, 2018.

Comments

The City proposes restoration work to Clarke Hall, including changes to make it more accessible. The proposal is attached as Appendices 1 and 2. The scope of work includes the following:

- brick repointing where needed;
- replicated wood attic doors;
- new wood interior storms;
- restore: windows, window lintels, original foundation, roof fascia and soffits.

All restoration work will be in original material and style. Rear emergency exit stairs would be replaced. The front main entrance stair would be replaced "like-for-like," with extended bronze railings for accessibility purposes. Final signage is subject to a heritage permit, as per the Old Port Credit Village Heritage Conservation District Plan.

Conclusion

The proposed restoration work would benefit the building and make it more accessible. As such, it should be approved.

Attachments

Appendix 1: Statement of Work

Appendix 2: Drawings

Prepared by: P. Wubbenhorst, Heritage Planner

STATEMENT OF WORK

CLARKE MEMORIAL HALL


161 LAKESHORE WEST

JUNE 202:





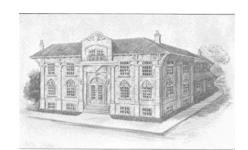INTRODUCTION




The Alfred Russell Clarke Memorial Hall

CHERIE NG ARCHITECT INC. (CNA) has been retained by the City of Mississauga to undertake a restoration project at Clarke Memorial Hall, a designated heritage property located at 161 Lakeshore Road West in Port Credit. This Statement of Work has been prepared in support of a Heritage Permit application and outlines the proposed scope of conservation, restoration, and accessibility upgrades.

The objective of this project is to respectfully restore key architectural features of Clarke Memorial Hall while ensuring compliance with the City of Mississauga's Facility Accessibility Design Standards (FADS) and applicable building codes. All interventions will be carried out with sensitivity to the building's heritage character, prioritizing the conservation of original materials and detailing. Where replacement is necessary, new elements will match the existing in material, profile, and proportion to maintain historical continuity.

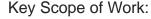
The restoration approach emphasizes conservation best practices, including the repair and retention of original features to minimize intervention and preserve the building's historic appearance. This Heritage Permit application affirms that all design and construction decisions are guided by a commitment to the long-term preservation of Clarke Memorial Hall as a valued cultural asset within the City of Mississauga.



- Restore all original wood windows by removing dirt, debris, and loose or peeling paint in preparation for repainting. The new paint colour will match the existing.
- Remove the existing parging on the foundation to expose and restore the original building stone.
- Undertake repointing and localized repairs to the exterior masonry and the interior backstage wall.
- Replace the front entrance stair with a like-for-like reconstruction matching the original in material and design. Replace the rear emergency exit stair to meet FADS and OBC accessibility requirements.



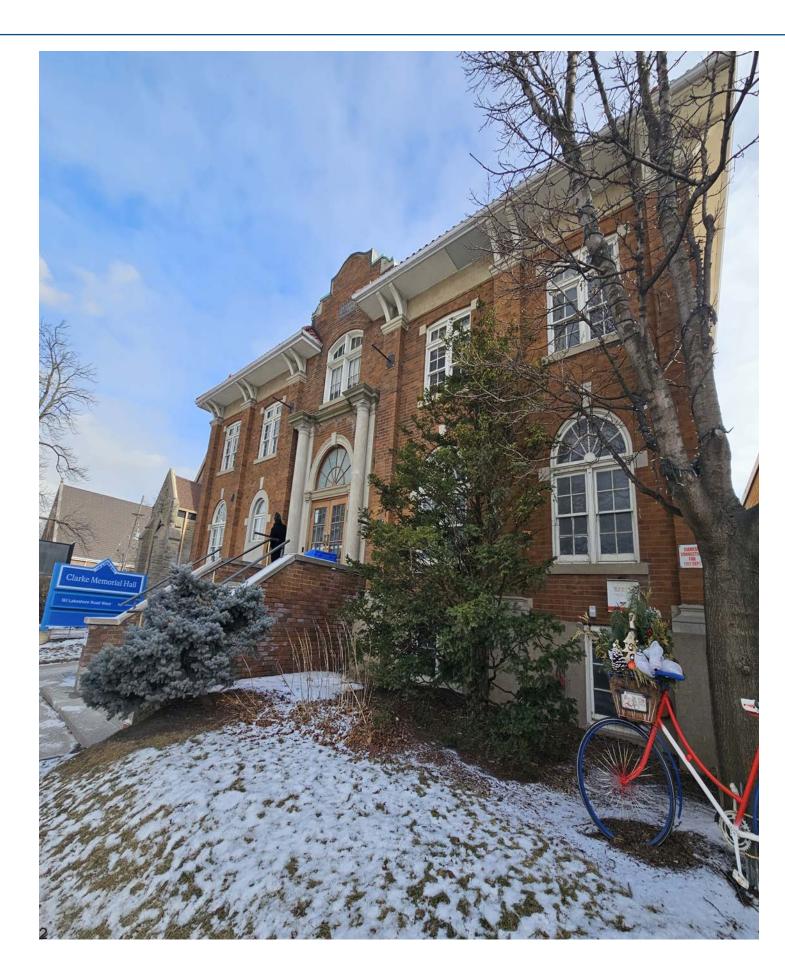CHERIE NG ARCHITECT INC.



SCOPE OF WORK

SCOPE OF WORK





SCOPE OF WORK

Front Stair Replacement

- The existing front stair assembly is not original to the building and based on archive drawings was replaced in the 1990s. The stairs are in poor condition and will be removed and replaced with a like-for-like reconstruction. Structural displacement is visible between the stair walls and main stair structure, and the concrete steps are spalling near the railing base due to rusting.
- Efflorescence is present on the brick veneer wall at the basement exit, indicating ongoing moisture penetration.
- The new stair will:
 - Replicate the dimensions, materials, and detailing of the original design.
 - Match the finish, proportions, and alignment of the original
 - Comply with the City of Mississauga's FADS and the current Ontario Building Code.
- Tactile Walking Surface Indicators will be installed at the landing.
- Existing railings will be removed and replaced with new bronze railings that comply with OBC and FADS requirements. The new railings will use the same material and designed to replicate the original profile as closely as possible, while meeting modern safety and accessibility standards to comply with the OBC.
- The new railings are proposed to extend 300mm beyond the beginning and end of the stair. This extension is proposed to accommodate FADS handrail design requirements. The extended railings will improve accessibility by creating additional support as individuals transition from the stairs to a level surface.
- Stair risers will be modified as needed to ensure the bottom landing aligns flush with the adjacent walkway, eliminating the existing trip hazard to comply with FADS.



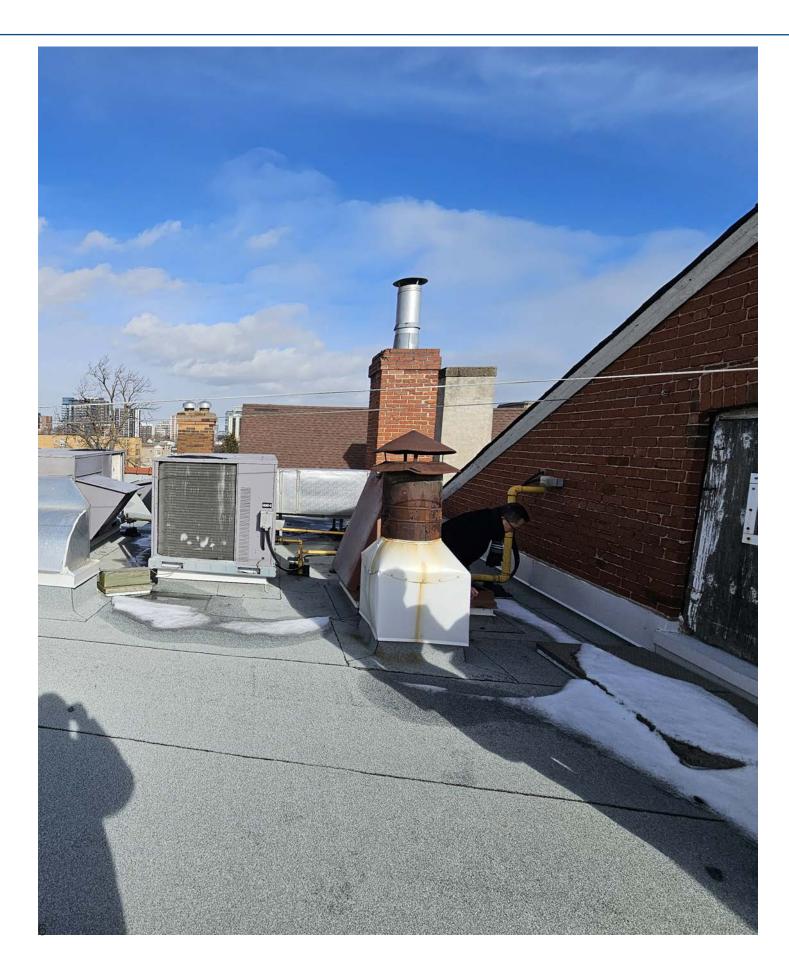
Emergency Stair Replacement

- As identified in the Structural Assessment for Clarke Memorial Hall prepared by Rimkus Consulting Group (dated April 2, 2024), the rear emergency exit stairs exhibit severe corrosion in multiple components, including steel angle supports at their connection to the base building. Cross-sectional loss has compromised the structural integrity of the assembly.
- Both rear emergency exit stairs will be removed and replaced with new assemblies that meet current OBC and FADS requirements.
- Tactile Walking Surface Indicators will be installed at all landings to enhance accessibility.
- New stair to look similar to existing and require minimal intervention using existing anchor points to install staircase.



Storm Windows

· Wood-framed interior storm windows to be installed on fixed







- original wood window units.
- Installation on the exterior is not possible as the existing sills are too shallow to accommodate storm windows. Storm windows to be installed on the interior.
- Custom-fabricated to match the dimensions and profiles of the existing windows. They will be painted to match the existing colour.

Rear Wayfinding Signage

- Wayfinding signage installed to direct individuals from the parking lot to the accessible entrance.
- The signs are to be mounted at mortar joints to avoid damage to original masonry and follow heritage conservation best practices to preserve the integrity of the building envelope.
- Two "Emergency Exit" signs to be installed on the exterior face of both fire-exit doors.
- All signage to comply with FADS guidelines.

Roof Fascia and Soffit Repairs

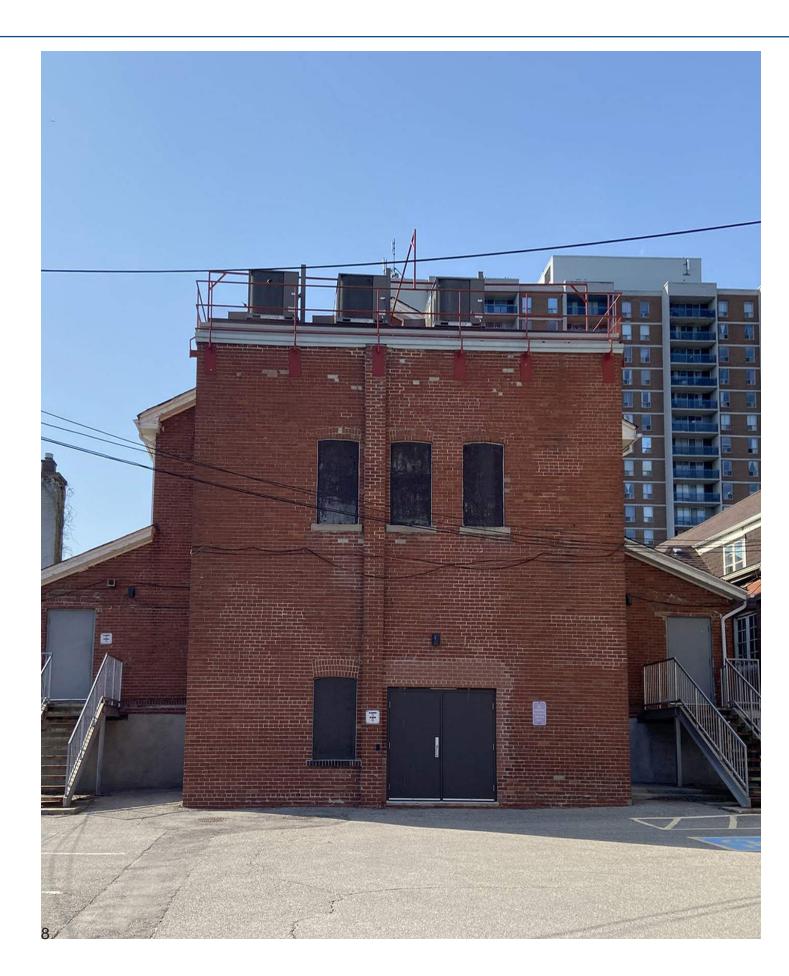
- · Existing fascia and soffits are painted wood.
- Repairs to be carried out using cedar and replacement sections to match original profiles, dimensions, and finishes.

Window Lintels

- Existing lintels are concrete.
- Corroded or deteriorated lintels to be repaired or replaced with like-for-like concrete.
- All new work will match the profile, scale, and appearance of the existing lintels to preserve visual consistency across the façade.

Wood Attic Doors

- Two new attic access doors to be installed using cedar, selected to match the grain and character of the original doors.
- The new doors will replicate the proportions, detailing, and panel configuration of the existing attic doors.




CONCLUSION



The proposed scope of work for Clarke Memorial Hall includes the restoration of original wood windows, removal of parging to expose the original stone foundation, localized repointing and masonry repairs, and the replacement of both the front entrance and rear emergency stairs—which are not original—to meet current building code and accessibility standards. These interventions address structural and accessibility needs while preserving the architectural identity of this designated heritage property.

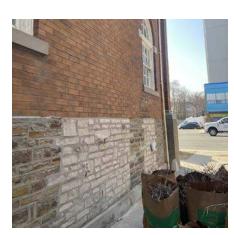The conservation strategy emphasizes minimal intervention, the repair and retention of character-defining elements wherever possible, and the use of materials and finishes that physically and visually match the existing building. Where new elements are introduced—such as tactile walking surface indicators and replacement railings—care has been taken to ensure these additions do not detract from the building's heritage character.



The window restoration involves the retention and repair of original wood components, along with the installation of traditional wood exterior storm windows to improve performance while maintaining the building's historic identity. Masonry repairs will be completed using lime-based mortars that match the original in colour, composition, and tooling. Stair replacements and accessibility upgrades are designed to enhance safety and usability while conserving the original design intent.

This Statement of Work has been prepared in support of a Heritage Permit application for Clarke Memorial Hall. The objective is to conserve and enhance the building's historic character while accommodating necessary functional improvements. All proposed work has been developed to guide careful implementation in a manner that respects the cultural significance, architectural context, and long-term conservation of this valued heritage resource.

1 LOCATION PLAN NTS **CLARKE MEMORIAL HALL**

161 LAKESHORE RD W, MISSISSAUGA, ON L5H 1G3

ISSUED FOR HERITAGE PERMIT 09 JUNE 2025

RESTORATION

CHERIE NG ARCHITECT INC.

T. 416.898.1979 CNG@CHERIENG.COM

BLACKWELL STRUCTURAL ENGINEERS

STRUCTURAL CONSULTANT

JDX ADVANCE SERVICE INC.

MECHANICAL AND ELECTRICAL CONSULTANT

DRAWING LIST LOCATION MAP / DRAWING LIST / GENERAL NOTES / LEGENDS BASEMENT FLOOR PLAN - DEMOLITION PLAN BASEMENT FLOOR PLAN - DEMOLITION PLAN PHOTOS GROUND FLOOR PLAN - DEMOLITION PLAN GROUND FLOOR PLAN - DEMOLITION PLAN PHOTOS GROUND FLOOR PLAN - RESTORATION PLAN PHOTOS SECOND FLOOR PLAN - DEMOLITION PLAN ATTIC - DEMOLITION PLAN ATTIC - DEMOLITION PLAN PHOTOS ROOF - DEMOLITION PLAN BASEMENT FLOOR - ENLARGED DEMOLITION PLAN GROUND FLOOR - ENLARGED DEMOLITION PLAN BASEMENT FLOOR - PROPOSED PLAN GROUND FLOOR - PROPOSED PLAN GROUND FLOOR - ENLARGED PROPOSED PLAN NORTH AND SOUTH ELEVATIONS EAST AND WEST ELEVATIONS INTERIOR ELEVATIONS PROPOSED SECTIONS A5.2 STRUCTURAL S001 GENERAL NOTES BASEMENT PLAN GROUND FLOOR PLAN ROOF PLAN NORTH AND SOUTH ELEVATION EAST AND WEST ELEVATION SECTIONS AND DETAILS MECHANICAL
M100 NOTES, LEGENDS AND SCHEDULES HVAC BASEMENT LAYOUTS HVAC L1 LAYOUT HVAC ROOF LAYOUTS NOTES, LEGENDS AND SCHEDULES

POWER BASEMENT LAYOUTS

POWER L1 LAYOUT

GENERAL NOTES

GENERAL NOTES & CONDITIONS THAT APPLY TO THE ENTIRE WORK: 1. THESE PLANS ARE TAKEN FROM ARCHIVE DRAWINGS AND LIMITED SITE SURVEY INFORMATION. THE CONTRACTOR IS RESPONSIBLE FOR VISITING THE SITE TO CONFIRM THE SITE CONDITIONS PRIOR TO SUBMITTING BID. 2. ALL DIMENSIONS ARE PER SITE REVIEW AND EXISTING ARCHITECTURAL DRAWINGS. ALL DISCREPANCIES BETWEEN CONDITIONS SHOWN AND SITE CONDITIONS ARE TO BE REPORTED TO ARCHITECT.

3. CONTRACTOR SHALL CHECK AND VERIFY ALL DIMENSIONS AND REPORT ALL ERRORS AND OMISSIONS TO THE DESIGN PROFESSIONAL WHOSE SEAL IS AFFIXED TO THE THIS DRAWING.

5. CONTRACTOR TO SITE VERIFY ALL DIMENSIONS, CONDITIONS AND LEVELS ON SITE PRIOR TO FABRICATIONS/INSTALLATIONS.

6. DRAWINGS ARE NOT TO SCALED.

7. LOCATE AND PROTECT ALL UTILITIES.

8. CONSTRUCTION MUST CONFORM TO ALL APPLICABLE CODES AND REQUIREMENTS OF AUTHORITIES HAVING JURISDICTION. 9. PROVIDE SECURE CONTROL OF SURFACE INSTALLATION AND FINISH

APPLICATIONS TO PREVENT PERMANENT EFFECTS OF VANDALISM DURING

10. OBTAIN APPROVAL OF LAYOUT PRIOR TO STARTING WORK. 11. PROVIDE TEMPORARY CONSTRUCTION FENCE 1.8M HIGH MODULAR METAL FENCE WITH LOCKABLE GATE AS REQUIRED TO SECURE THE WORK ZONE.

CONTROL FOR POTENTIAL SILICA IN CONCRETE / MORTAR. 13. FORMING CONTRACTOR TO PROVIDE SHOP DRAWINGS FOR CONSULTANT'S REVIEW PRIOR TO CONCRETE FOOTING WALL INSTALLATION.

12. CONTRACTOR IS RESPONSIBLE TO INCLUDE IN HIS SCOPE OF WORK DUST

15. CONTRACTOR TO COORDINATE WITH FOOTING WALL DIMENSIONS PRIOR TO

16. ALL COLOURS AND MATERIALS TO BE REVIEW BY ARCHITECT.

18. READ THIS DRAWING IN CONJUNCTION WITH THE COMPLETE ARCHITECTURAL, MECHANICAL, ELECTRICAL AND SPRINKLER DOCUMENTATION. 19. REPAIR, PATCH & MAKE GOOD ALL EXISTING STRUCTURE AND FINISHES

AFFECTED BY CONSTRUCTION. 20. ALL NEW WORK TO MAKE GOOD EXISTING; SHALL MATCH EXISTING IN MATERIAL, CONSTRUCTION AND FINISH UNLESS OTHERWISE SPECIFIED. 21. PROTECT EXISTING FINISHES TO REMAIN AS INDICATED IN DOCUMENTATION.

WHERE DEMOLITION WORK IMPACTS ON THESE FINISHES, PATCH AND MAKE GOOD TO MATCH EXISTING. 22. CONTRACTOR SHALL PERFORM ALL NECESSARY DEMOLITION, ALTERATIONS AND NEW CONSTRUCTIONS AS REQUIRED TO MAKE THE WORK A COMPLETE JOB,

INCLUDING BUT NOT LIMITED TO WORK SHOWN ON DRAWINGS AND SPECIFICATIONS. 23. ANY OPENINGS IN FIRE RATED WALLS, CEILINGS AND FLOORS TO BE

RETURNED TO EQUIVALENT CONDITION PRIOR TO THE OPENING. ALL ELECTRICAL & MECHANICAL PENETRATIONS TO BE SEALED WITH FIRE STOP MATERIAL AS PER SPECIFICATION AND OBC.

24. ALL REQUIRED CUTTING & FITTING INCLUDING ELECTRICAL & MECHANICAL TO CONNECT EXISTING WORK WITH THE NEW WORK TO BE PERFORMED AS PART OF THIS CONTRACT TO FINISH THE ENTIRE WORK IN A WORKMANLIKE AND

25. ALL NEW WORK TO MAKE GOOD EXISTING; SHALL MATCH EXISTING IN MATERIAL, CONSTRUCTION AND FINISH UNLESS OTHERWISE SPECIFIED. 26. REFER TO MECHANICAL AND ELECTRICAL DOCUMENTATION FOR SPECIFIC EQUIPMENT TO BE REMOVED. PATCH AND MAKE GOOD ANY DAMAGE CAUSED BY REMOVAL OF MECHANICAL AND ELECTRICAL EQUIPMENT OR BY RELATED DEMOLITION WORK.

29. CONDUCT X-RAYS AND PERFORM INSPECTIONS AT AREAS WHERE CUTTING, DRILLING OR SLEEVING THROUGH EXISTING STRUCTURE IS REQUIRED TO ENSURE EXISTING SERVICES WILL NOT BE DAMAGED. REPAIR AND REINSTATE EXISTING SERVICES IMMEDIATELY IF DAMAGED.

30. CONTACT CONSULTANT IMMEDIATELY IF ANY UNKNOWN SERVICES ARE UNCOVERED AND INTERFERE WITH NEW WORK.

31. REMOVE ALL FURNISHINGS WITHIN THE EXTENT OF NEW WORK. CO-ORDINATE RELOCATION OR DISPOSAL WITH OWNER. ITEMS TO BE

32. ALL ITEMS INDICATED IN THE CONTRACT DOCUMENTS AS 'COORDINATION ITEMS' OR ITEMS IDENTIFIED AS N.I.C., INCLUDING BUT NOT LIMITED TO THE EQUIPMENT, SECURITY, DATA CONNECTION, SERVER, AUDIO & VISUAL AND OTHER SPECIALTY ITEMS IDENTIFIED, ARE TO BE SUPPLIED AND INSTALLED BY OTHER PARTIES OR ALLOWANCES BUT WILL REQUIRE THE COMMON ACTION OR EFFORT OF THE GENERAL CONTRACTOR IN RELATION TO THE OVERALL PROJECT. WITH RESPECT TO ALL COORDINATION ITEMS IDENTIFIED, THE GENERAL CONTRACTOR IS EXPECTED TO: -BUILDING ENVELOPE INSPECTIONS

-STRUCTURAL INSPECTIONS -WATERPROOFING MEMBRANE INSPECTIONS -CITY'S SECURITY VENDOR

-CITY'S CORPORATE SECURITY -BELL CANADA VOICE AND DATA CONNECTION -FIRE DEPARTMENT -CITY'S IT DEPARTMENT

31. REVIEW ALL ITEMS IDENTIFIED AS 'COORDINATION ITEMS' IN THE DRAWINGS AND COMMUNICATE WITH THE REQUIRED RESPONSIBLE PARTIES OF THE DEVICES THE DETAILED REQUIREMENTS OF EACH ITEM AS IT IMPACTS THE WORK OF GENERAL CONTRACTOR AND AS IT RELATES TO THE OVERALL COMPLETION OF

A. VERIFY THE EXISTING CONDITION AND ANY LIMITATIONS OF THE DEVICE AS INSTALLED IN THE PROPOSED LOCATION. B. COORDINATE WORK OF OWNER'S OWN FORCE INTO THE OVERALL CONSTRUCTION SEQUENCE

. PROVIDE ALL REQUIRED ROUGH-INS, RELATED CONSTRUCTIONS AND CONNECTIONS REQUIRED BY THE DEVICES OF OTHERS TO SUIT THE COORDINATION ITEM AND AS INDICATED IN THE CONTRACT DOCUMENTS. D. SCHEDULE AND COORDINATE THE WORK OF OTHERS INTO THE OVERALL CONSTRUCTION SEQUENCE TO AVOID UNNECESSARY DELAY TO THE COMPLETION OF THE OVERALL PROJECT. E. ENSURE THAT THE PROPOSED ITEM IS INSTALLED AS INTENDED AND IS MADE FULLY OPERATIONAL AT THE COMPLETION OF THE WORK.

32. CONSULTANT / TOWN WILL APPLY FOR BUILDING PERMIT. CONTRACTOR TO SCHEDULE ALL REQUIRED INSPECTIONS.

33. THE BUILDING WILL REMAIN IN OPERATION DURING THE COURSE OF CONSTRICTION. INTERIOR AND EXTERIOR WORK IS TO OCCUR IN PHASES THROUGHOUT THE BUILDING AND MUST BE COORDINATED WITH THE BUILDING USERS AND OWNERS TO MINIMIZE DISRUPTION TO STAFF AND THE FACILITY OPERATIONS.

34. COMPLY WITH THE MOST CURRENT REQUIREMENTS OF THE OCCUPATIONAL HEALTH AND SAFETY ACT, REGULATION FOR CONSTRUCTION PROJECT.

35. BE RESPONSIBLE FOR THE PROTECTION AND SAFETY OF ALL PEDESTRIANS AND VEHICLES IN THE WORK AREA. PROVIDE AND INSTALL BARRICADES, SIGNS, GUARDRAILS, ETC AS REQUIRE. AT THE CONCLUSION OF EACH DAY'S WORK, ENSURE THAT ALL PRECAUTIONS NECESSARY FOR THE PROTECTION AND SAFETY OF PEDESTRIANS AND VEHICLES HAVE BEEN TAKEN.

36. PROVIDE AND MAINTAIN OVERHEAD PROTECTION AT ALL BUILDING ENTRANCES, EXITS, DOORS AND PATIOS.

37. DO NOT BLOCK ANY FIRE EXITS.

38. PROVIDE ADEQUATE PROTECTION OF MATERIALS AND WORK FROM DAMAGE AND STAINING BY WEATHER AND OTHER CAUSES. CONTRACTOR SHALL MAKE GOOD ANY DAMAGE.

39. CONTRACTOR TO ENSURE ALL WALKWAYS / PATHS TO AND FROM ALL ENTRANCE DOORS ARE FREE OF DEBRIS AND OBSTRUCTIONS AT ALL TIMES

40. MAINTAIN AT ALL TIMES CLEAR ACCESS ON DRIVE AISLES ADJACENT TO BUILDING TO THE SITE.

41. MOBILIZATION, STORAGE OR ACCESS NOT PERMITTED AT ADJACENT

42. PARKING IS AVAILABLE ON SITE MUST BE COORDINATED WITH TOWN PM. 43. ACCESS INTO THE BUILDING AREA IS GENERALLY RESTRICTED. NO ACCESS INSIDE THE BUILDING WITHOUT EXPRESSED WRITTEN CONSENT FROM THE TOWN.

44. THE BUILDING WILL BE OCCUPIED DURING CONSTRUCTION. THE GENERAL CONTRACTOR TO COORDINATE PHASING AS REQUIRED AND MUST BE COORDINATED WITH THE BUILDING USERS AND OWNERS TO MINIMIZE DISRUPTION TO STAFF AND THE FACILITY OPERATIONS.

MATERIAL ABBREVIATIONS

ACT-1 24" X 48" SUSPENDED ACOUSTIC TILE CEILING SYSTEM

ADO AUTOMATIC DOOR OPERATOR

AL-1 PREFINISHED ALUMINUM

BB-1 BULLETIN BOARD BARRIER-FREE MIRROR

BARRIER-FREE STAINLESS STEEL SHELF

BUR BUILT-UP ROOF CONCRETE BLOCK

COAT HOOK

ADULT CHANGE TABLE BABY CHANGE TABLE

CERAMIC TILE COLOUR 1 CERAMIC TILE COLOUR CERAMIC TILE COLOUR 3

EPX-1 EPOXY FLOORING (BROADCAST)

HOLLOW METAL HOLLOW METAL FRAME HMF-1A THERMALLY BROKEN HOLLOW METAL FRAME

GB-1 16MM ABUSE-RESISTANT GYPSUM WALL BOARD 16MM TYPE X GYPSUM WALL BOARD

16MM TILE BACKER BOARD

L-SHAPED GRAB BAR GBR-3 GRAB BAR

19MM STANDARD TEMPERED GLASS 6MM STANDARD TEMPERED GLASS 10MM STANDARD TEMPERED GLASS

LINO-1 LINOELUM SHEET FLOORING

MEL-1 MELAMINE COLOUR 1 MEL-2 MELAMINE COLOUR 2

ND SANITARY NAPKIN DISPENSER

PLAM-1 PLASTIC LAMINATE COLOUR #1 PLAM-2 PLASTIC LAMINATE COLOUR #2 PLAM-3 PLASTIC LAMINATE COLOUR #3 PLAM-4 PLASTIC LAMINATE COLOUR #4

PP-1 SOILD PHENOLIC TOILET PARTITION AND / OR DOOR

PAINT COLOUR PAINT COLOUR : PAINT COLOUR .

PAINT COLOUR 4 PAINT COLOUR 5

PAINT COLOUR 6

PTD PAPER TOWEL DISPENSER

POR-1 PORCELAIN TILE TYPE #1 POR-2 PORCELAIN TILE TYPE #: POR-3 PORCELAIN TILE TYPE #3

PVC-1 PVC EDGING COLOUR

PVC-2 PVC EDGING COLOUR 2

RUBBER SKATE FLOORING RUBBER BASE TO MATCH EXISTING

SOAP DISPENSER

SANITARY NAPKIN DISPENSER SOLID SURFACING COLOUR #1

SOL-2 SOLID SURFACING COLOUR #2

STAINLESS STEEL BRUSHED FINISH SS-2 STAINLESS STEEL POLISHED FINISH

STL-1 HOT DIPPED GALVANIZED STEEL

SWF-1 SPRUNG WOOD FLOOR

TTD-1 TOILET PAPER DISPENSER DOUBLE ROLL

THR-1 THRESHOLD TRIM: KN CROWER CT-45 THR-2 THRESHOLD TRIM: SCHLUTER RONDEC E THRESHOLD TRIM: SCHLUTER RENO-T

THR-4 THRESHOLD TRIM: SCHLUTER RENO-U

WAF WOOD ATHLETIC FLOORING

REGULAR PLYWOOD OR WOOD BLOCKING MEL-1 ON PLYWOOD

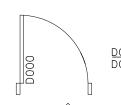
MEL-1 ON PLYWOOD PLAM-1 ON PLYWOOD PLAM-2 ON PLYWOOD

PLAM-3 ON PLYWOOD WOOD VENEER PLYWOOD

SOLID WOOD WD-8WD-9


WASTE RECEPTACLE

SYMBOL LEGEND





DOOR TAG DOOR NUMBER



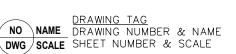


ROOM NUMBER

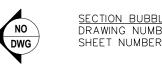


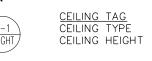

MATERIAL TAG MATERIAL TYPE

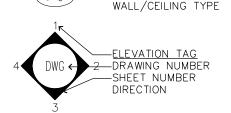

ELEV. ELEVATION

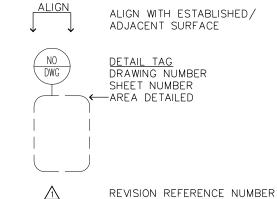

MIR - DESCRIPTION OF MIRROR

SIM - DESCRIPTION OF SIMILAR

TYP - DESCRIPTION OF TYPICAL

MAX - MAXIMUM

MIN - MINIMUM

MATERIAL LEGEND CONCRETE

CONCRETE BLOCK CERAMIC

PORCELAIN CONTINUOUS WOOD BLOCKING

GYPSUM BOARD FINISH WOOD

WOOD VENEER

STANDARD ABBREVIATIONS

TONGUE & GROOVE

UNLESS NOTED OTHERWISE

TOP OF

TYPICAL

UNDERSIDE OF

VERIFY IN FIELD

T/O TYP

UNO

U/S

ADJUSTABLE ABOVE FINISHED FLOOR BUILDING CENTRELINE CONT CONTINUOUS DIAMETER DIMENSION DWG ELEV DRAWING ELEVATOR EX/EXIST EXISTING F/O FRR FACE OF FIRE RESISTANCE RATING FIRE PROTECTION RATING FPR MAX MAXIMUM MIN MINIMUM OWNER SUPPLIED CONTRACTOR INSTALLED NTS NOT TO SCALE ON CENTRE OWNER SUPPLIED CONTRACTOR INSTALLED RADIUS RCP REFLECTED CEILING PLAN REV REVERSE ROOM SIMILAR

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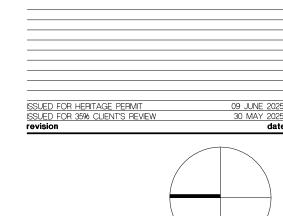
Appendix 2

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2. Drawings are not to be scaled for construction. Contractor to verify all existing conditions and dimensions required to perform the Work and report any discrepancies with the Contract Documents to the Architect before commencing work.

3. Positions of exposed or finished mechanical or electrical devices, fittings, and fixtures are indicated on the Architectural drawings. The locations shown on the Architectural drawings govern over the Mechanical and Electrical drawings. Those items not clearly located will be located as per directed by the



CLARKE MEMORIAL HALL RESTORATION Address:161 LAKESHORE RD W,MISSISSAUGA,ON LOCATION MAP / DRAWING LIST / GENERAL NOTES / LEGENDS

project no. : NTS scale : JUNE 2025

drawing no.:

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DEMOLITION SITE PLAN

OUTSIDE SCOPE OF WORK

PROPERTY LINE

EXISTING CHAIN-LINK FENCE AND POSTS

GENERAL DEMOLITION NOTES:

A. REFER TO STRUCTURAL AND ELECTRICAL DRAWINGS FOR ADDITIONAL DEMOLITION REQUIREMENTS.

B. ACCOUNT FOR WORKING AROUND EXISTING SERVICES.

C. ALL STRUCTURAL ELEMENTS TO REMAIN. UNLESS NOTED OTHERWISE.

D. PATCH, REPAIR AND REFINISH ALL DAMAGED WALL. SURFACES ACCOUNT FOR WORKING AROUND EXISTING SERVICES.

E. PROVIDE DROP CLOTH TO CATCH PAINT AND REMOVE FROM SITE. PROTECT ADJACENT GROUND SURFACE OF BUILDING.

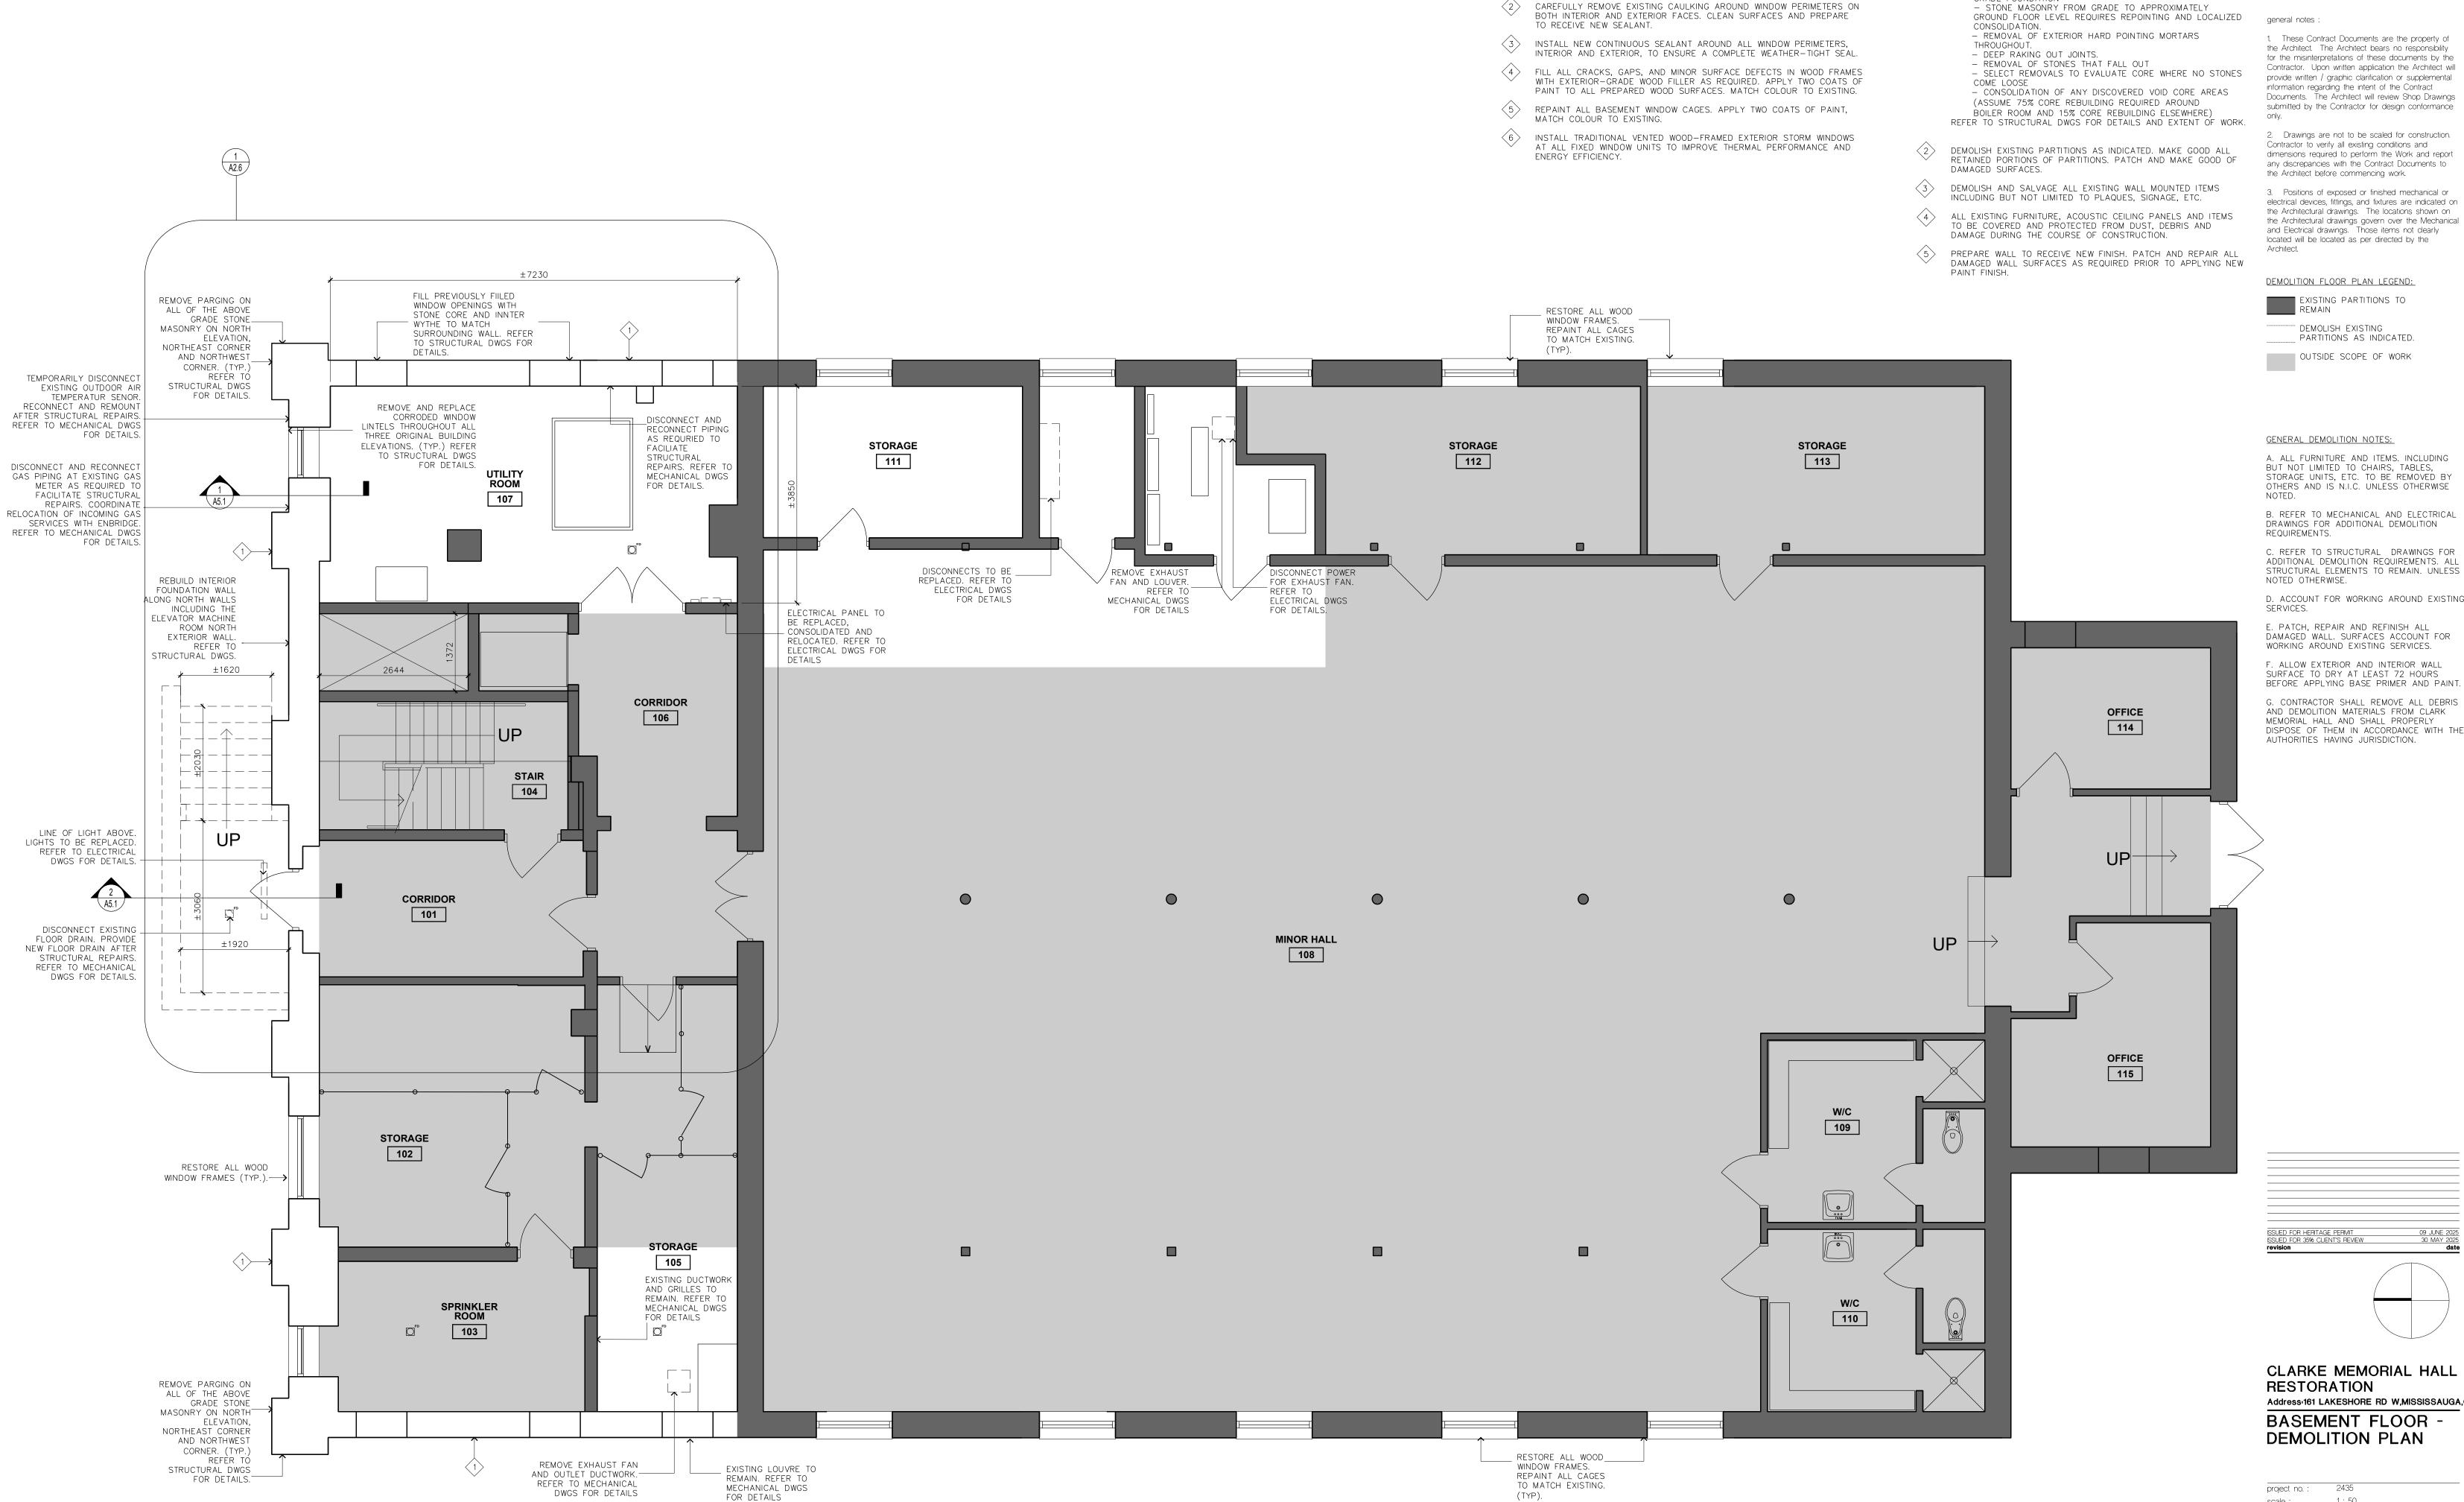
SSUED FOR HERITAGE PERMIT 09 JUNE 20 revision de

CLARKE MEMORIAL HALL
RESTORATION
Address-161 LAKESHORE RD W,MISSISSAUGA,ON
SITE PLAN

project no. : 2435 scale : 1 : 200 date : JUNE 2025

drawing no. :

A1.



<u>WINDOW RESTORATION NOTES:</u>

RECEIVE NEW PAINT.

CLEAN ALL EXISTING WOOD WINDOW FRAMES TO REMOVE DIRT, DEBRIS, AND LOOSE OR PEELING PAINT. SAND AND PREPARE SURFACES TO

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DEMOLITION NOTES:

GRADE FOUNDATION

(1) FOR FULL PERIMETER OF ORIGINAL BUILDING, REPAIR WORK TO

- EXCAVATION AND WATERPROOFING / DRAINAGE OF BELOW

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BUT NOT LIMITED TO CHAIRS, TABLES, STORAGE UNITS, ETC. TO BE REMOVED BY OTHERS AND IS N.I.C. UNLESS OTHERWISE

C. REFER TO STRUCTURAL DRAWINGS FOR ADDITIONAL DEMOLITION REQUIREMENTS. ALL

D. ACCOUNT FOR WORKING AROUND EXISTING

E. PATCH, REPAIR AND REFINISH ALL DAMAGED WALL. SURFACES ACCOUNT FOR

F. ALLOW EXTERIOR AND INTERIOR WALL SURFACE TO DRY AT LEAST 72 HOURS BEFORE APPLYING BASE PRIMER AND PAINT.

AND DEMOLITION MATERIALS FROM CLARK DISPOSE OF THEM IN ACCORDANCE WITH THE

Address:161 LAKESHORE RD W,MISSISSAUGA,ON BASEMENT FLOOR -**DEMOLITION PLAN**

1:50 scale: JUNE 2025

drawing no.:

A2.1

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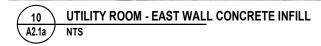
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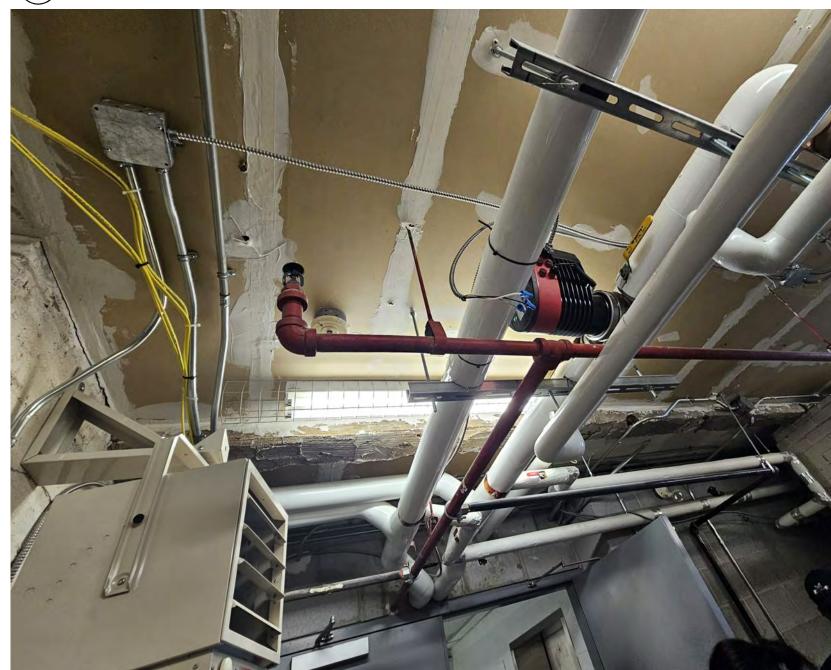
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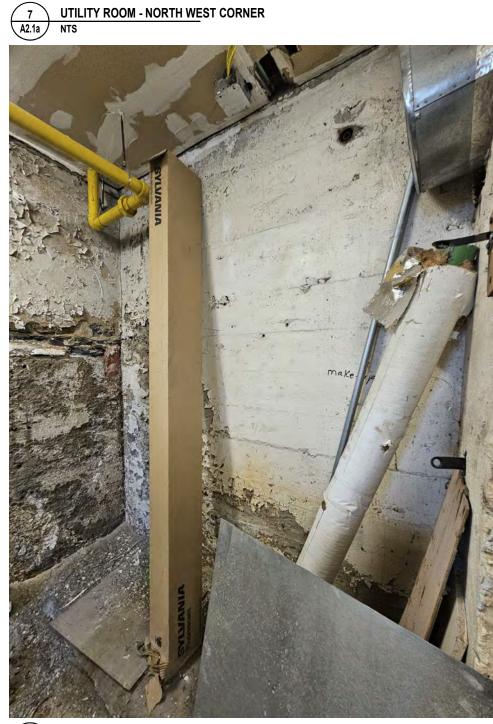
general notes :





11 UTILITY ROOM - CEILING A2.1a NTS



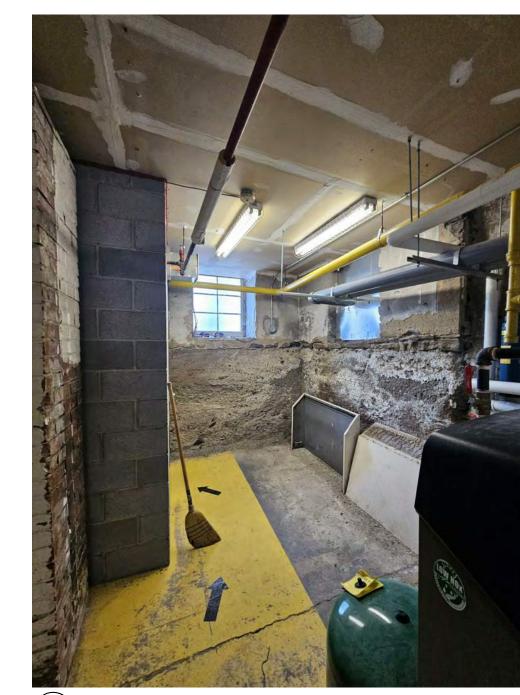








BASEMENT EXTERIOR STAIR CEILING
A2.1a NTS




1 UTILITY ROOM - NORTH EAST CORNER A2.1a NTS



2 UTILITY ROOM - SOUTH EAST CORNER NTS

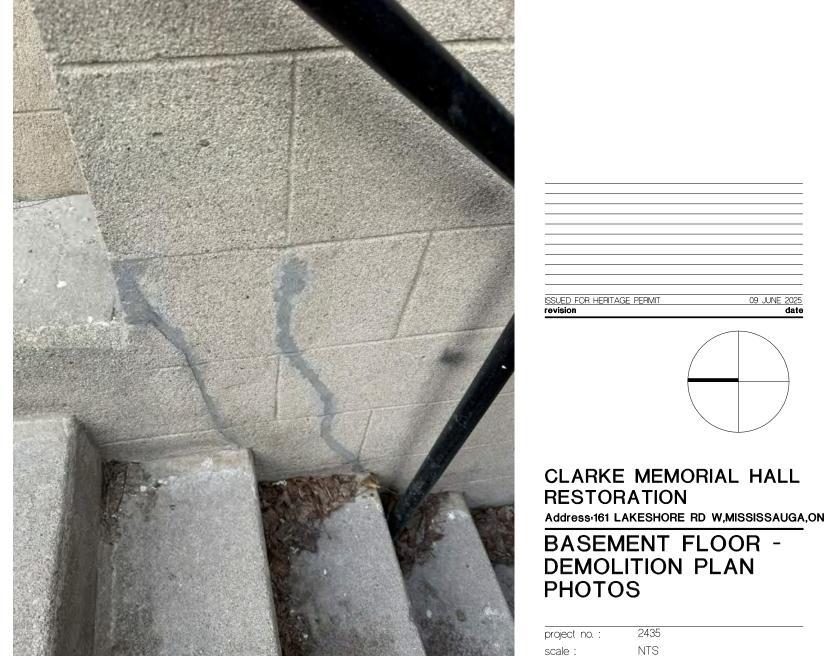BASEMENT EXTERIOR STAIR WALL
A2.1a NTS



BASEMENT FLOOR -DEMOLITION PLAN PHOTOS

A2.1a

WINDOW RESTORATION NOTES:

RESTORE ALL WOOD

WINDOW FRAMES

RESTORE ALL WOOD_

WINDOW FRAMES

(TYP.)

STORAGE

109

MAIN HALL

110

REMOVE EXHAUST FAN,

DWGS FOR DETAILS

DISCONNECT POWER L

TO EXHAUST FAN. REFER TO

ELECTRICAL DWGS _

DISCONNECT CONTROL TO

CLOAK ROOM EXHAUST

FOR EXISTING CLOAK

FAN. SWITCH TO REMAIN

ROOM LIGHTING, REFER TO

ELECTRICAL DWGS FOR

FOR DETAILS

REMOVE ANY FREE-AIR

CABLE RUNS FOR WINDOW

OPERATOR SYSTEM WITHIN

_REMOVE ANY FREE—AIR CABLE RUNS FOR WINDOW OPERATOR SYSTEM WITHIN THE MAIN HALL

AND CAP. (TYP.). REFER TO ELECTRICAL DWGS FOR DETAILS.

JAN

113

REPLACE PANEL RP. _ REFER TO

ELECTRICAL DWGS FOR DETAILS.

SERVERY D

WALL. (TYP.).

 \bigcirc c \bigcirc

ALLOW FOR 23 METERS BY 3 METERS

ABOVE GRADE CONCRETE FOUNDATION

REPAIR/REPARGING ON ALL OF THE

112

THE MAIN HALL AND CAP. (TYP.). REFER TO

ÈLECTRICAL DWGS FOR

DETAILS.

DUCTWORK, AND DISCHARGE

OUTLET. REFER TO MECHANICAL

CLOAK ROOM

108

TICKET BOOTH

107

104

LOBBY

103

REMOVE EXHAUST -FAN, GRILLES, AND DUCTWORK. REFER TO

MECHANICAL DWGS

FOR DETAILS

RESTORE ALL WOOD

TICKET

WOMEN'S W/R

101

OFFICE 106

WINDOW FRAMES (TYP.).-

SHORE EXISTING DECORATIVE

COLUMNS THAT ARE SUPPORTED ON LANDING SLAB DURING THE DURATION OF THE WORK. REFER TO STRUCRUAL DWGS FOR

DETAILS.

DEMOLISH EXISTING

STAIRS, LANDING,

STRUCRUAL DWGS FOR DETAILS.

_======== ______

______ ______

AND BRICK WALLS. -

PICK-UP

114

HALL

105

ND HD

102

- CLEAN ALL EXISTING WOOD WINDOW FRAMES TO REMOVE DIRT, DEBRIS, AND LOOSE OR PEELING PAINT. SAND AND PREPARE SURFACES TO RECEIVE NEW PAINT.
- CAREFULLY REMOVE EXISTING CAULKING AROUND WINDOW PERIMETERS ON BOTH INTERIOR AND EXTERIOR FACES. CLEAN SURFACES AND PREPARE TO RECEIVE NEW SEALANT.
- 3 INSTALL NEW CONTINUOUS SEALANT AROUND ALL WINDOW PERIMETERS, INTERIOR AND EXTERIOR, TO ENSURE A COMPLETE WEATHER-TIGHT SEAL.
- 4 FILL ALL CRACKS, GAPS, AND MINOR SURFACE DEFECTS IN WOOD FRAMES WITH EXTERIOR-GRADE WOOD FILLER AS REQUIRED. APPLY TWO COATS OF PAINT TO ALL PREPARED WOOD SURFACES. MATCH COLOUR TO EXISTING.
- (5) REPAINT ALL BASEMENT WINDOW CAGES. APPLY TWO COATS OF PAINT, MATCH COLOUR TO EXISTING.
- INSTALL TRADITIONAL VENTED WOOD-FRAMED EXTERIOR STORM WINDOWS AT ALL FIXED WINDOW UNITS TO IMPROVE THERMAL PERFORMANCE AND ENERGY EFFICIENCY.

DEMOLITION NOTES:

ALLOW FOR 23 METERS BY 3 METERS

ABOVE GRADE CONCRETE FOUNDATION

REPAIR/REPARGING ON ALL OF THE

WALL. (TYP.).

2 A2.7

- 1) REPAIR / CUT OUT AND REPOINT EXISTING MASONRY WITH TYPE O
- DEMOLISH AND SALVAGE ALL EXISTING WALL MOUNTED ITEMS INCLUDING BUT NOT LIMITED TO PLAQUES, SIGNAGE, ETC.
- 3 ALL EXISTING FURNITURE, ACOUSTIC CEILING PANELS AND ITEMS TO BE COVERED AND PROTECTED FROM DUST, DEBRIS AND DAMAGE DURING THE COURSE OF CONSTRUCTION.
- PREPARE WALL TO RECEIVE NEW FINISH. PATCH AND REPAIR ALL DAMAGED WALL SURFACES AS REQUIRED PRIOR TO APPLYING NEW

_DEMOLISH EXISTING

EXIT STAIR. REFER

DWGS FOR DETAILS.

TO STRUCTURAL

ALLOW FOR 8 METERS BY 3

ALL OF THE ABOVE GRADE

CONCRETE FOUNDATION WALL.

METERS REPAIR/REPARGING ON

(A4.3

ALLOW FOR 8 METERS BY 3
METERS REPAIR/REPARGING ON

__DEMOLISH EXISTING EXIT STAIR. REFER

DWGS FOR DETAILS.

project no. :

drawing no.:

scale:

1:50

JUNE 2025

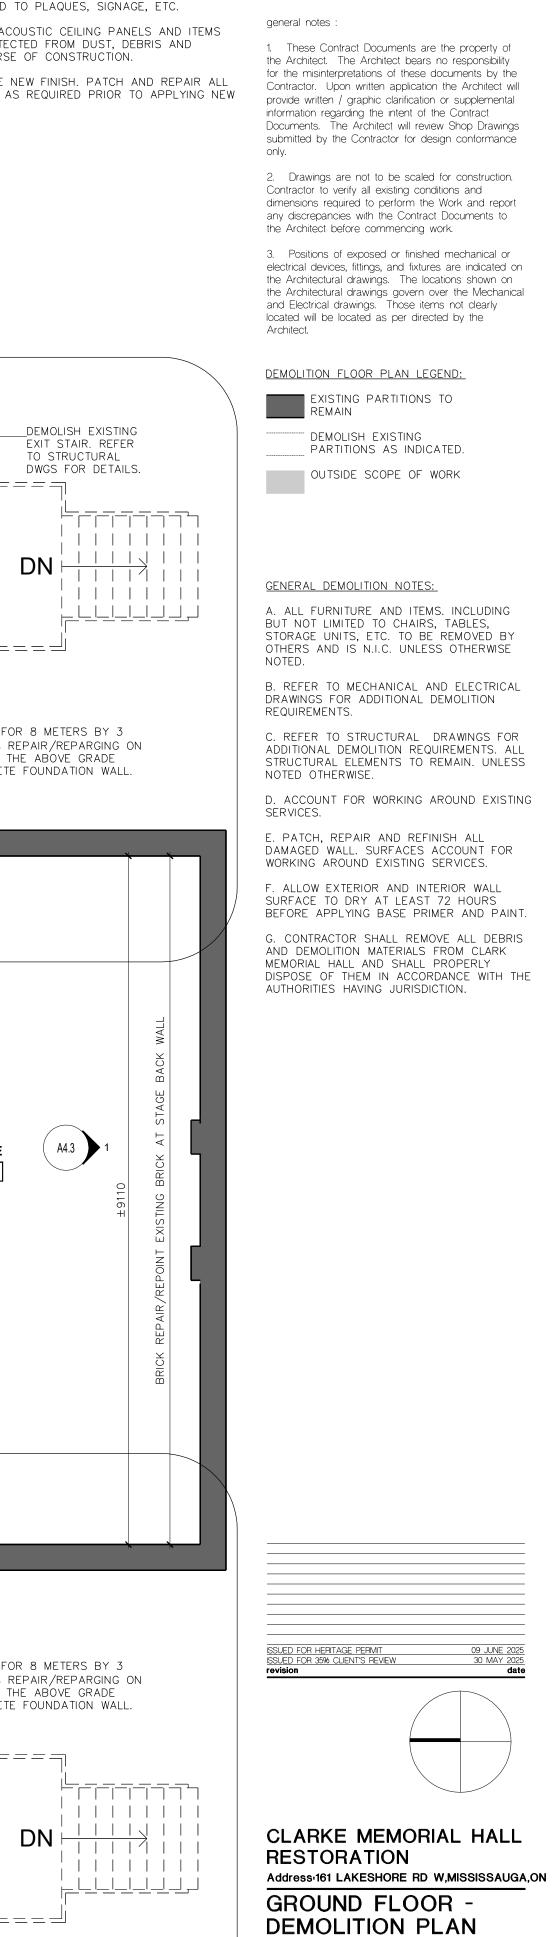
TO STRUCTURAL

ALL OF THE ABOVE GRADE CONCRETE FOUNDATION WALL.

STAGE

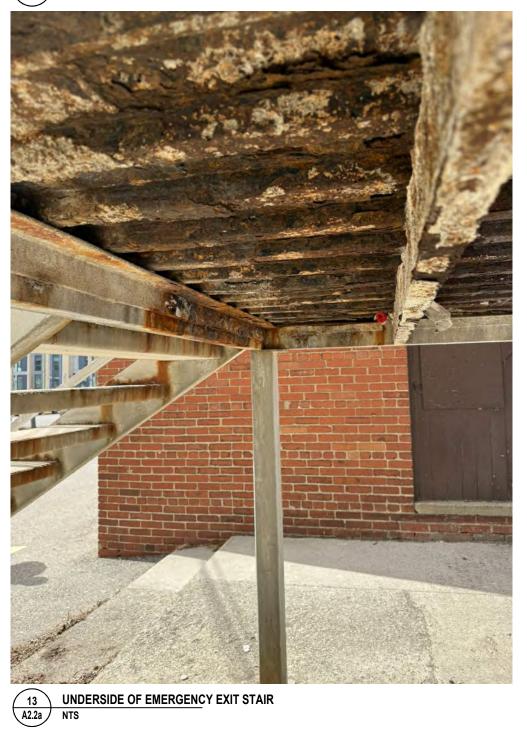
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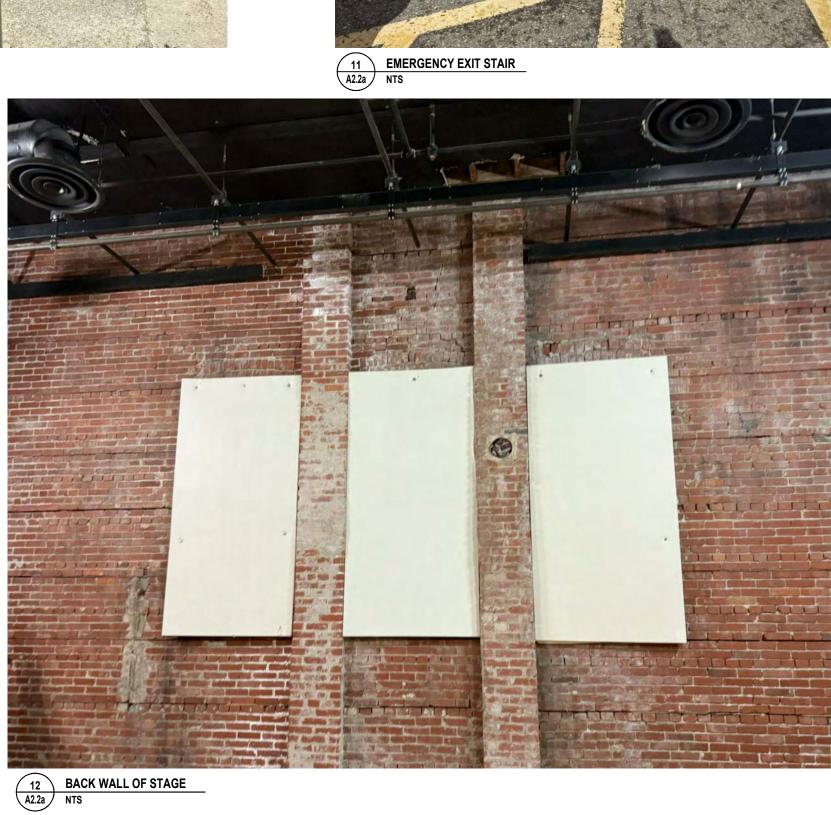
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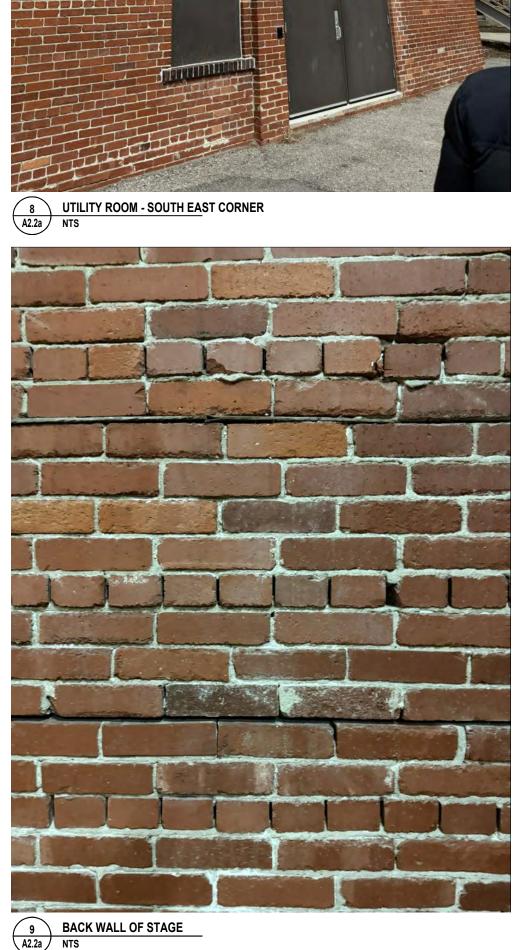







10 EAST ELEVATION - FILLED WINDOWS NTS











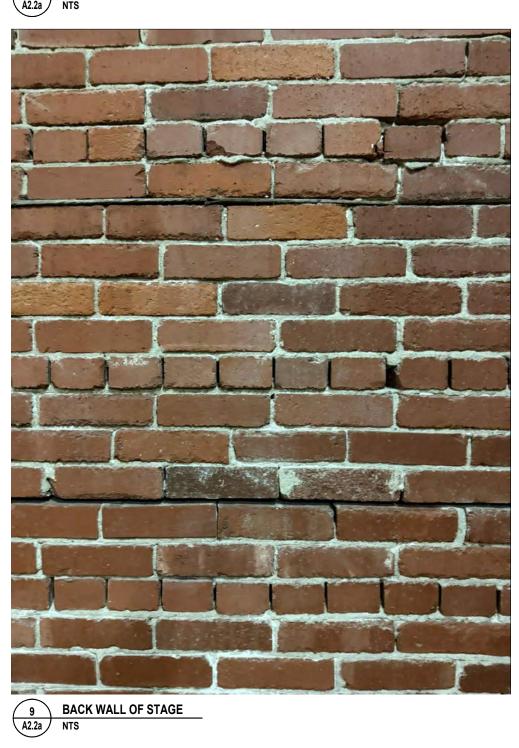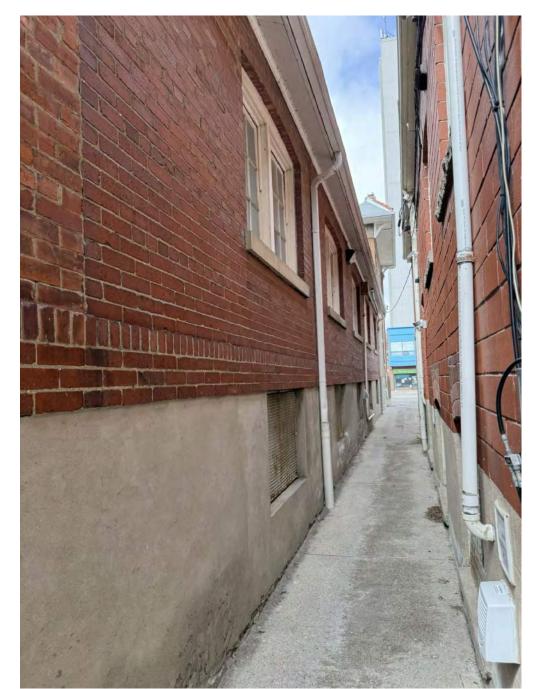





4 EAST ELEVATION NTS



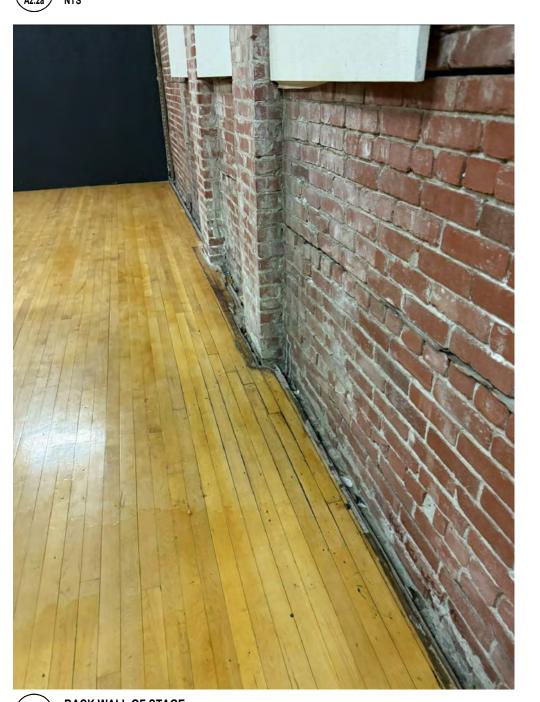

6 BACK WALL OF STAGE
A2.2a NTS

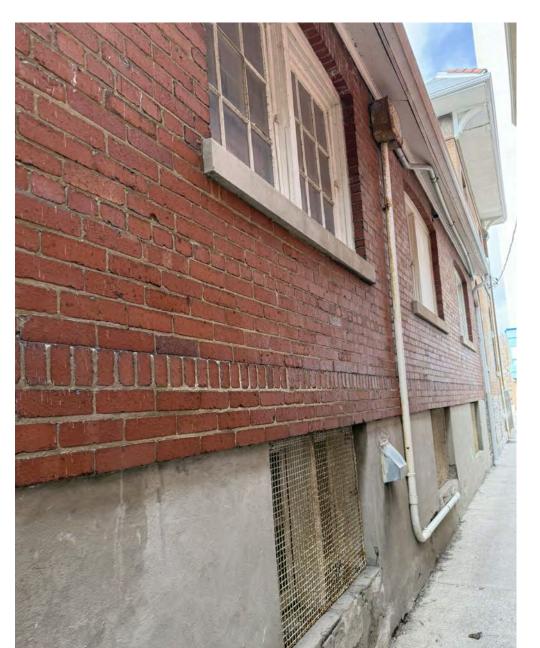

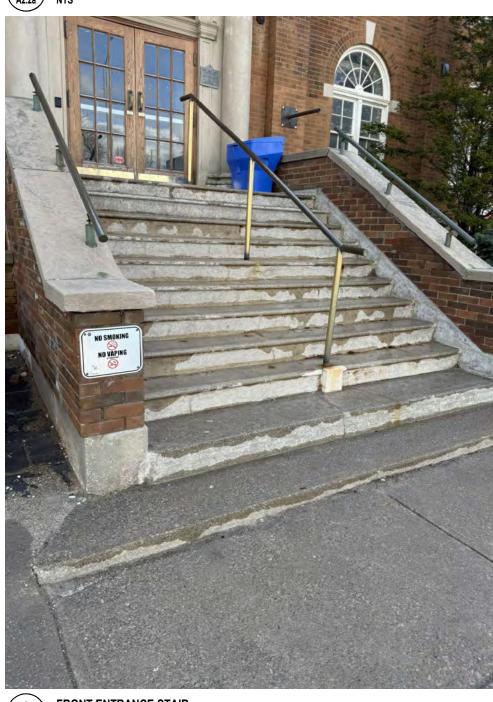



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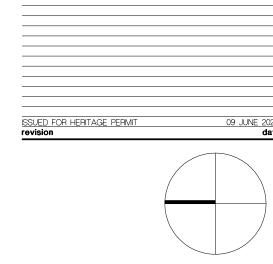
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CLARKE MEMORIAL HALL RESTORATION Address:161 LAKESHORE RD W,MISSISSAUGA,ON GROUND FLOOR -DEMOLITION PLAN PHOTOS

A2.2a

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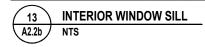
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general notes :



13 INTERIOR WINDOW SILL A2.2b NTS

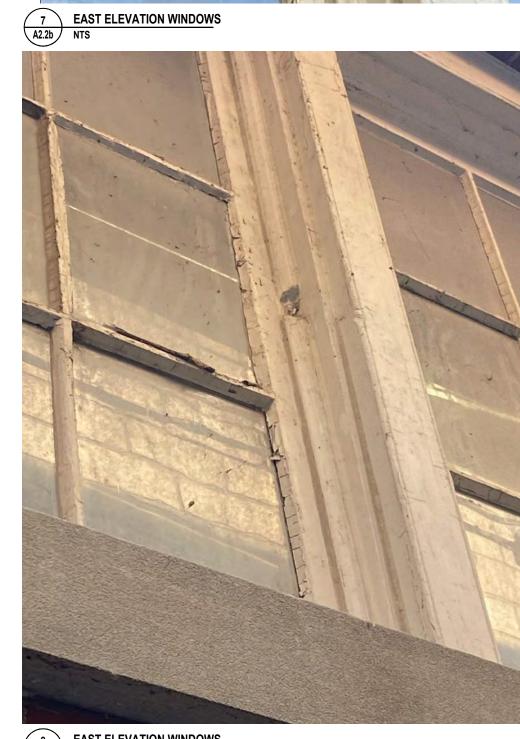


EAST ELEVATION WINDOWS
A2.2b NTS

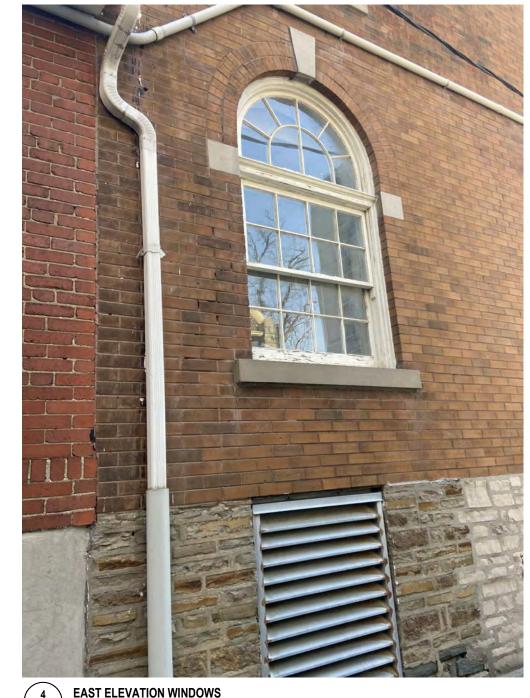


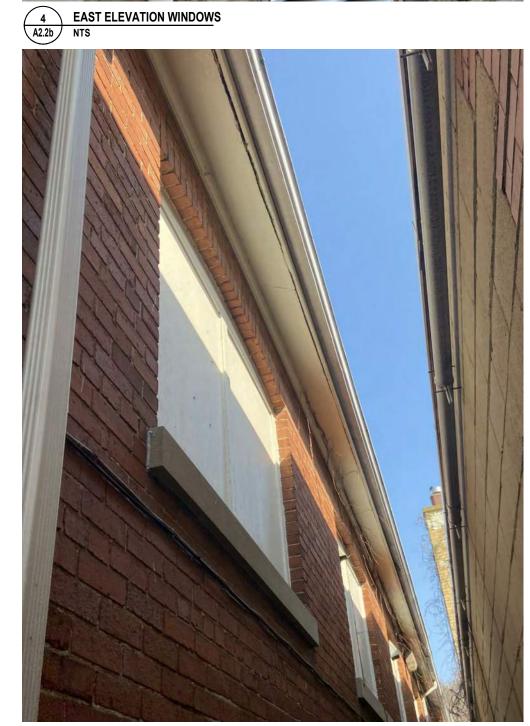








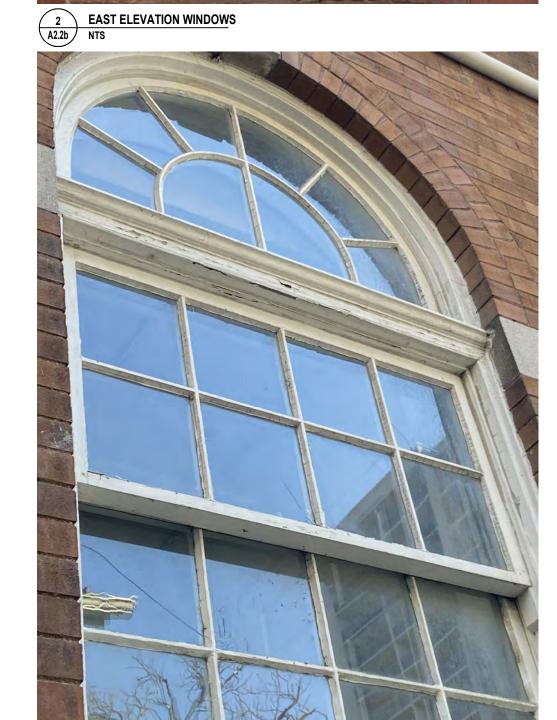














EAST ELEVATION WINDOWS
A2.2b NTS

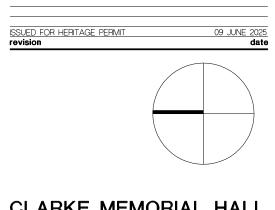

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PHOTOS

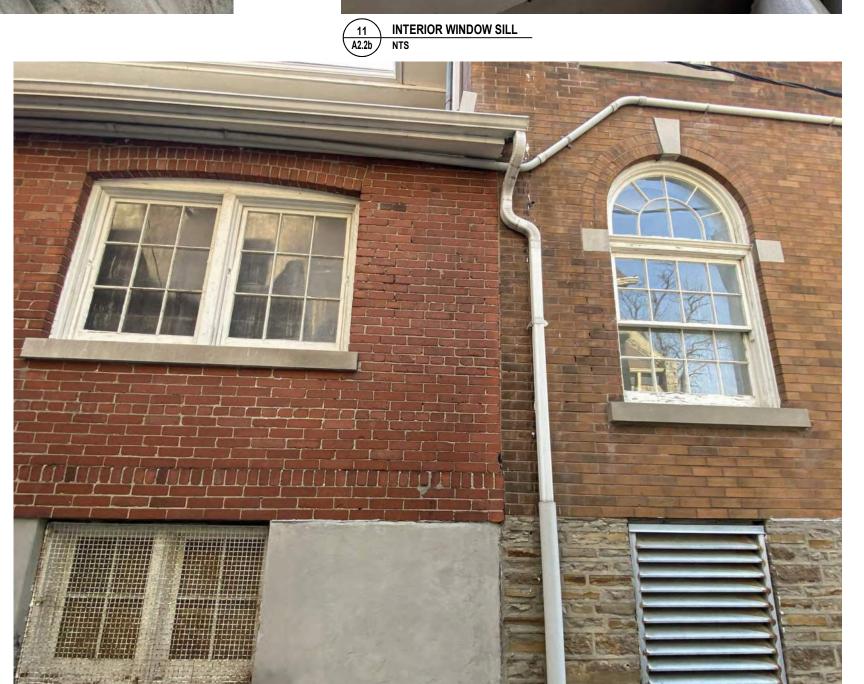



EAST ELEVATION WINDOWS
A2.2b NTS

- CLEAN ALL EXISTING WOOD WINDOW FRAMES TO REMOVE DIRT, DEBRIS, AND LOOSE OR PEELING PAINT. SAND AND PREPARE SURFACES TO RECEIVE NEW PAINT.
- CAREFULLY REMOVE EXISTING CAULKING AROUND WINDOW PERIMETERS ON BOTH INTERIOR AND EXTERIOR FACES. CLEAN SURFACES AND PREPARE TO RECEIVE NEW SEALANT.
- 3 INSTALL NEW CONTINUOUS SEALANT AROUND ALL WINDOW PERIMETERS, INTERIOR AND EXTERIOR, TO ENSURE A COMPLETE WEATHER—TIGHT SEAL.
- FILL ALL CRACKS, GAPS, AND MINOR SURFACE DEFECTS IN WOOD FRAMES WITH EXTERIOR—GRADE WOOD FILLER AS REQUIRED. APPLY TWO COATS OF PAINT TO ALL PREPARED WOOD SURFACES. MATCH COLOUR TO EXISTING.
- REPAINT ALL BASEMENT WINDOW CAGES. APPLY TWO COATS OF PAINT, MATCH COLOUR TO EXISTING.
- 6 INSTALL TRADITIONAL VENTED WOOD-FRAMED EXTERIOR STORM WINDOWS AT ALL FIXED WINDOW UNITS TO IMPROVE THERMAL PERFORMANCE AND ENERGY EFFICIENCY.

WINDOW RESTORATION NOTES :

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t. 416.898.1979

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DEMOLITION FLOOR PLAN LEGEND:

EXISTING PARTITIONS TO REMAIN

 $_$ $_$ PARTITIONS AS INDICATED. OUTSIDE SCOPE OF WORK

GENERAL DEMOLITION NOTES:

- - DEMOLISH EXISTING

A. ALL FURNITURE AND ITEMS. INCLUDING BUT NOT LIMITED TO CHAIRS, TABLES, STORAGE UNITS, ETC. TO BE REMOVED BY OTHERS AND IS N.I.C. UNLESS OTHERWISE B. REFER TO MECHANICAL AND ELECTRICAL DRAWINGS FOR ADDITIONAL DEMOLITION

REQUIREMENTS. C. REFER TO STRUCTURAL DRAWINGS FOR ADDITIONAL DEMOLITION REQUIREMENTS. ALL STRUCTURAL ELEMENTS TO REMAIN. UNLESS

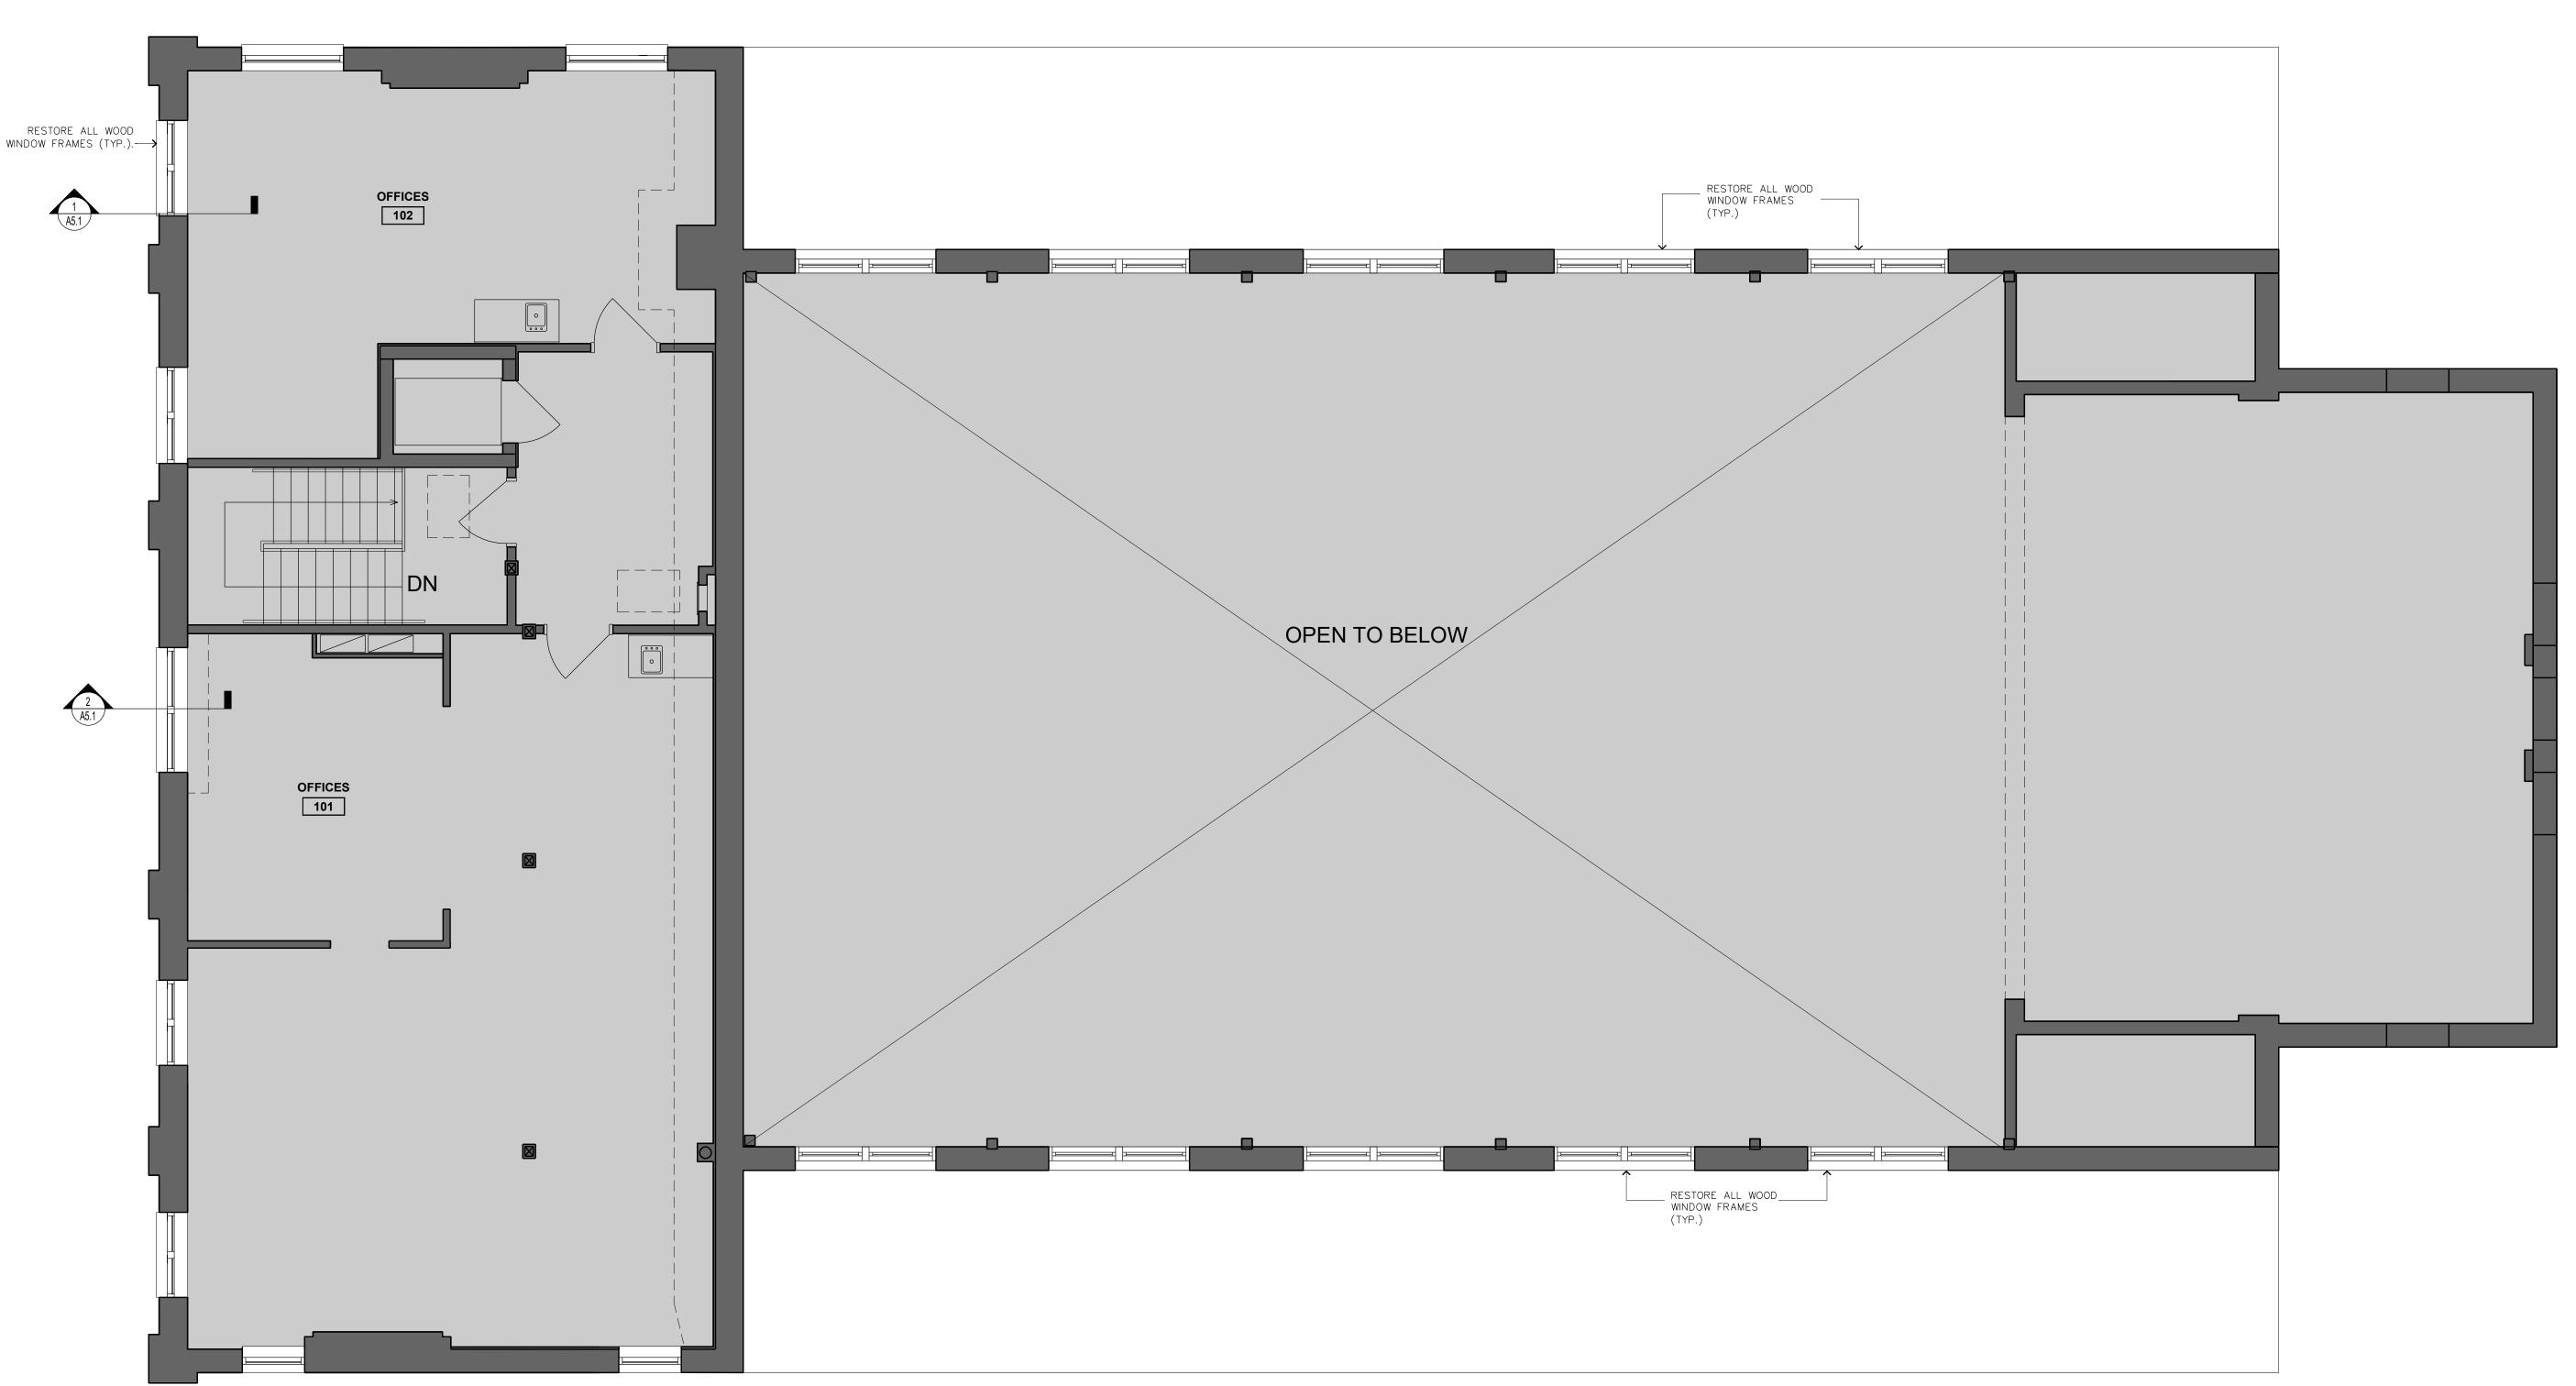
NOTED OTHERWISE.

D. ACCOUNT FOR WORKING AROUND EXISTING

E. PATCH, REPAIR AND REFINISH ALL DAMAGED WALL. SURFACES ACCOUNT FOR WORKING AROUND EXISTING SERVICES. F. ALLOW EXTERIOR AND INTERIOR WALL


SURFACE TO DRY AT LEAST 72 HOURS BEFORE APPLYING BASE PRIMER AND PAINT. G. CONTRACTOR SHALL REMOVE ALL DEBRIS

AND DEMOLITION MATERIALS FROM CLARK MEMORIAL HALL AND SHALL PROPERLY DISPOSE OF THEM IN ACCORDANCE WITH THE AUTHORITIES HAVING JURISDICTION.



CLARKE MEMORIAL HALL RESTORATION Address:161 LAKESHORE RD W,MISSISSAUGA,ON SECOND FLOOR -**DEMOLITION PLAN**

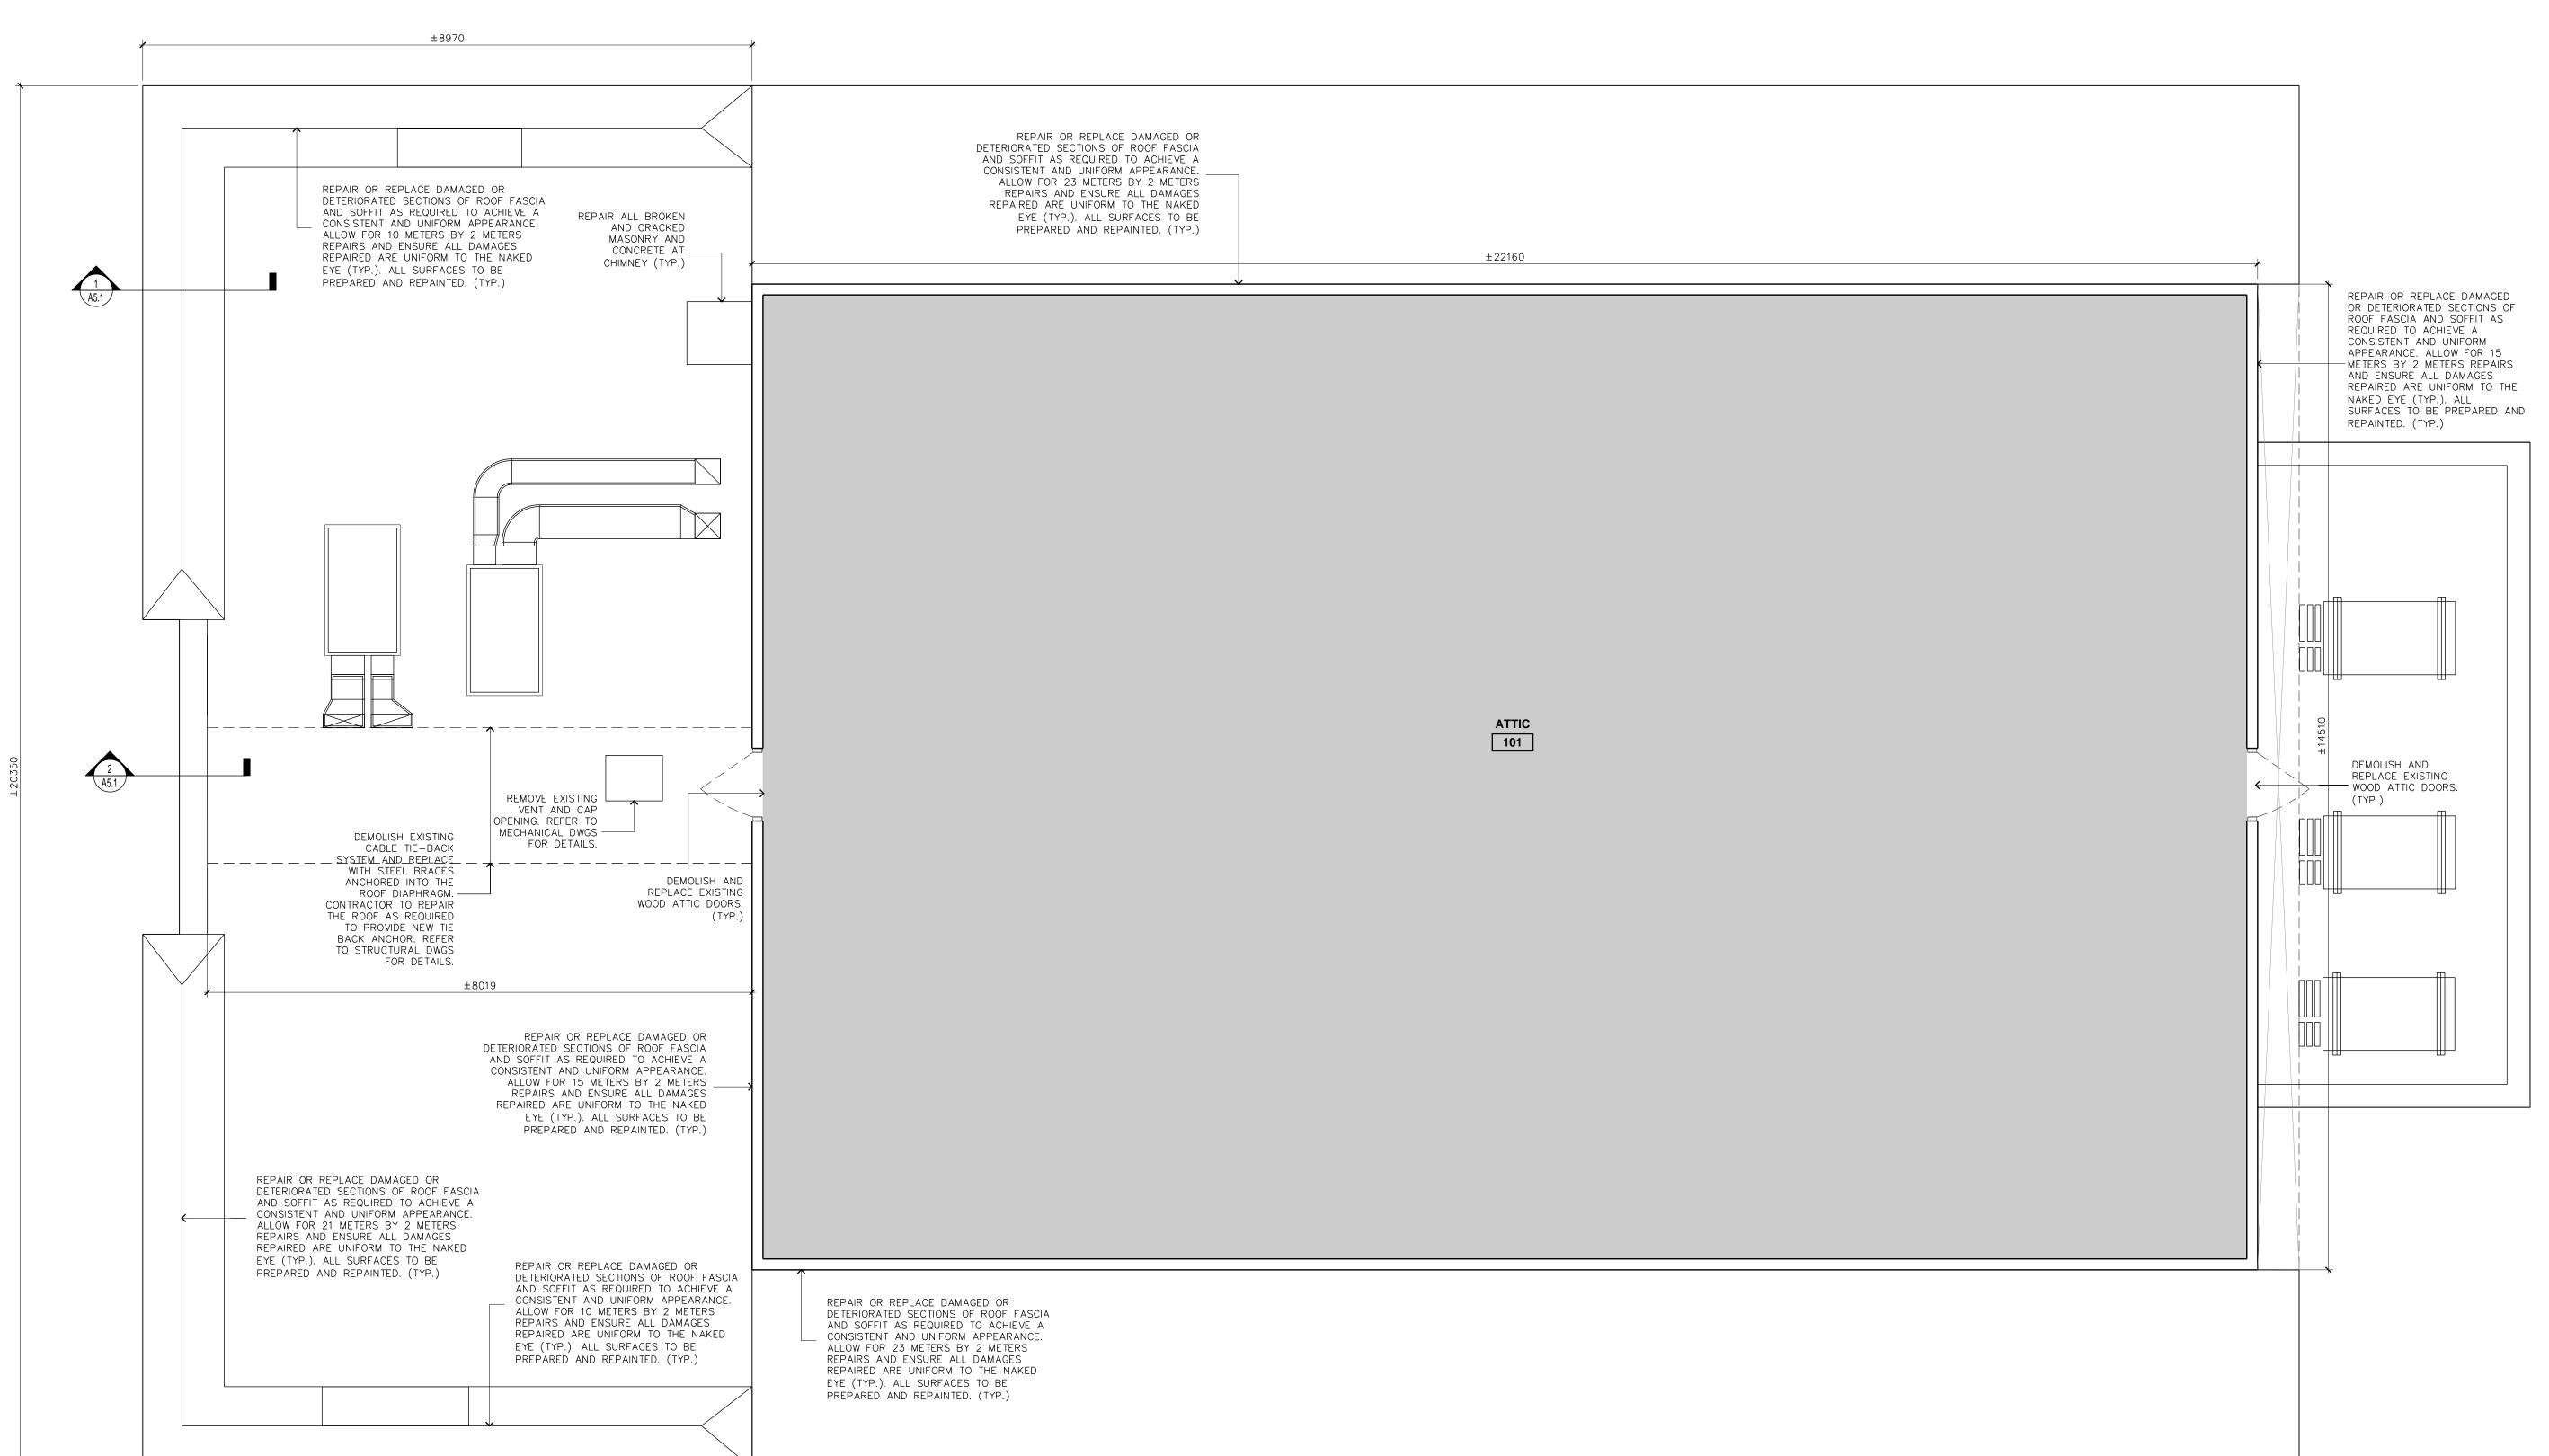project no. : 1:50 scale: JUNE 2025



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DEMOLITION FLOOR PLAN LEGEND:

EXISTING PARTITIONS TO REMAIN

- - DEMOLISH EXISTING

_ _ _ PARTITIONS AS INDICATED. OUTSIDE SCOPE OF WORK

GENERAL DEMOLITION NOTES:

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B. REFER TO MECHANICAL AND ELECTRICAL DRAWINGS FOR ADDITIONAL DEMOLITION REQUIREMENTS.

C. REFER TO STRUCTURAL DRAWINGS FOR

ADDITIONAL DEMOLITION REQUIREMENTS. ALL STRUCTURAL ELEMENTS TO REMAIN. UNLESS NOTED OTHERWISE. D. ACCOUNT FOR WORKING AROUND EXISTING

E. PATCH, REPAIR AND REFINISH ALL DAMAGED WALL. SURFACES ACCOUNT FOR

WORKING AROUND EXISTING SERVICES. F. ALLOW EXTERIOR AND INTERIOR WALL

SURFACE TO DRY AT LEAST 72 HOURS BEFORE APPLYING BASE PRIMER AND PAINT. G. CONTRACTOR SHALL REMOVE ALL DEBRIS

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ISSUED FOR HERITAGE PERMIT ISSUED FOR 35% CLIENT'S REVIEW

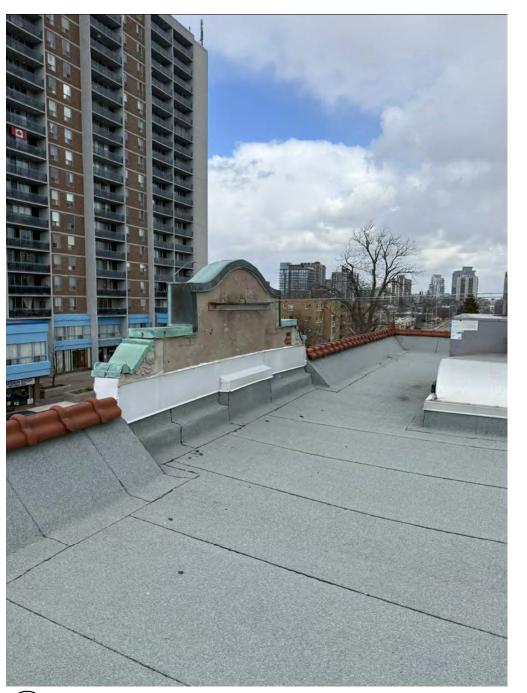


RESTORATION Address:161 LAKESHORE RD W,MISSISSAUGA,ON ATTIC -**DEMOLITION PLAN**

project no. : 1:50 scale: JUNE 2025


drawing no.:


general notes :



13 FLAT ROOF GUY WIRES
A2.4a NTS



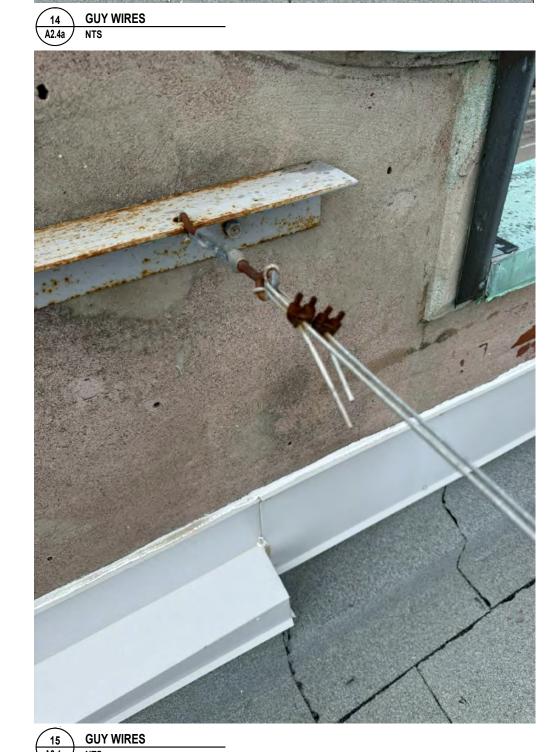

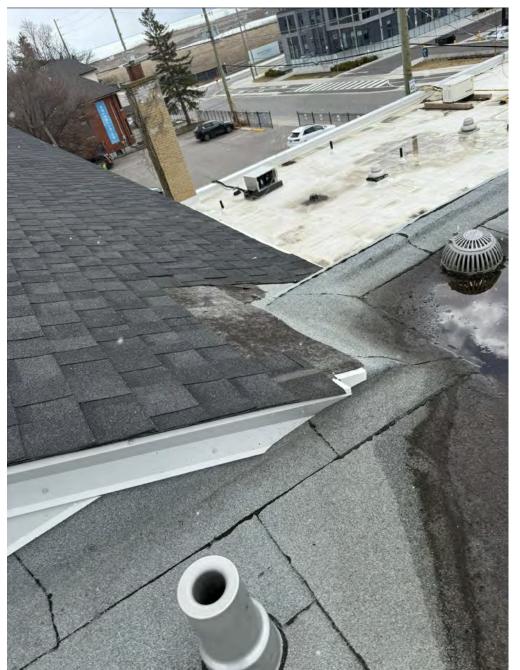










A-ROOF FASCIA
A2.4a NTS

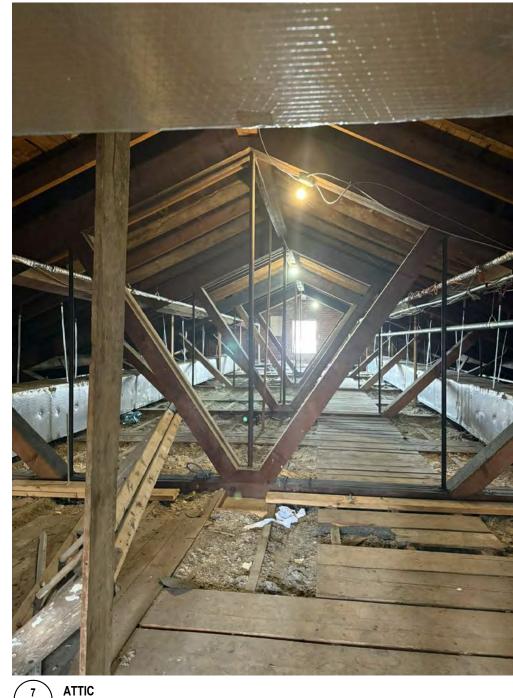




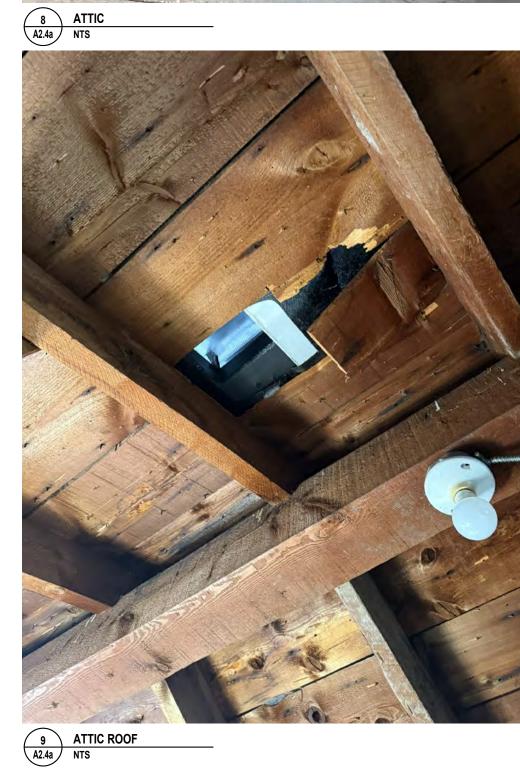

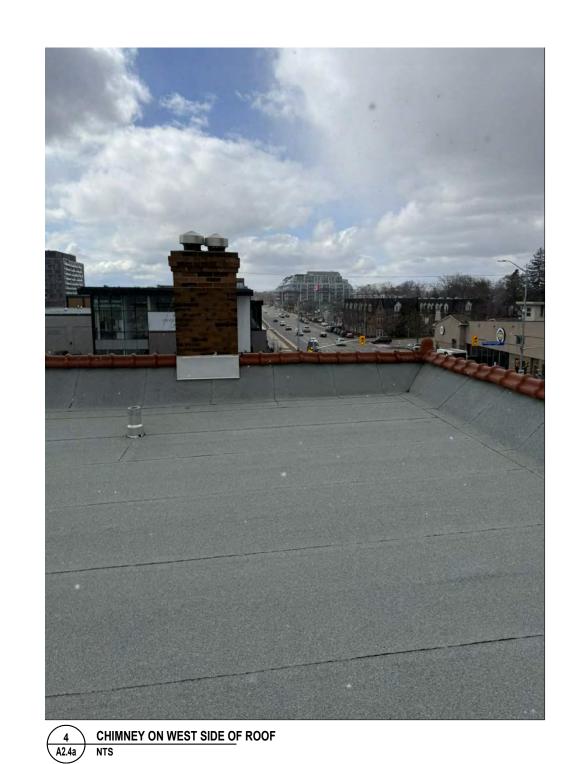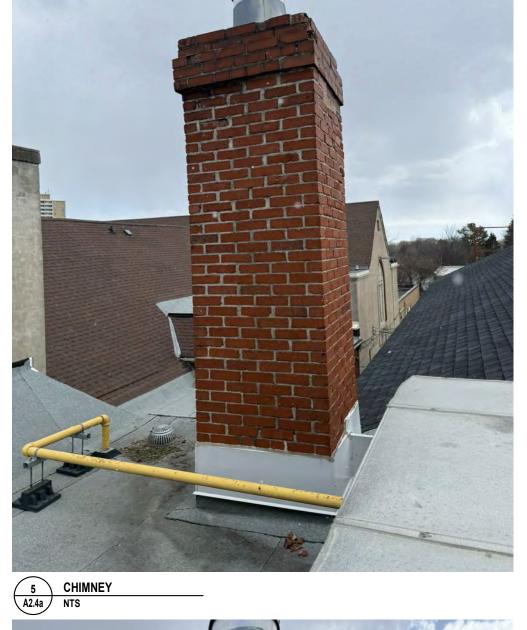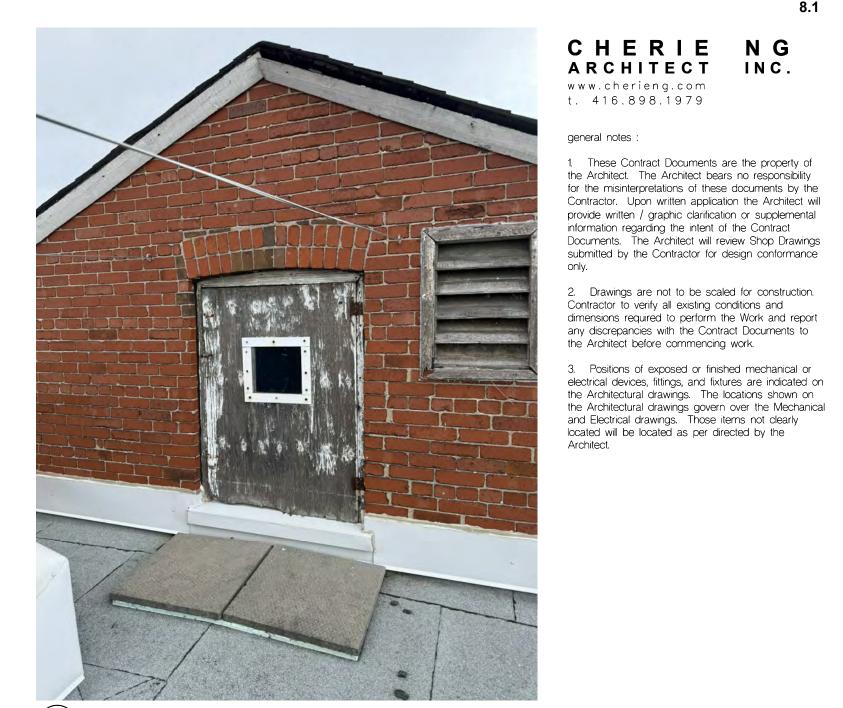














1 ATTIC DOOR A2.4a NTS

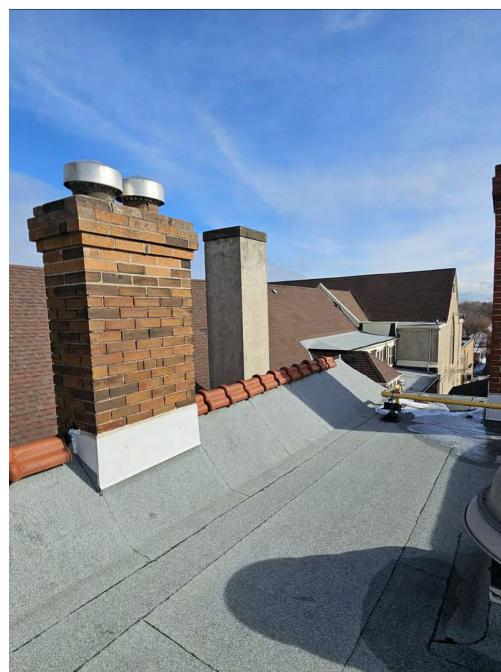


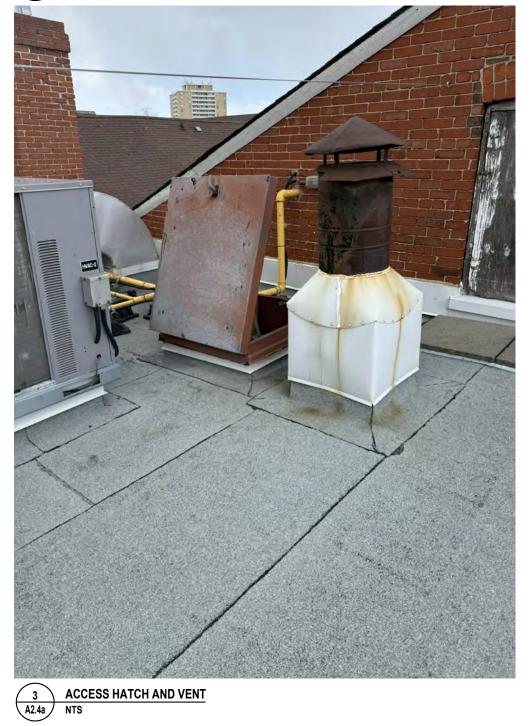2 CHIMNEY ON EAST SIDE OF ROOF
A2.4a NTS



SSUED FOR HERITAGE PERMIT

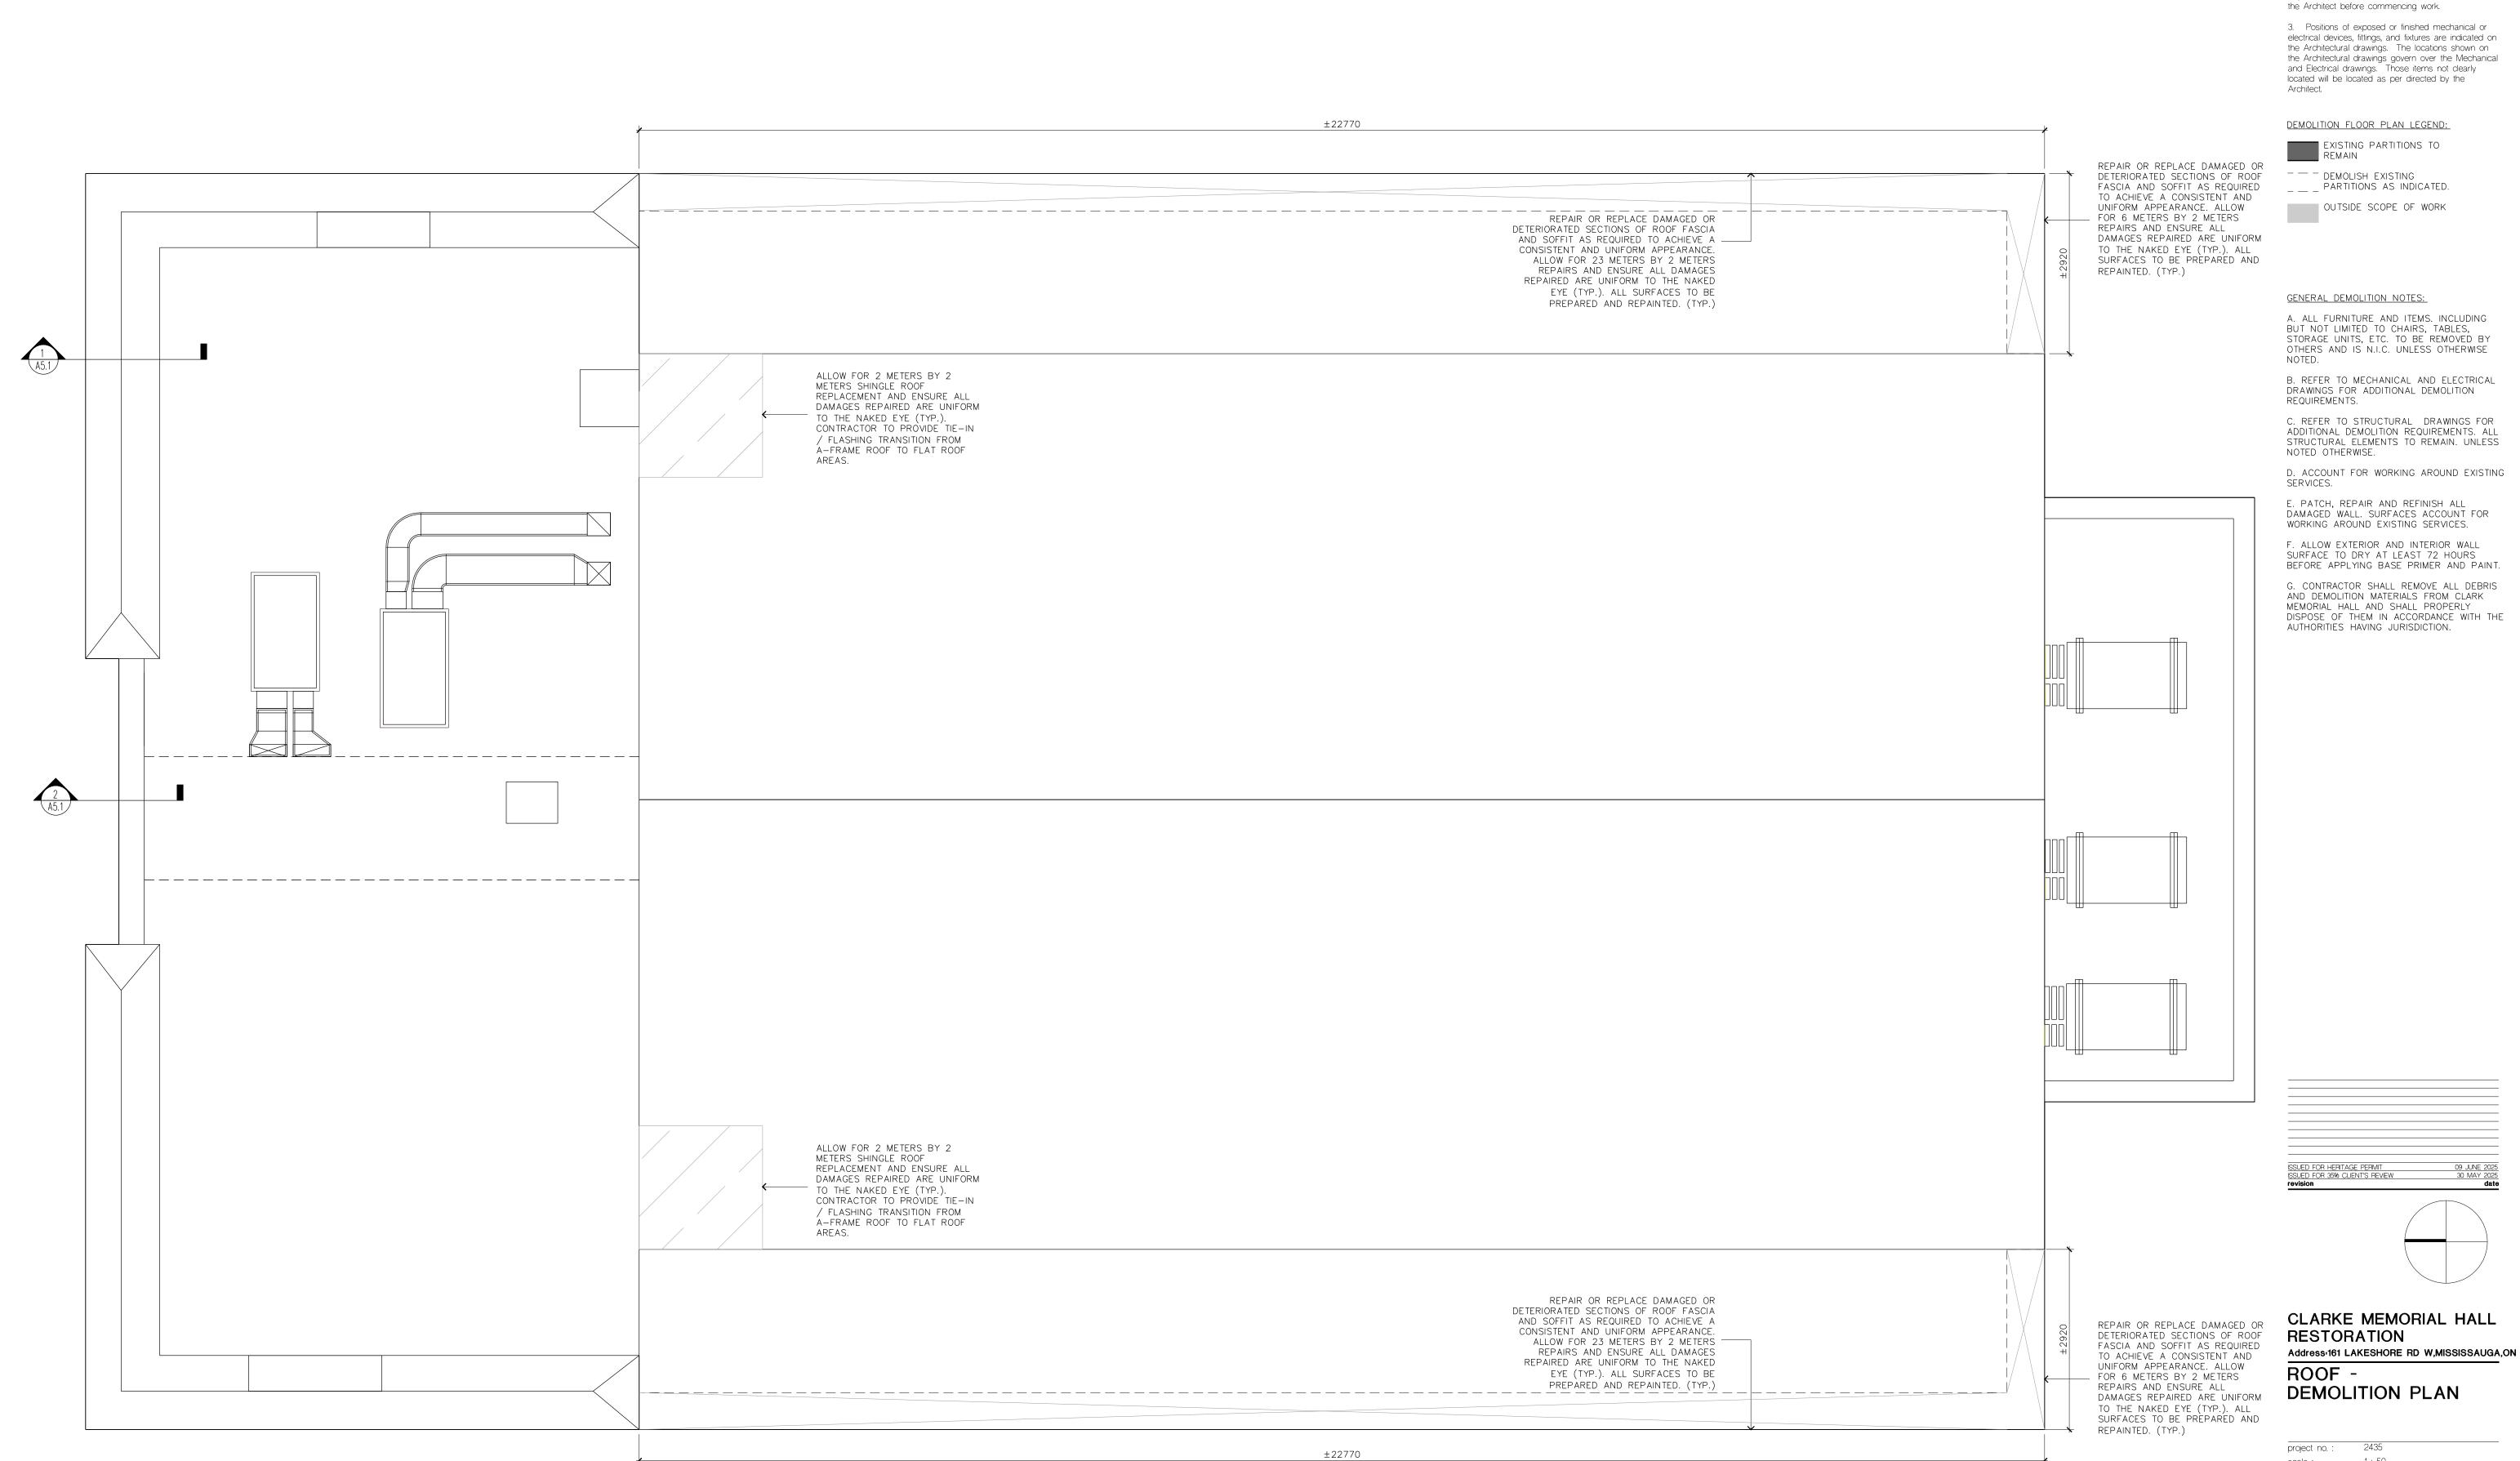CLARKE MEMORIAL HALL
RESTORATION
Address-161 LAKESHORE RD W,MISSISSAUGA,ON
ATTIC DEMOLITION PLAN
PHOTOS



CHERIE NG ARCHITECT INC.

www.cherieng.com

general notes :

t. 416.898.1979

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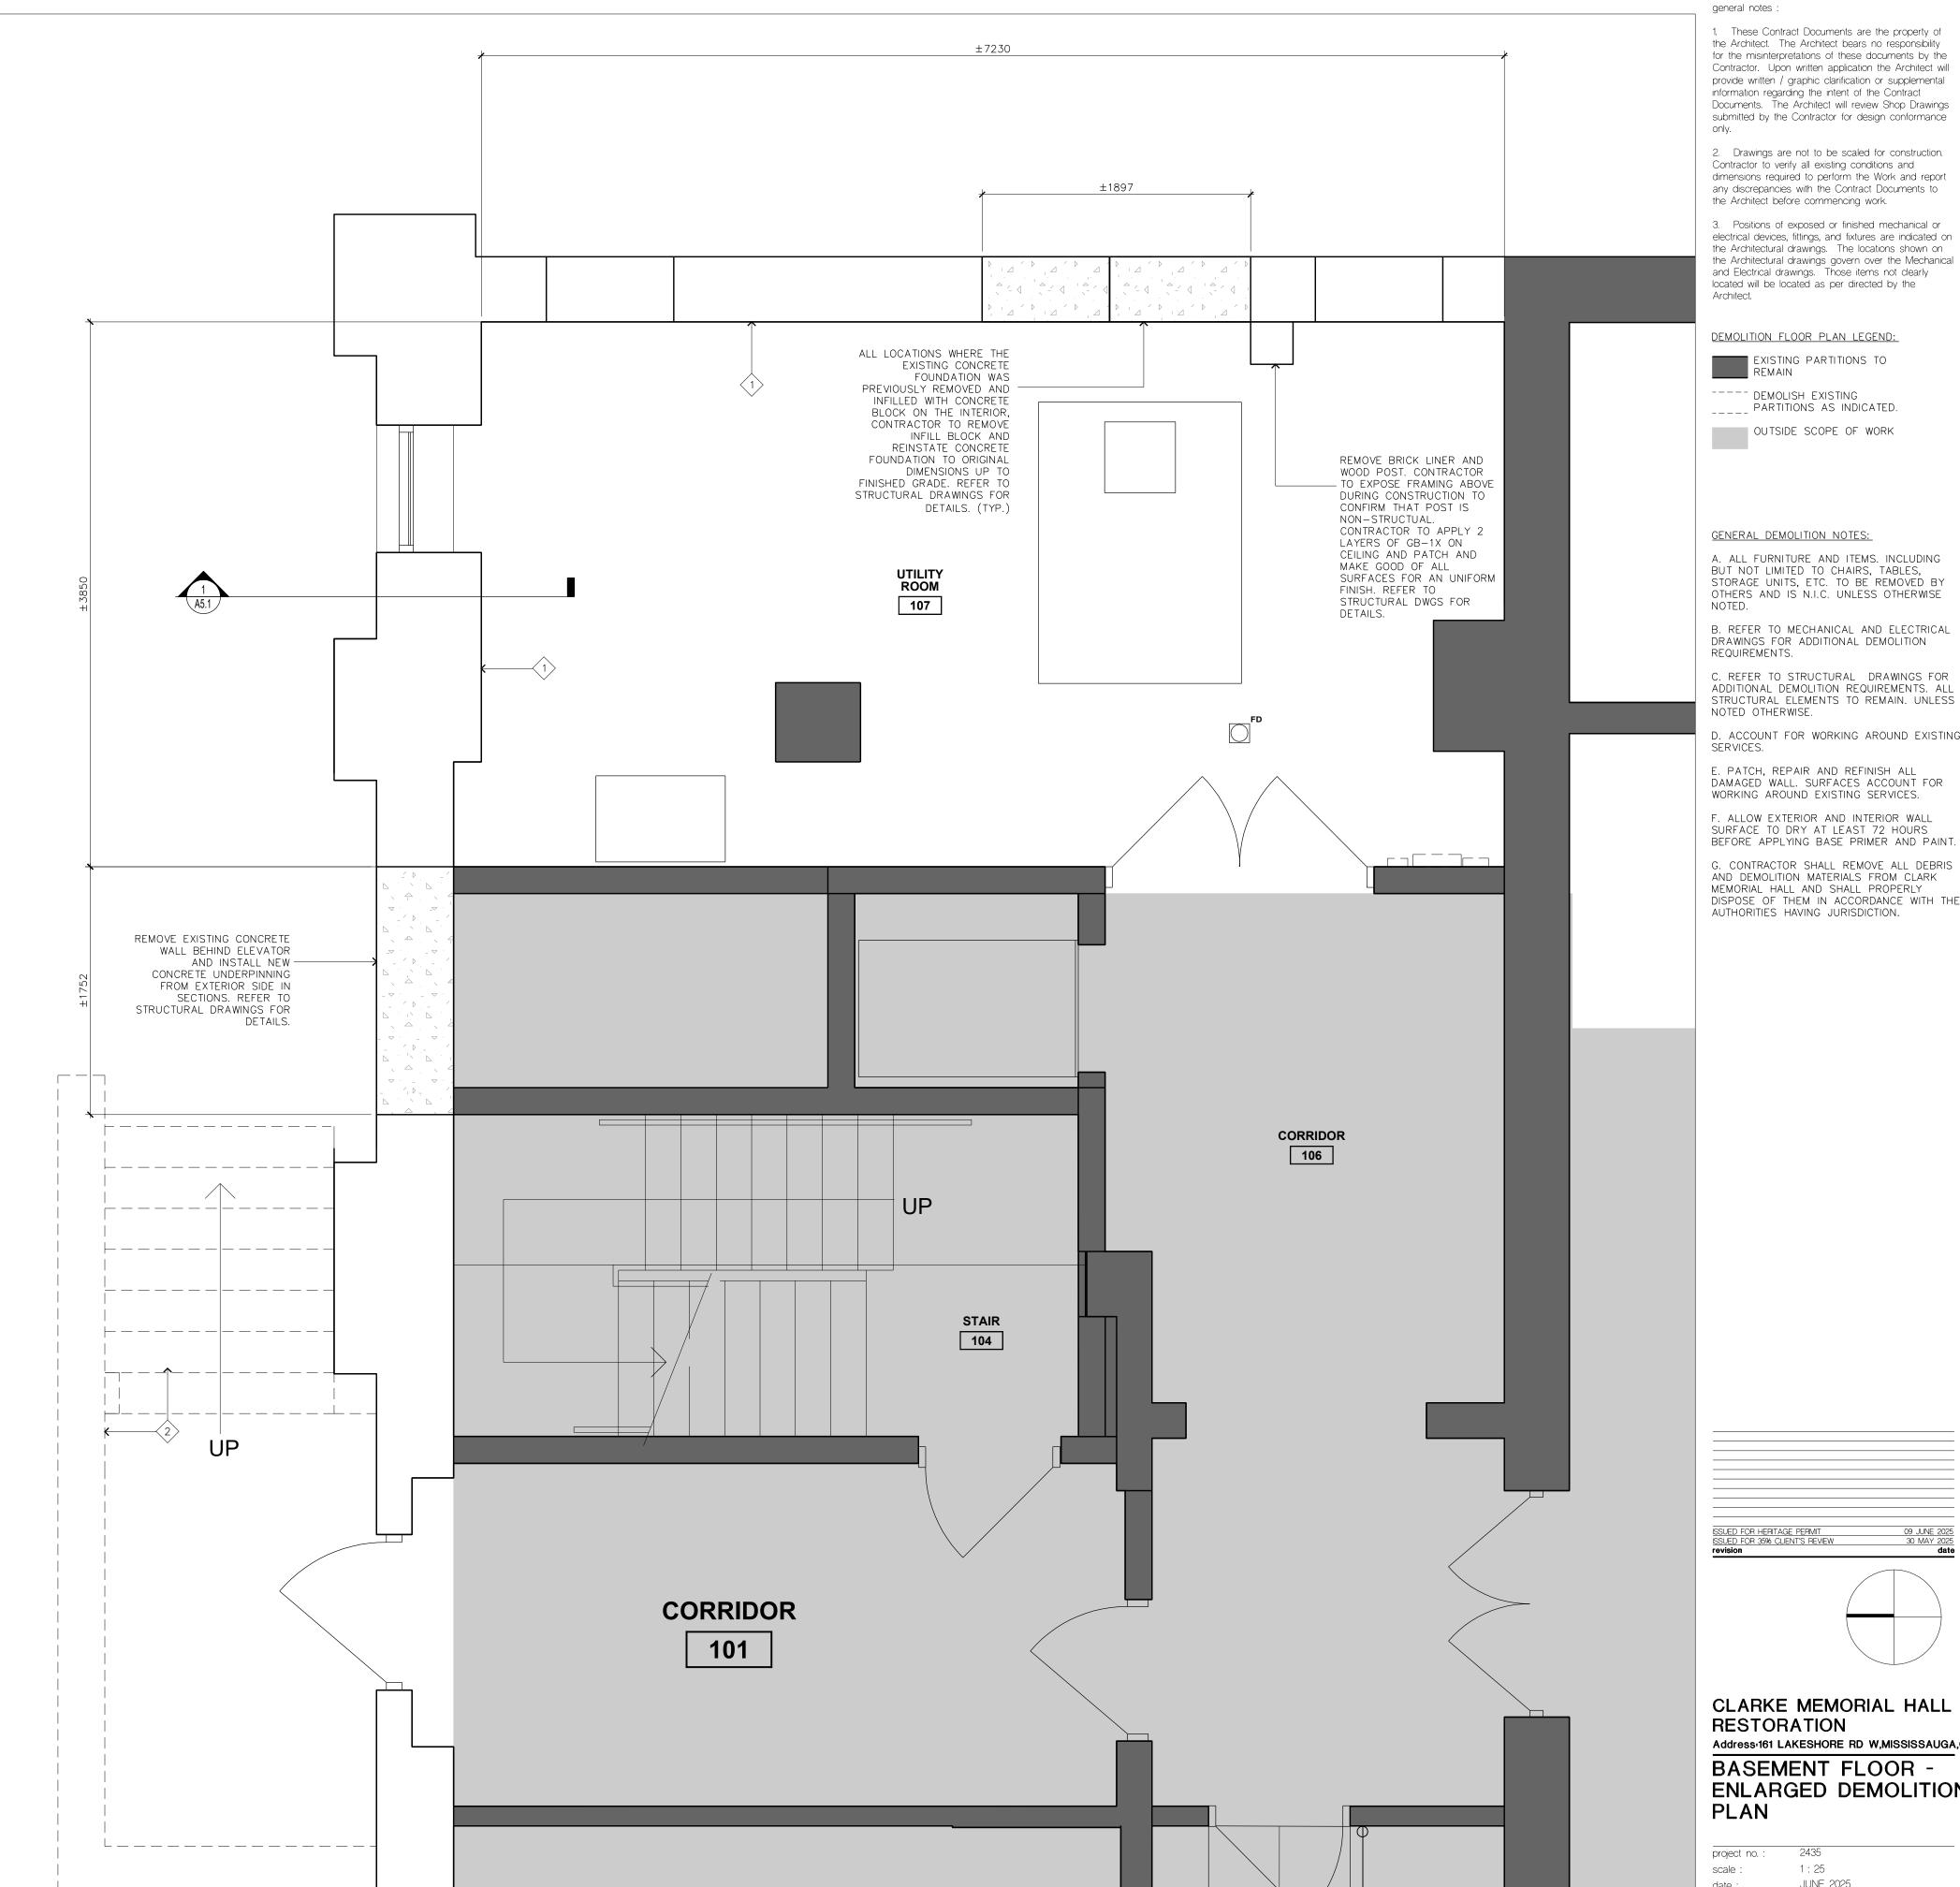
2. Drawings are not to be scaled for construction. Contractor to verify all existing conditions and dimensions required to perform the Work and report any discrepancies with the Contract Documents to

1:50 scale: JUNE 2025

drawing no.:

DEMOLITION NOTES:

- ALL LOCATIONS WHERE THE CONCRETE FOUNDATION IS DETERIORATED, REPAIR WORK TO INCLUDE:
 - EXCAVATION OF FOUNDATION TO BOTTOM OF WALL ON EXTERIOR - ABRASIVE BRUSHING ON CONCRETE FOUNDATION TO REMOVE ALL LOOSE FRIABLE MATERIAL
 - POURING A 150 mm REINFORCED CONCRETE WALL ON BOTH SIDES OF FOUNDATION, TYING THROUGH WALL ON REGULAR PATTERN TO TIE NEW CONCRETE WALLS TOGETHER
- INSTALLING NEW WATERPROOFING AND DRAINAGE ON EXTERIOR REFER TO STRUCTURAL DWGS FOR DETAILS AND EXTENT OF WORK.
- DEMOLISH EXISTING PARTITIONS AND STAIRS AS INDICATED. MAKE GOOD ALL RETAINED PORTIONS OF PARTITIONS, PATCH AND MAKE GOOD OF DAMAGED SURFACES.
- DEMOLISH AND SALVAGE ALL EXISTING WALL MOUNTED ITEMS INCLUDING BUT NOT LIMITED TO PLAQUES, SIGNAGE, ETC.
- 4 ALL EXISTING FURNITURE, ACOUSTIC CEILING PANELS AND ITEMS TO BE COVERED AND PROTECTED FROM DUST, DEBRIS AND DAMAGE DURING THE COURSE OF CONSTRUCTION.
- PREPARE WALL TO RECEIVE NEW FINISH. PATCH AND REPAIR ALL DAMAGED WALL SURFACES AS REQUIRED PRIOR TO APPLYING NEW PAINT FINISH.



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DEMOLITION FLOOR PLAN LEGEND:

EXISTING PARTITIONS TO REMAIN ---- DEMOLISH EXISTING

PARTITIONS AS INDICATED.

OUTSIDE SCOPE OF WORK

GENERAL DEMOLITION NOTES:

A. ALL FURNITURE AND ITEMS. INCLUDING BUT NOT LIMITED TO CHAIRS, TABLES, STORAGE UNITS, ETC. TO BE REMOVED BY OTHERS AND IS N.I.C. UNLESS OTHERWISE

REQUIREMENTS. C. REFER TO STRUCTURAL DRAWINGS FOR

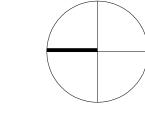
ADDITIONAL DEMOLITION REQUIREMENTS. ALL STRUCTURAL ELEMENTS TO REMAIN. UNLESS NOTED OTHERWISE. . ACCOUNT FOR WORKING AROUND EXISTING

E. PATCH, REPAIR AND REFINISH ALL DAMAGED WALL. SURFACES ACCOUNT FOR WORKING AROUND EXISTING SERVICES.

F. ALLOW EXTERIOR AND INTERIOR WALL SURFACE TO DRY AT LEAST 72 HOURS

BEFORE APPLYING BASE PRIMER AND PAINT. G. CONTRACTOR SHALL REMOVE ALL DEBRIS

AND DEMOLITION MATERIALS FROM CLARK MEMORIAL HALL AND SHALL PROPERLY DISPOSE OF THEM IN ACCORDANCE WITH THE AUTHORITIES HAVING JURISDICTION.



CLARKE MEMORIAL HALL RESTORATION Address-161 LAKESHORE RD W,MISSISSAUGA,ON BASEMENT FLOOR -**ENLARGED DEMOLITION**


1:25

JUNE 2025 drawing no.:

A2.6

DEMOLISH EXISTING EXIT STAIR. REFER TO STRUCTURAL DWGS FOR DETAILS. DN | | | | | | | | | | ______ ±1750 ±3640

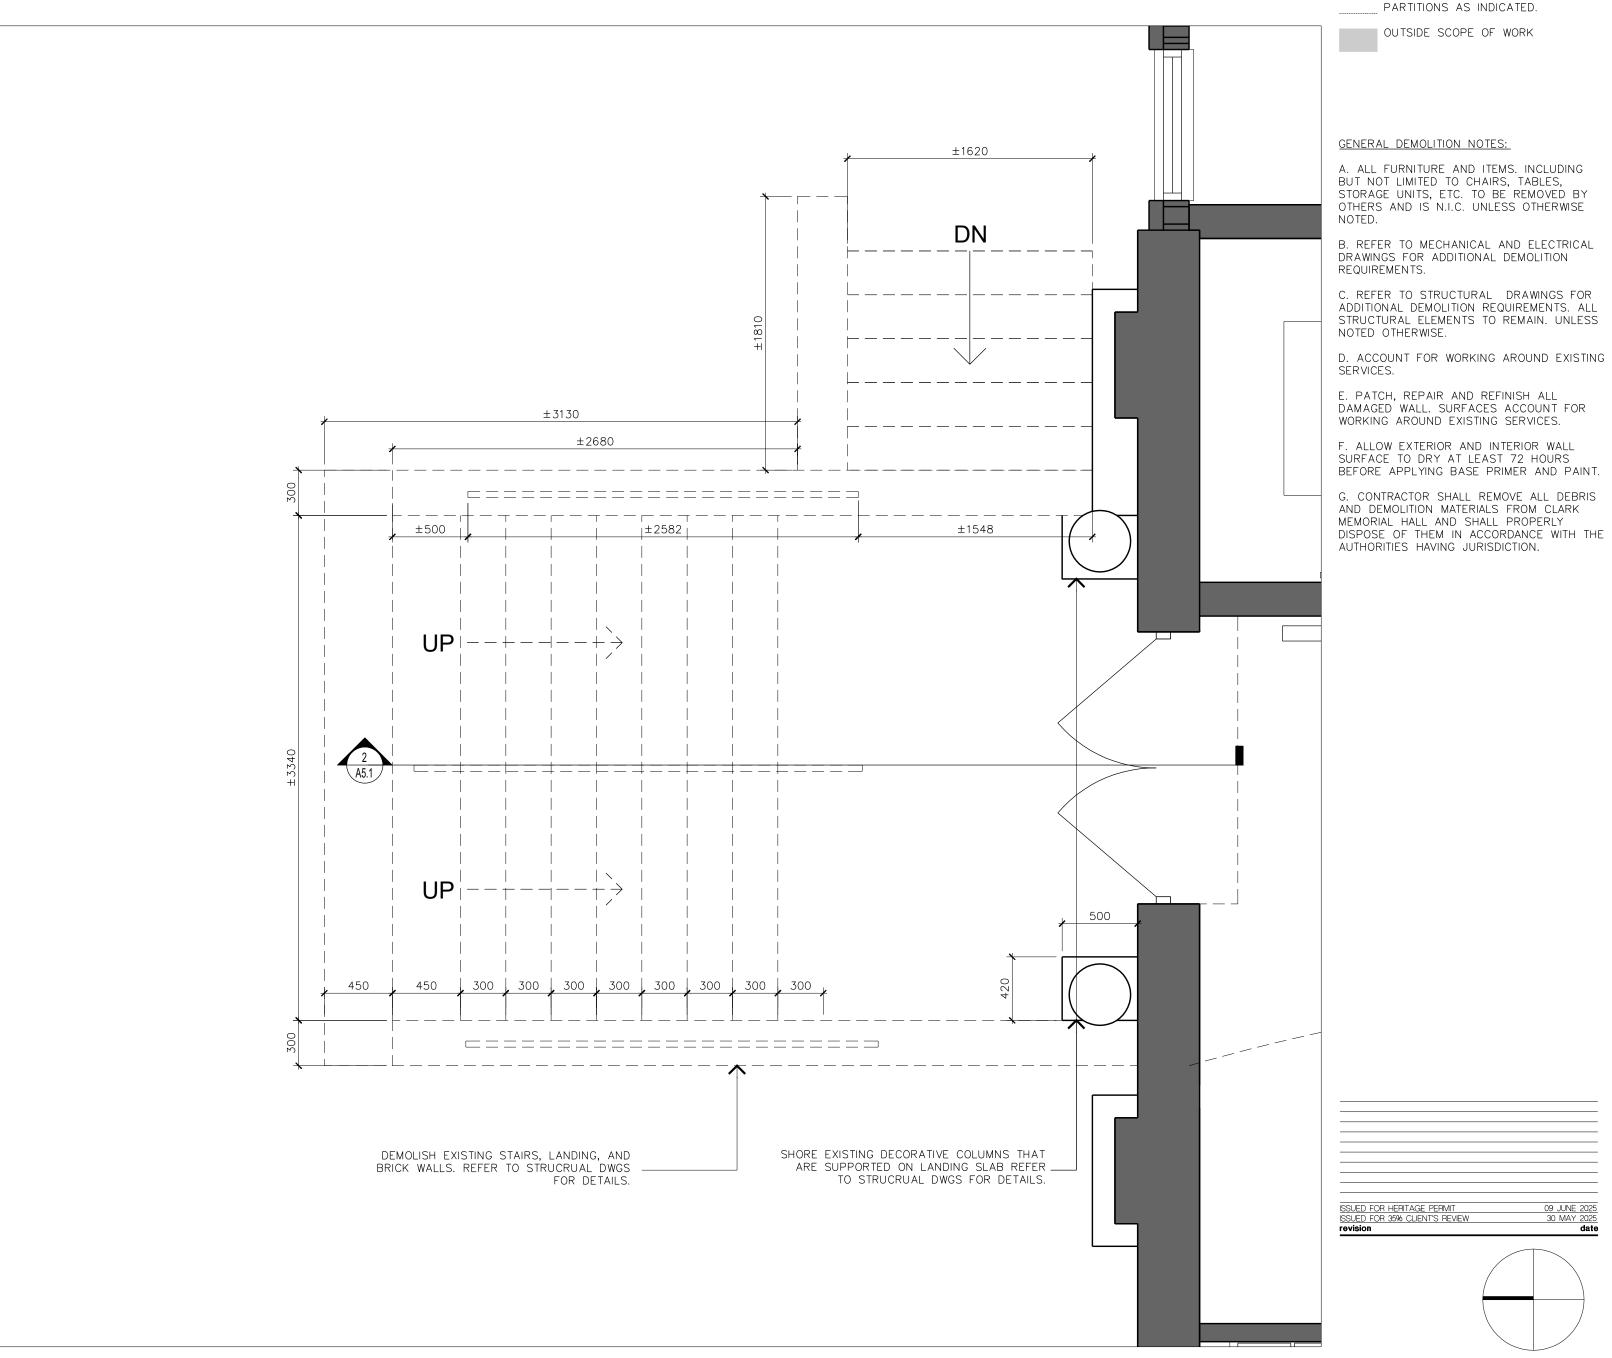2 EMERGENCY STAIR - ENLARGED PLAN 1:25



1 ENTRANCE STAIR - ENLARGED PLAN 1:25

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DEMOLITION FLOOR PLAN LEGEND:

EXISTING PARTITIONS TO REMAIN

DEMOLISH EXISTING
PARTITIONS AS INDICATED.

OUTSIDE SCOPE OF WORK

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C. REFER TO STRUCTURAL DRAWINGS FOR ADDITIONAL DEMOLITION REQUIREMENTS. ALL STRUCTURAL ELEMENTS TO REMAIN. UNLESS NOTED OTHERWISE.

E. PATCH, REPAIR AND REFINISH ALL DAMAGED WALL. SURFACES ACCOUNT FOR WORKING AROUND EXISTING SERVICES. F. ALLOW EXTERIOR AND INTERIOR WALL

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G. CONTRACTOR SHALL REMOVE ALL DEBRIS
AND DEMOLITION MATERIALS FROM CLARK
MEMORIAL HALL AND SHALL PROPERLY
DISPOSE OF THEM IN ACCORDANCE WITH THE AUTHORITIES HAVING JURISDICTION.

CLARKE MEMORIAL HALL RESTORATION

Address:161 LAKESHORE RD W,MISSISSAUGA,ON GROUND FLOOR -ENLARGED DEMOLITION PLAN

project no. : 1:25 scale: JUNE 2025

drawing no.:



EXISTING LOUVRE TO

REMAIN. REFER TO MECHANICAL DWGS FOR DETAILS

DUCTOWRK. PROVIDE NEW DUCTWORK

FROM DISCHARGE TO WEATHER HOOD. REFER TO MECHANICAL DWGS FOR DETAILS.

CHERIE NG ARCHITECT INC.

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FLOOR PLAN LEGEND:

EXISTING WALL/PARTITION TO REMAIN

OUTSIDE SCOPE OF WORK

GENERAL FLOOR PLAN NOTES:

A. PATCH AND MAKE GOOD OF ALL MATERIALS AND SURFACES.

B. CLEARLY CUT AND DEMO EXISTING WALLS AND PATCH AND MAKE GOOD OF ALL REMAINING WALLS FOR A SMOOTH UNIFORM FINISH. PROVIDE FULL SIZE CONCRETE BLOCKS INSERTS FOR AN UNIFORM WALL

C. PATCH ALL HOLES AT CEILING WITH MATCHING ADJACENT MATERIAL

D. PAINT ALL PREVIOUSLY PAINTED SURFACES. TYPICAL FOR ALL INTERIOR AND EXTERIOR SURFACE. ALLOW FOR 6 PAINT COLOURS (4 DARK COLOURS AND 2 LIGHT COLOURS)

SSUED FOR HERITAGE PERMIT ISSUED FOR 35% CLIENT'S REVIEW revision

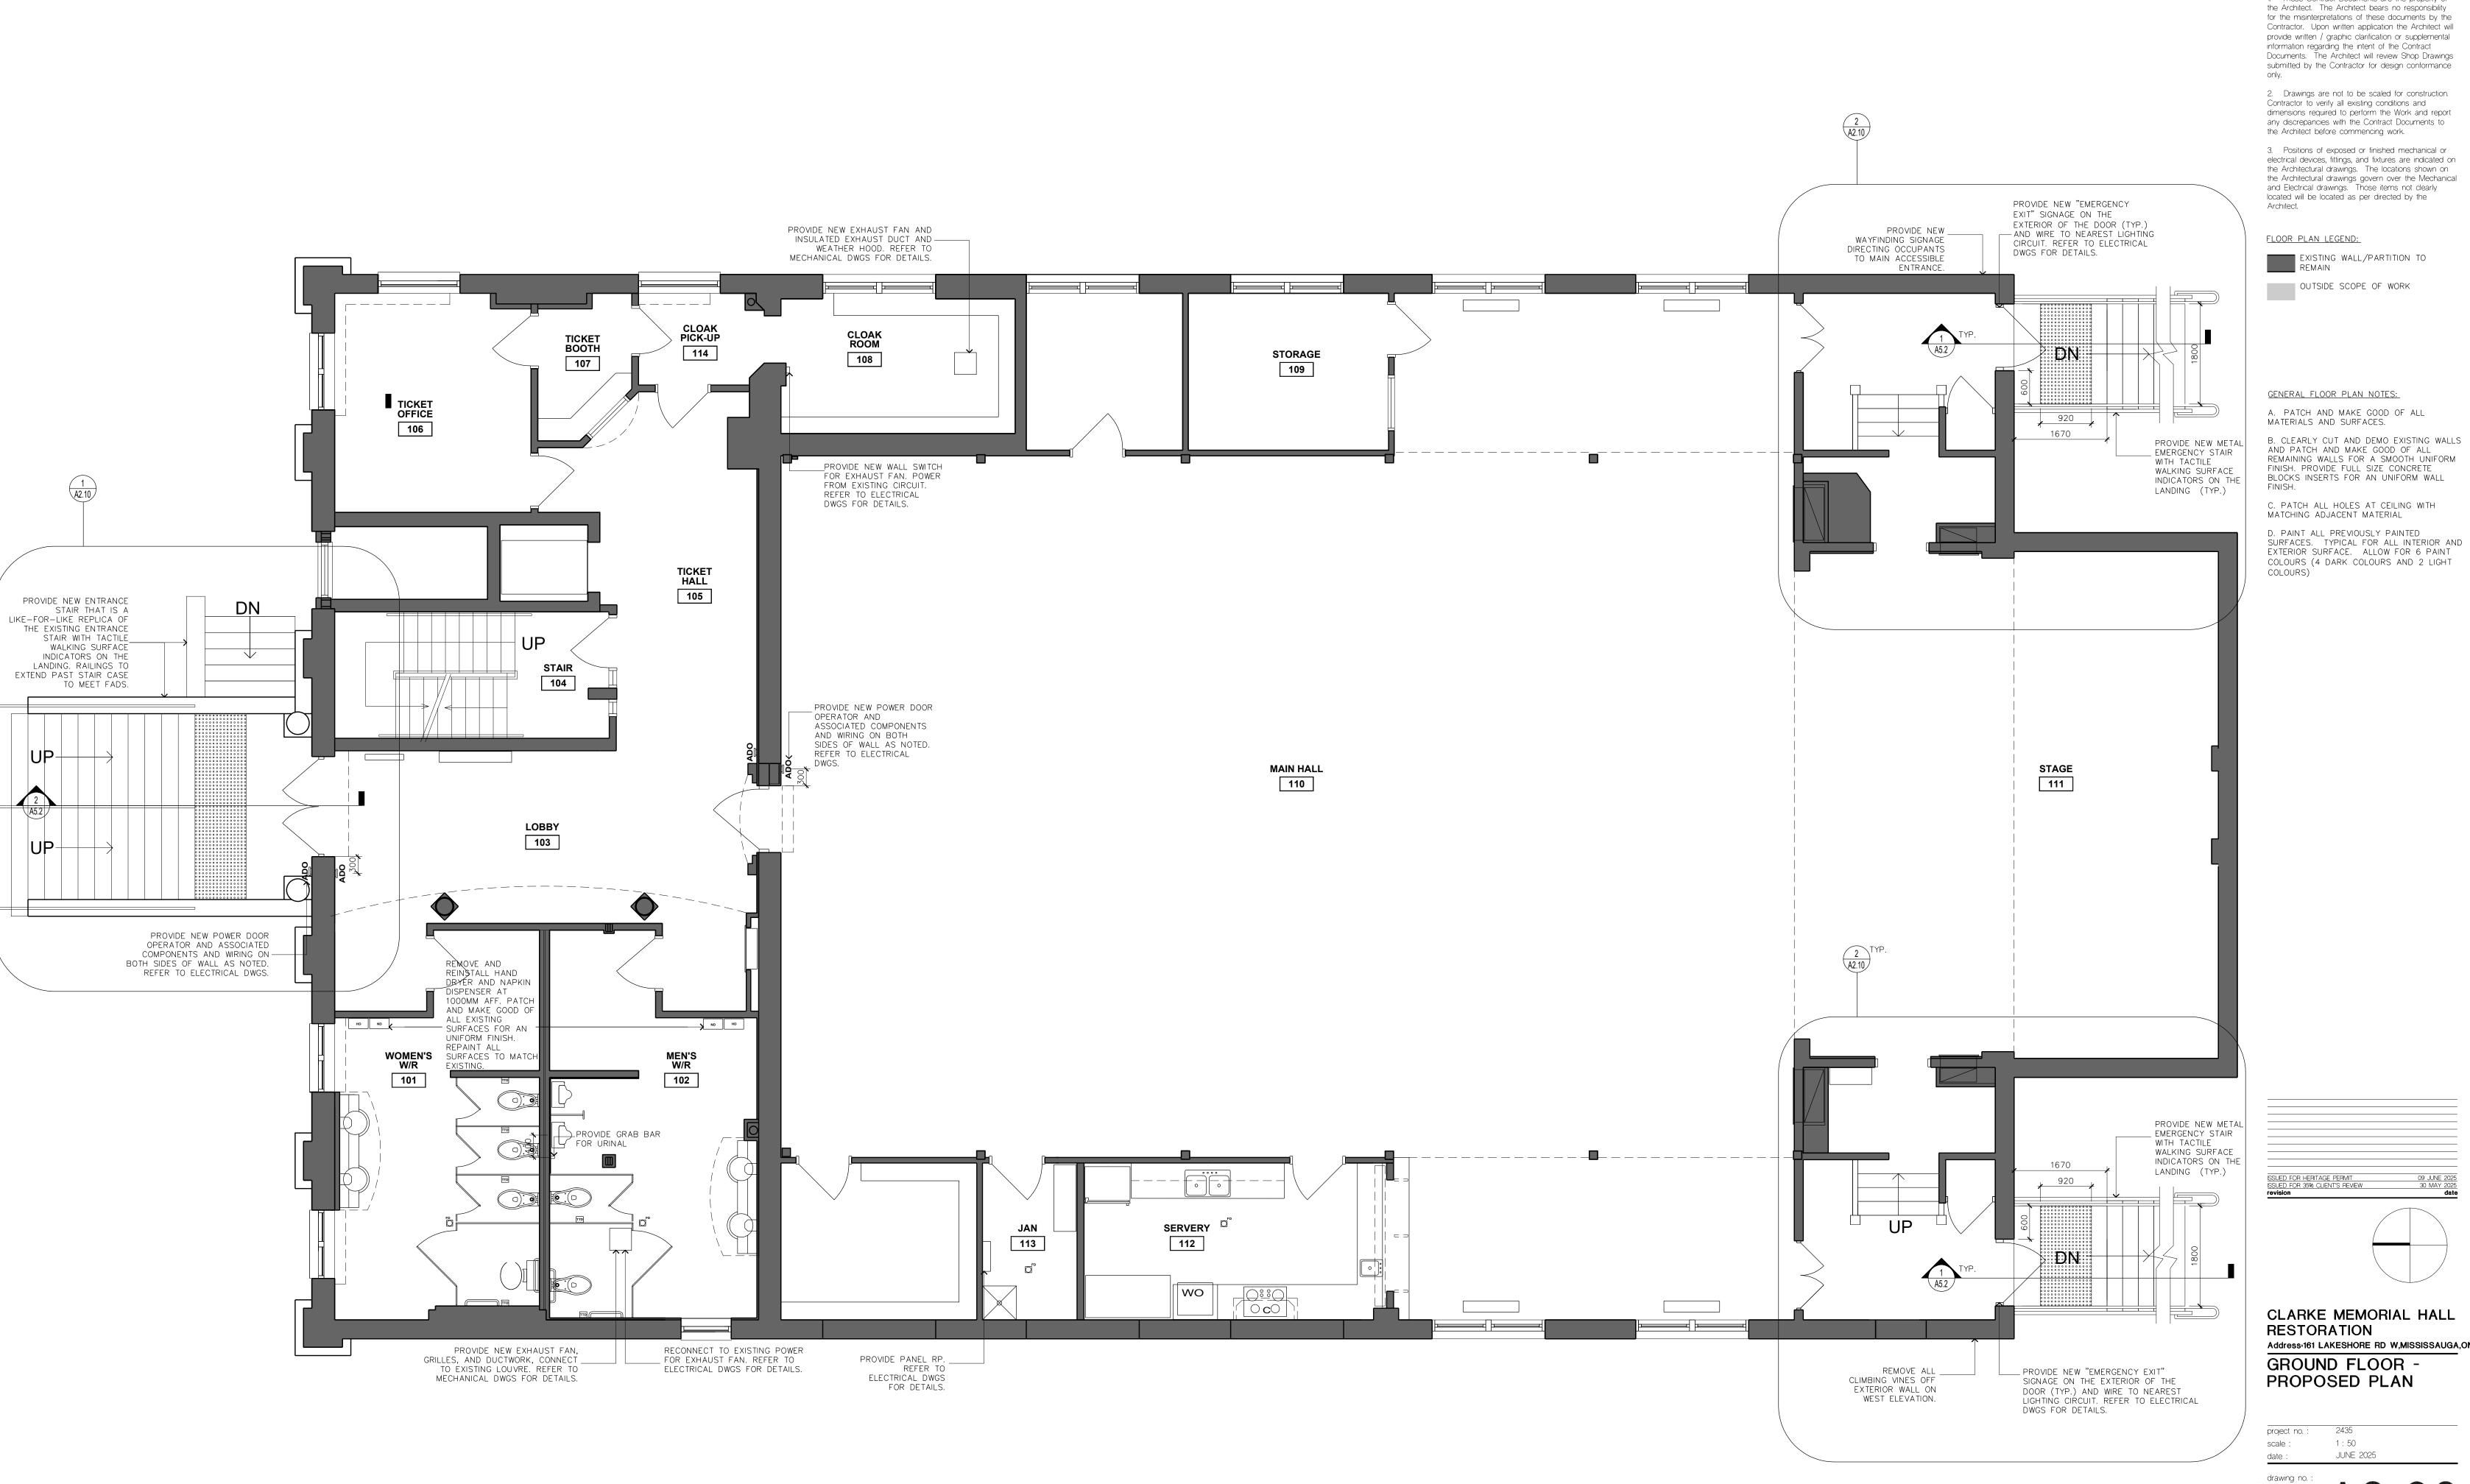
CLARKE MEMORIAL HALL

RESTORATION Address:161 LAKESHORE RD W,MISSISSAUGA,ON BASEMENT FLOOR -PROPOSED PLAN

project no. : 1:50 scale: JUNE 2025

drawing no.:

A2.8



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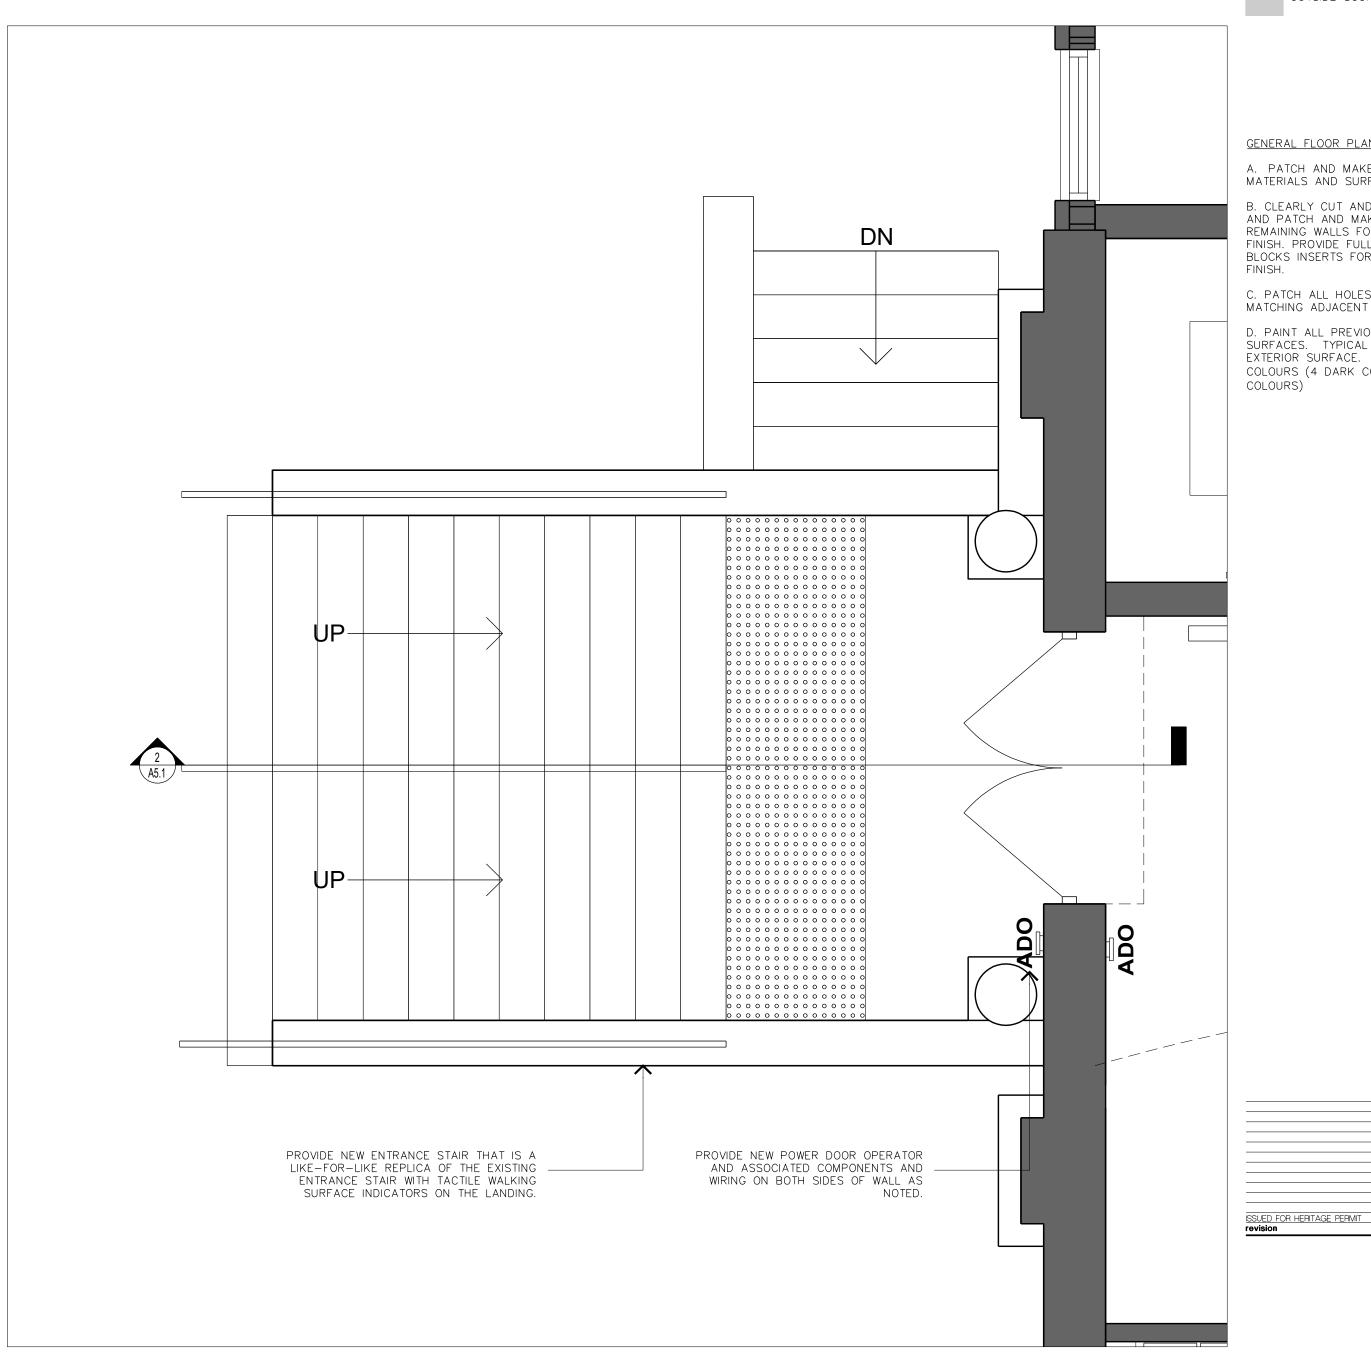
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EXTERIOR SURFACE. ALLOW FOR 6 PAINT COLOURS (4 DARK COLOURS AND 2 LIGHT

CLARKE MEMORIAL HALL Address:161 LAKESHORE RD W,MISSISSAUGA,ON

2 EMERGENCY STAIR - ENLARGED PLAN 1:25



1 ENTRANCE STAIR - ENLARGED PLAN 1:25

3. Positions of exposed or finished mechanical or electrical devices, fittings, and fixtures are indicated on the Architectural drawings. The locations shown on the Architectural drawings govern over the Mechanical

Architect.

the Architect before commencing work.

CHERIE NG ARCHITECT INC.

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general notes :

FLOOR PLAN LEGEND: EXISTING WALL/PARTITION TO REMAIN

OUTSIDE SCOPE OF WORK

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C. PATCH ALL HOLES AT CEILING WITH MATCHING ADJACENT MATERIAL

D. PAINT ALL PREVIOUSLY PAINTED SURFACES. TYPICAL FOR ALL INTERIOR AND EXTERIOR SURFACE. ALLOW FOR 6 PAINT COLOURS (4 DARK COLOURS AND 2 LIGHT

CLARKE MEMORIAL HALL RESTORATION Address:161 LAKESHORE RD W,MISSISSAUGA,ON GROUND FLOOR -ENLARGED PROPOSED

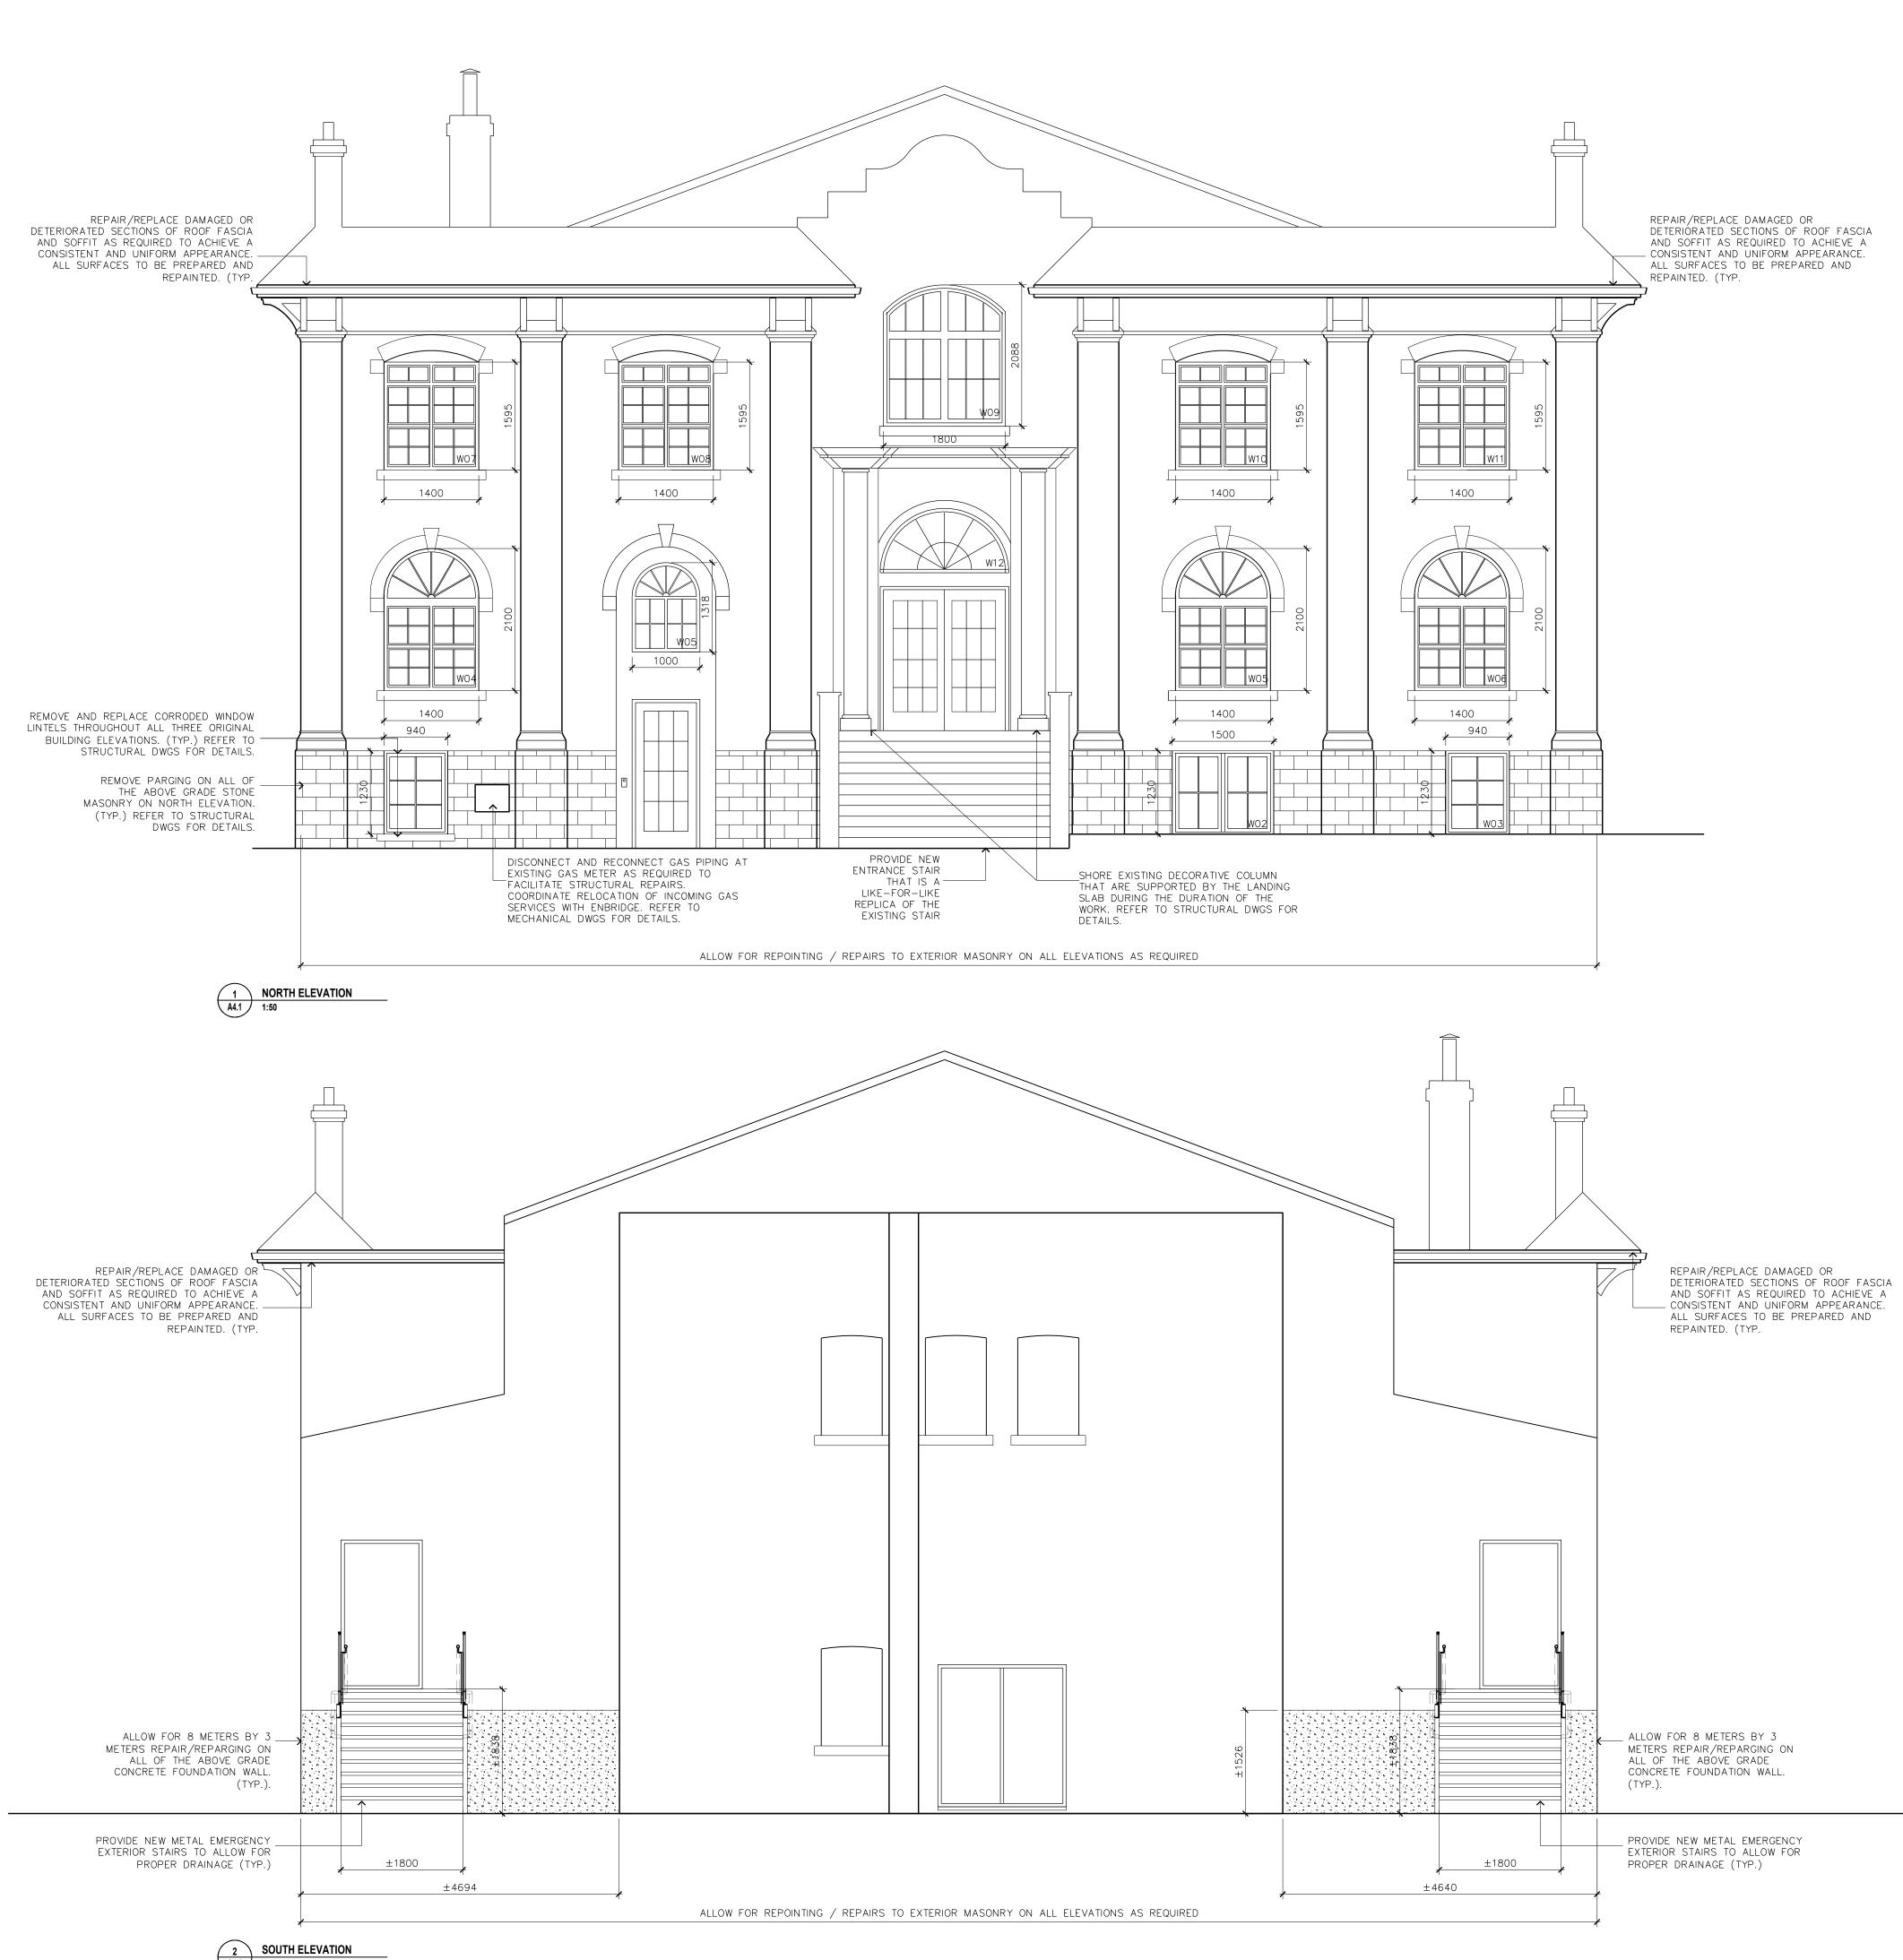
PLAN project no. : 1:25 scale:

JUNE 2025 drawing no.:

09 JUNE 2025 date

WINDOW RESTORATION NOTES :

- CLEAN ALL EXISTING WOOD WINDOW FRAMES TO REMOVE DIRT, DEBRIS, AND LOOSE OR PEELING PAINT. SAND AND PREPARE SURFACES TO RECEIVE NEW PAINT.
- CAREFULLY REMOVE EXISTING CAULKING AROUND WINDOW PERIMETERS ON BOTH INTERIOR AND EXTERIOR FACES. CLEAN SURFACES AND PREPARE TO RECEIVE NEW SEALANT.
- install new continuous sealant around all window perimeters, interior and exterior, to ensure a complete weather—tight seal.
- FILL ALL CRACKS, GAPS, AND MINOR SURFACE DEFECTS IN WOOD FRAMES WITH EXTERIOR—GRADE WOOD FILLER AS REQUIRED. APPLY TWO COATS OF PAINT TO ALL PREPARED WOOD SURFACES. MATCH COLOUR TO EXISTING.
- REPAINT ALL BASEMENT WINDOW CAGES. APPLY TWO COATS OF PAINT, MATCH COLOUR TO EXISTING.
- 6 INSTALL TRADITIONAL VENTED WOOD-FRAMED EXTERIOR STORM WINDOWS AT ALL FIXED WINDOW UNITS TO IMPROVE THERMAL PERFORMANCE AND ENERGY EFFICIENCY.



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ISSUED FOR HERITAGE PERMIT

ISSUED FOR 35% CLIENT'S REVIEW

30 MAY 20

Tevision


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CLARKE MEMORIAL HALL
RESTORATION
Address-161 LAKESHORE RD W,MISSISSAUGA,ON
NORTH AND SOUTH
ELEVATIONS

project no. : 2435 scale : 1 : 50 date : JUNE 2025

drawing no. :

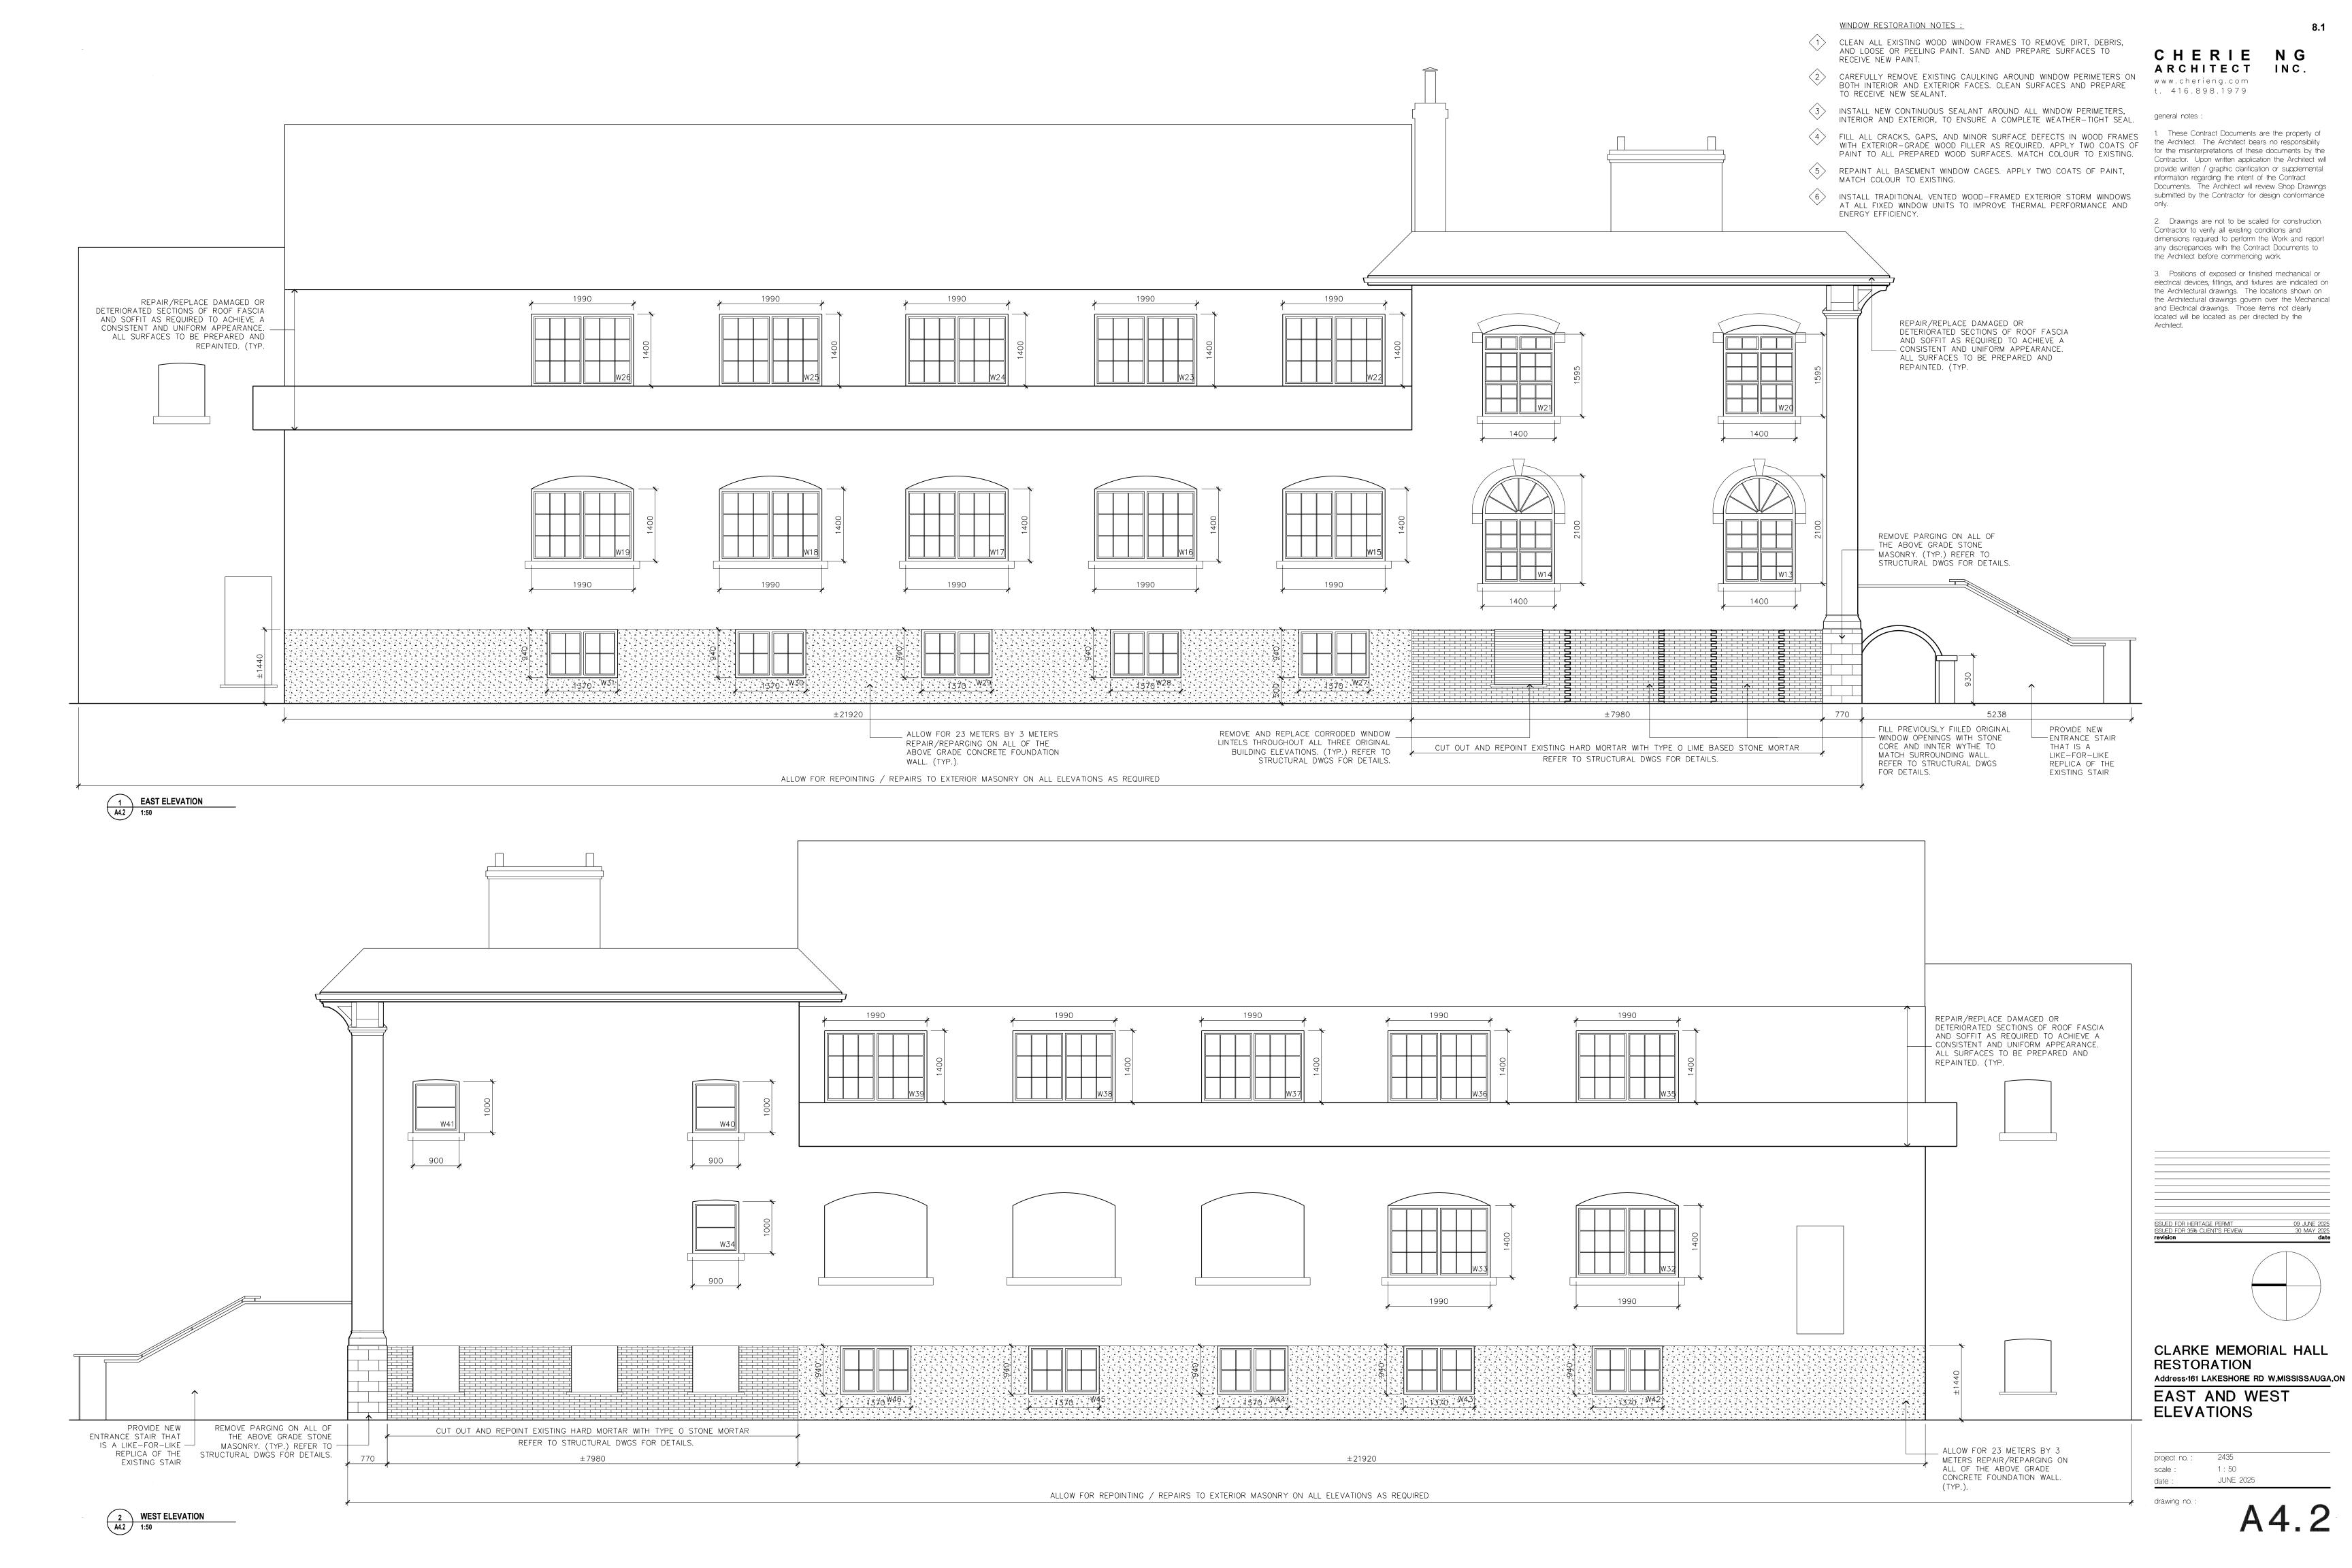A4.



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Drawings are not to be scaled for construction.
Contractor to verify all existing conditions and
dimensions required to perform the Work and report
any discrepancies with the Contract Documents to
the Architect before commencing work.


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EXISTING WALL/PARTITION TO REMAIN


OUTSIDE SCOPE OF WORK

FLOOR PLAN LEGEND:

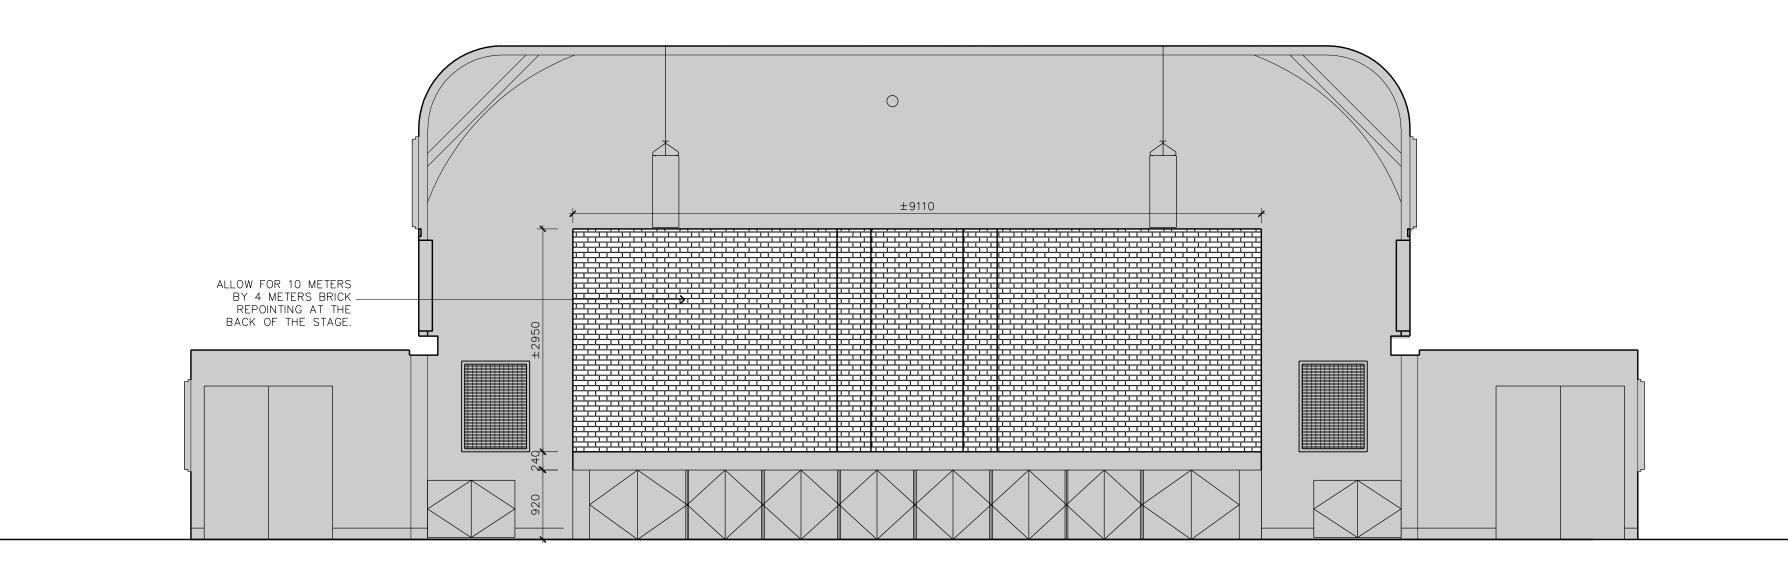general notes :




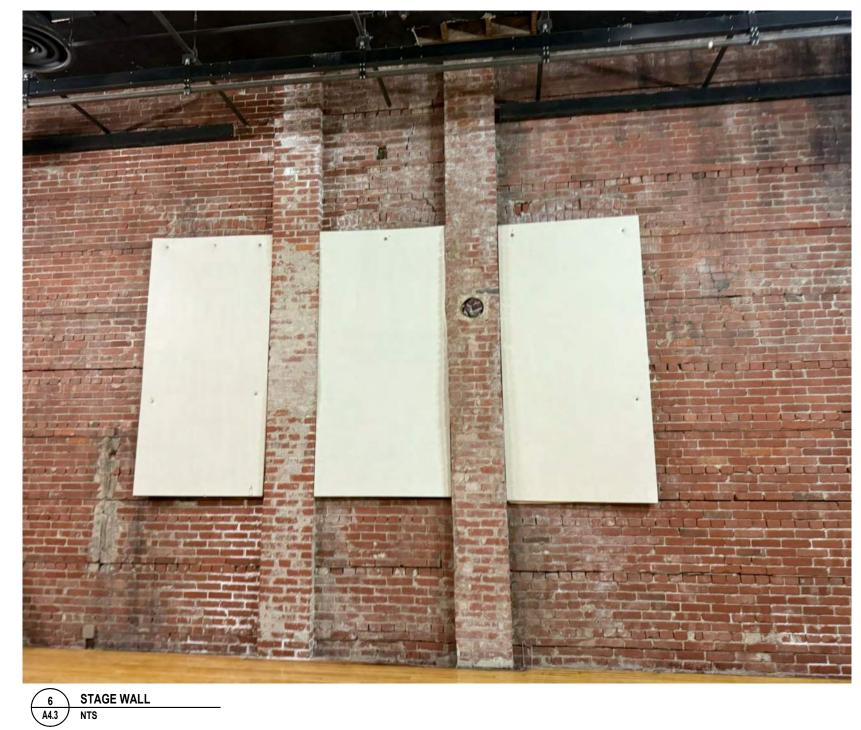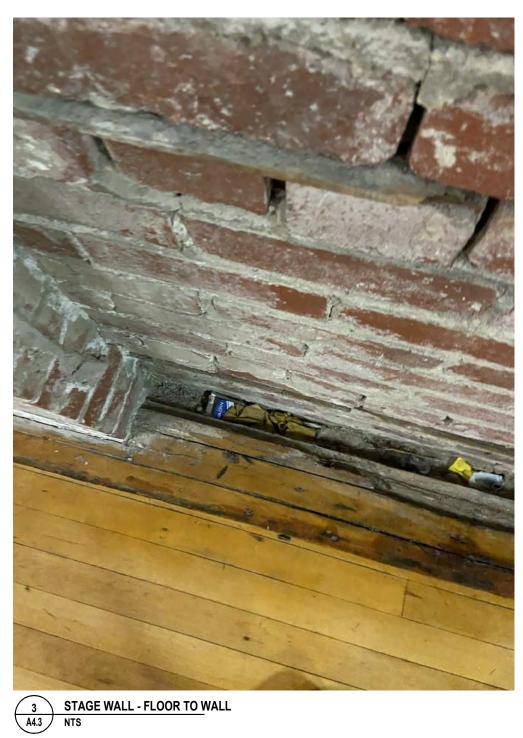1 INTERIOR ELEVATION - SOUTH STAGE
A4.3 1:50











SSUED FOR HERITAGE PERMIT 09 JUNE 2025
revision date

CLARKE MEMORIAL HALL
RESTORATION
Address-161 LAKESHORE RD W,MISSISSAUGA,ON
INTERIOR
ELEVATIONS

project no.: 2435 scale: 1:50

CHERIE NG ARCHITECT INC.


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CLARKE MEMORIAL HALL Address-161 LAKESHORE RD W,MISSISSAUGA,ON

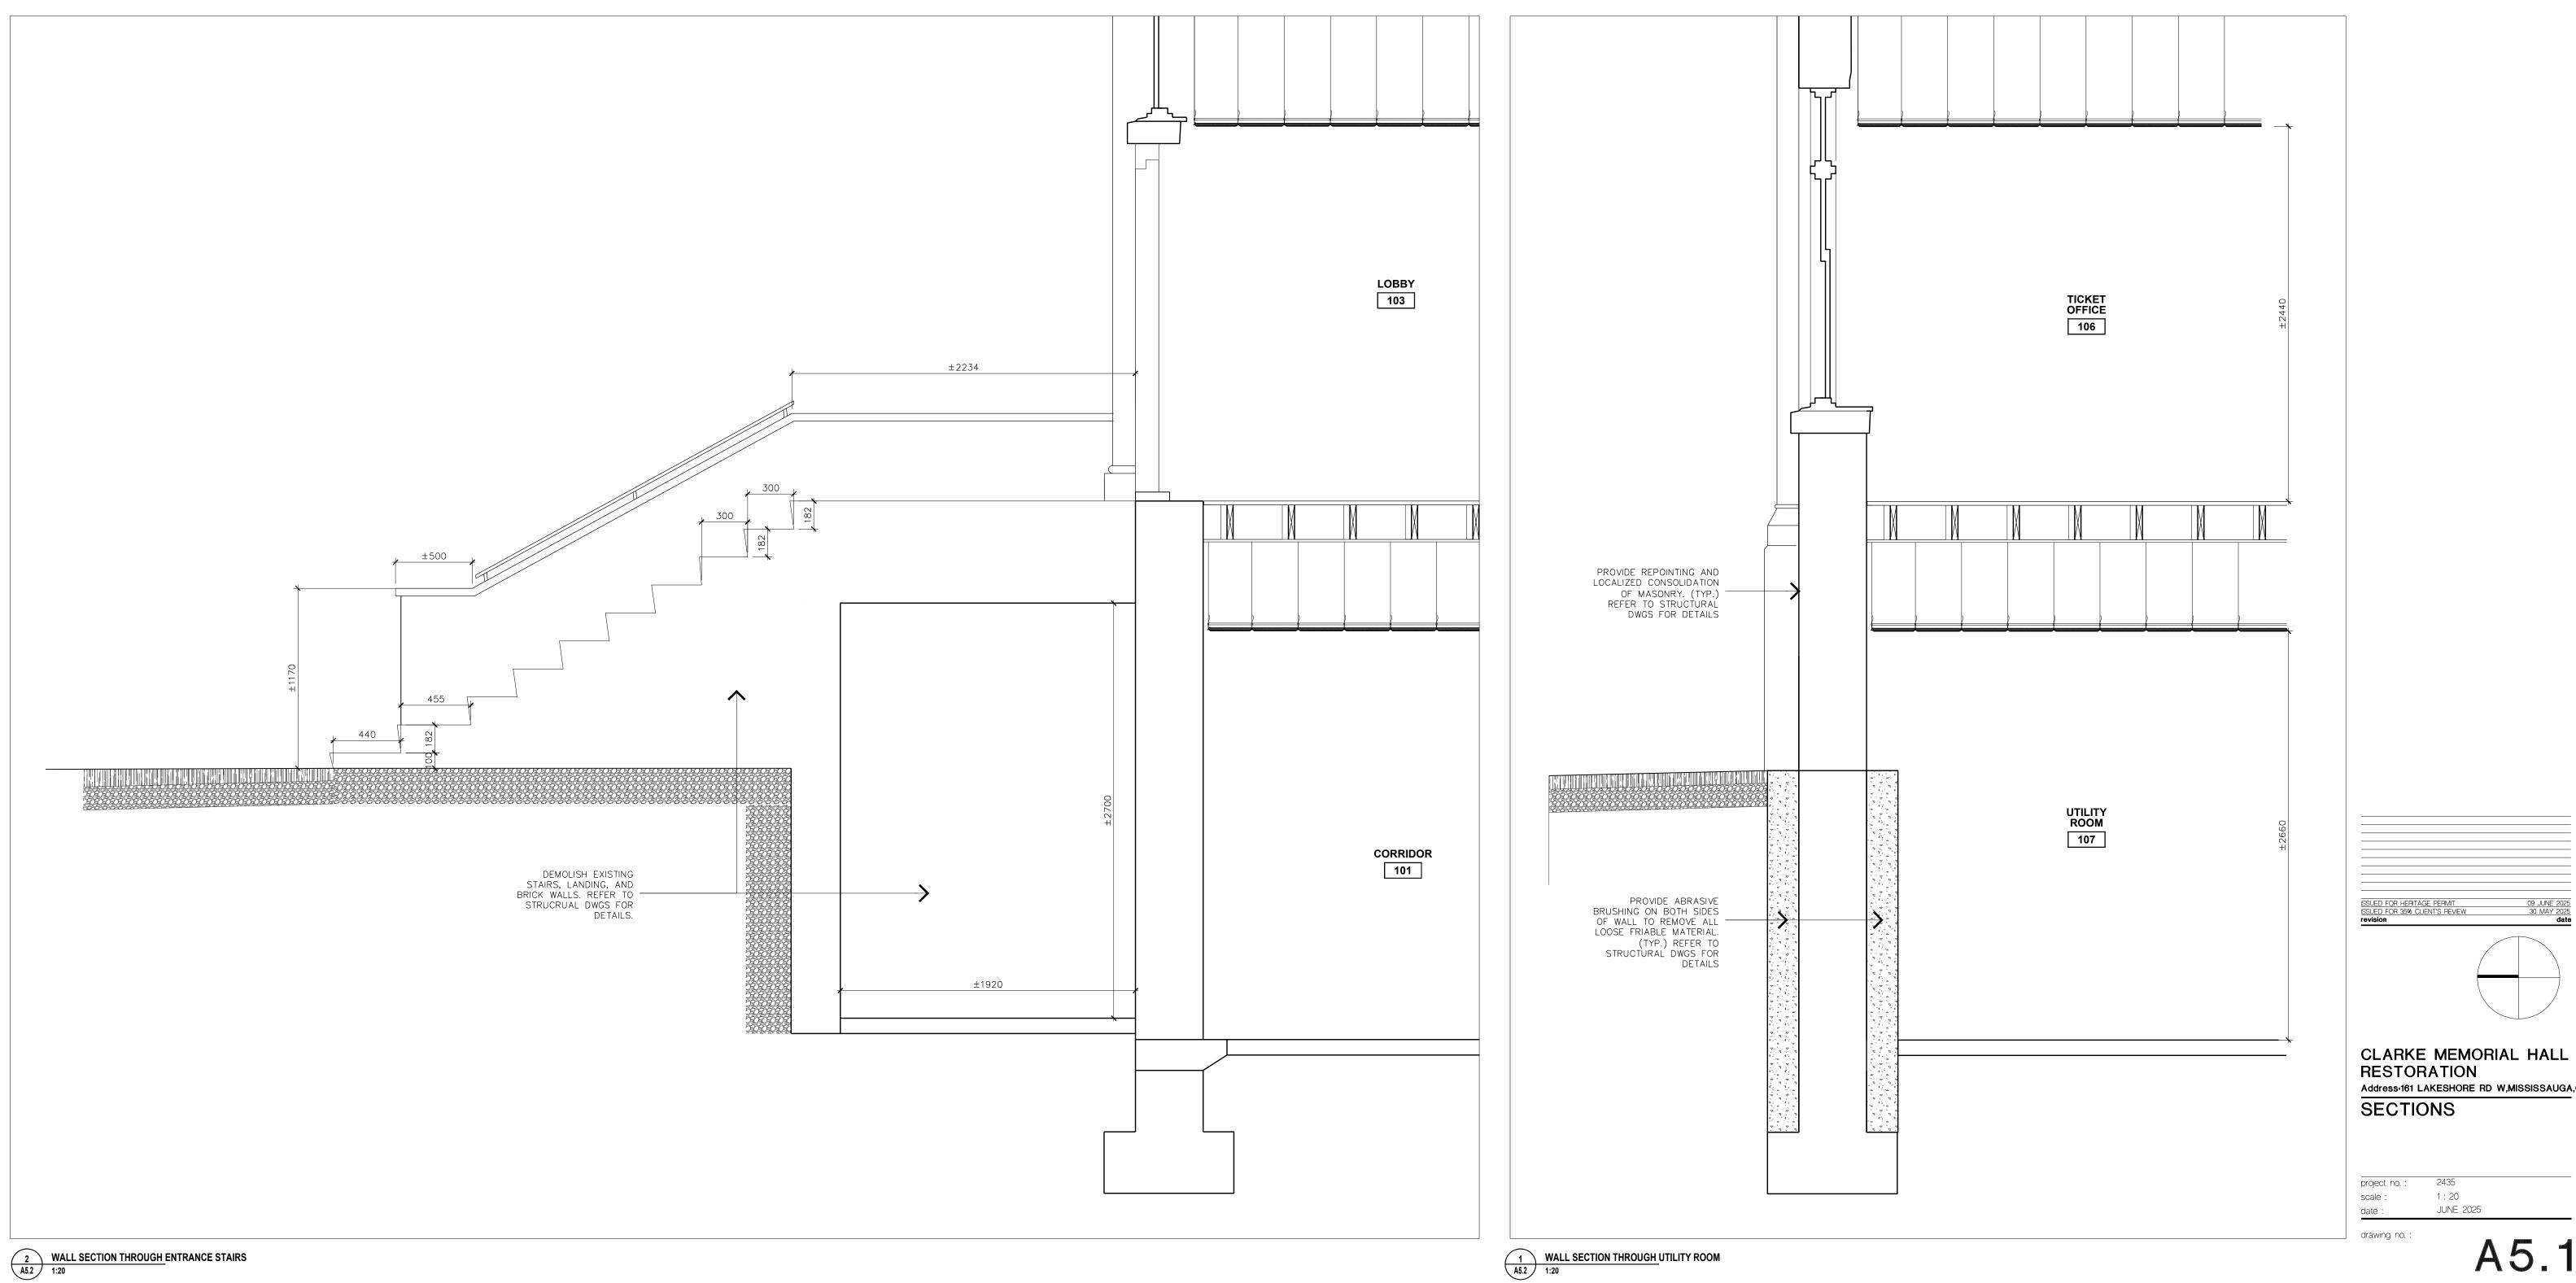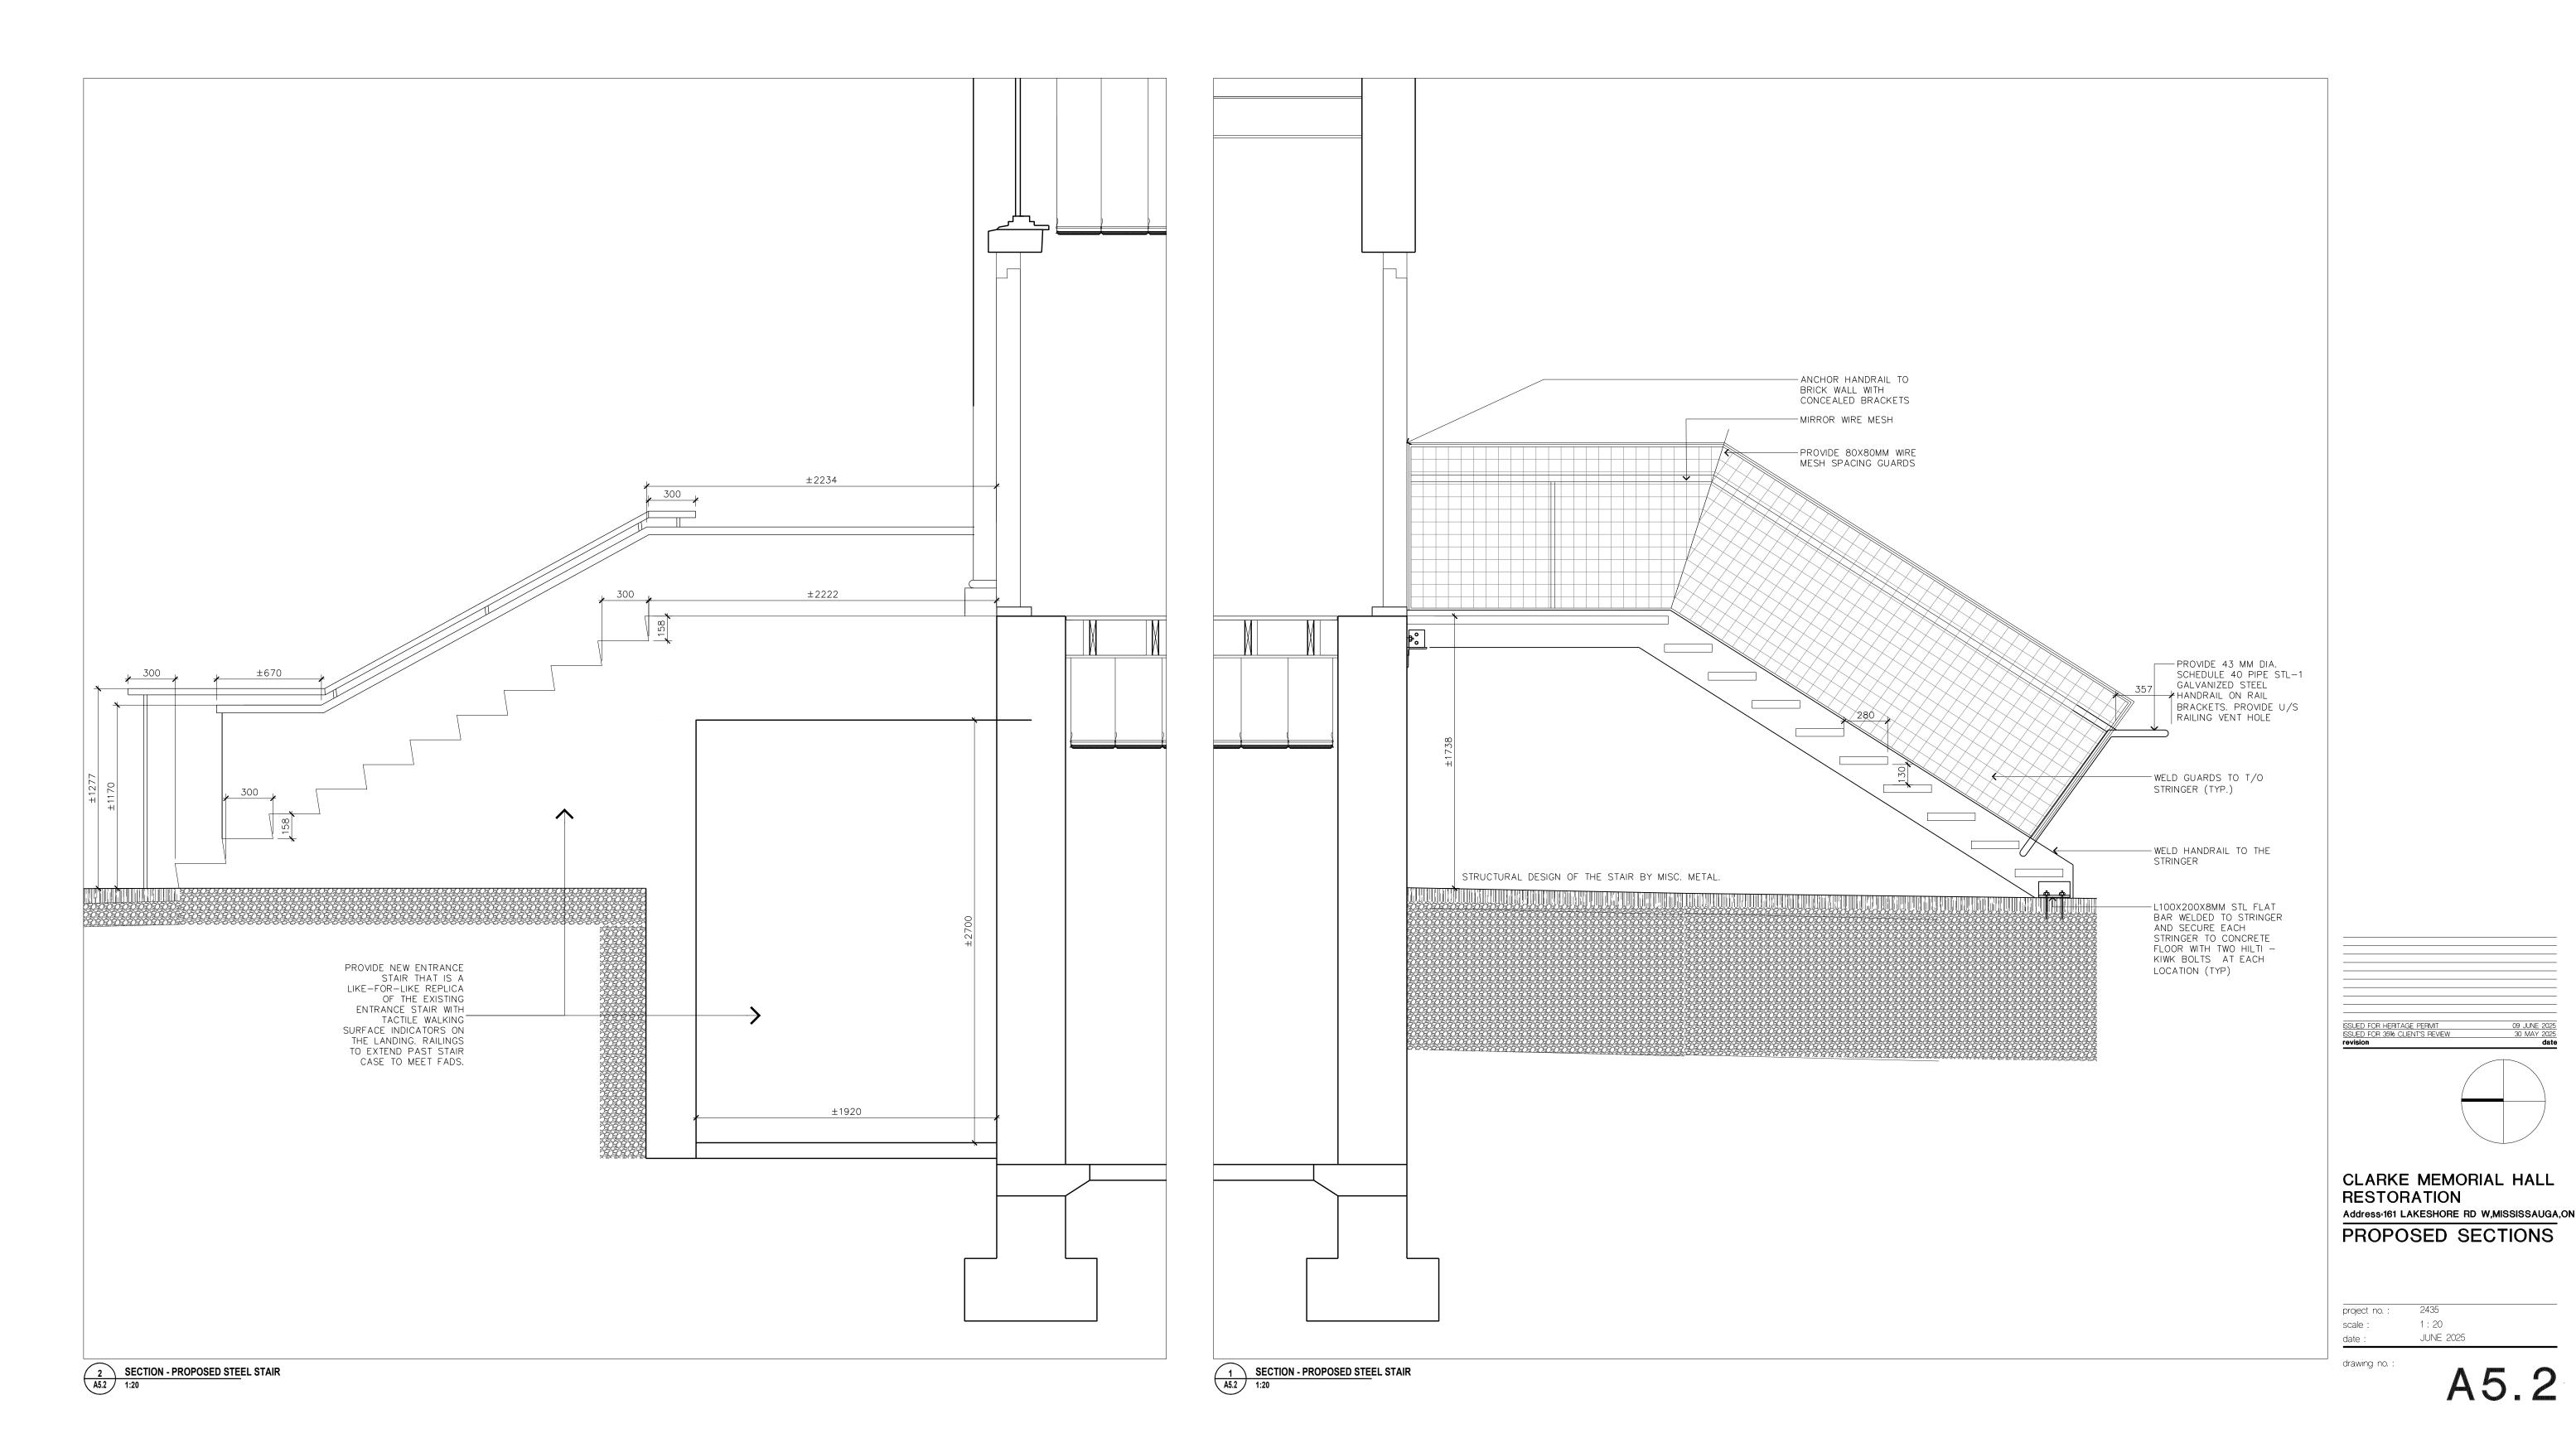
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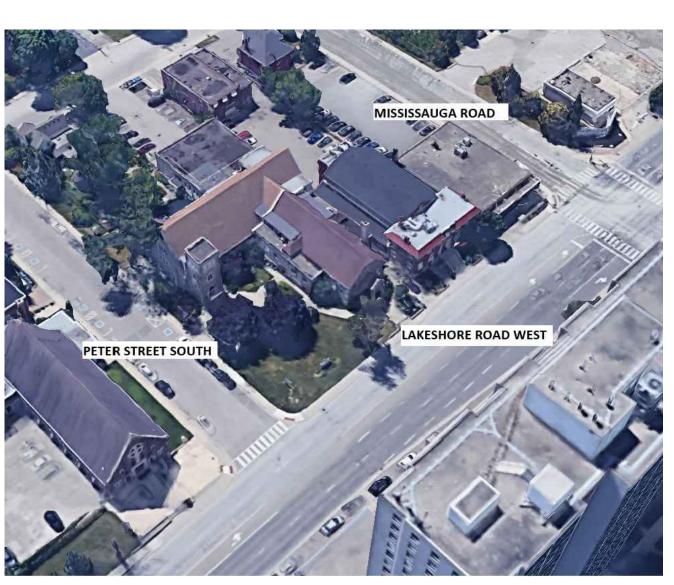
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2 3D AERIAL VIEW

CHERIE NG ARCHITECT INC. www.cherieng.com t. 416.898.1979

general notes :

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CLARKE MEMORIAL HALL

Project # 250167

Blackwell

Toronto 416.593.5300 | Waterloo 519.616.0895 | Victoria 778.817.1010 | Halifax 902.593.0125 | blackwell.ca

N.A APRIL 2025

CLARKE MEMORIAL HALL RESTORATION address: 161 lakeshore rd w,mississauga,on GENERAL NOTES

THIS SET OF DRAWINGS IS AN EARLY CONCEPT SET - ISSUED FOR HERITAGE PERMIT REVIEW ONLY. NOT FOR CONSTRUCTION.

NOTE:

RESTORATION

1 BASEMENT S101 SCALE 1:50

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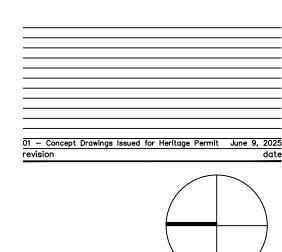
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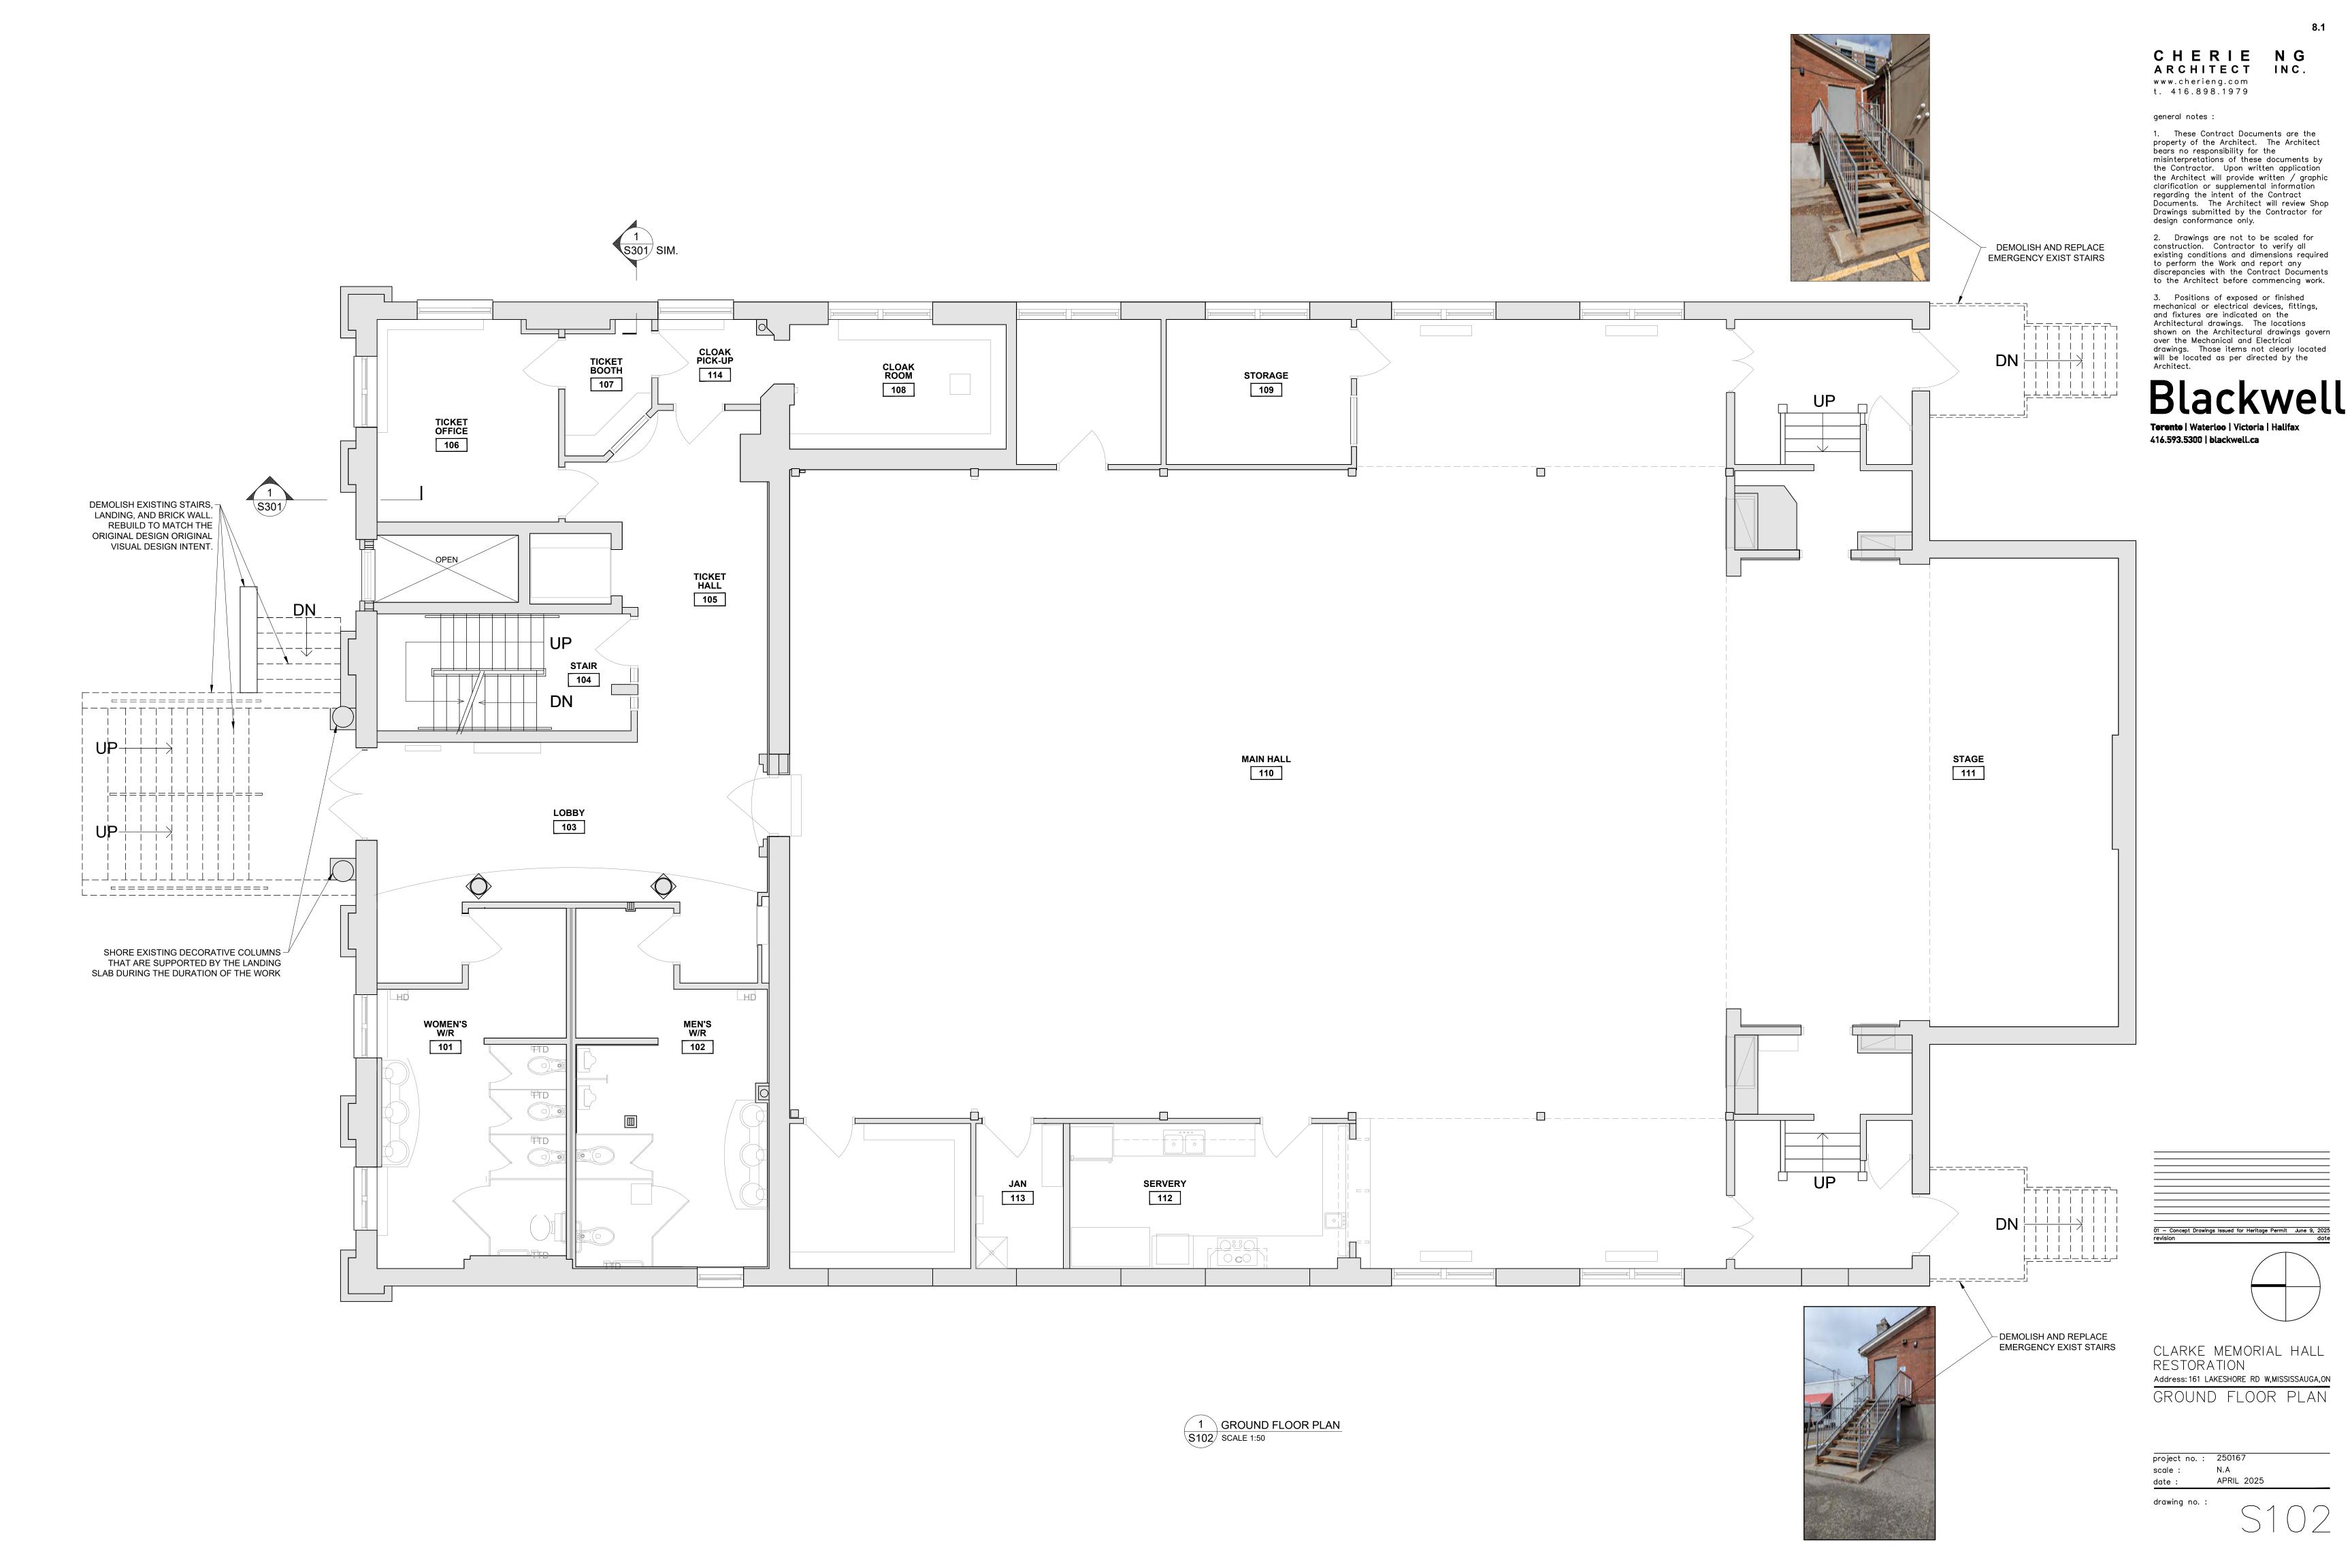
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CLARKE MEMORIAL HALL RESTORATION Address: 161 LAKESHORE RD W,MISSISSAUGA,ON

BASEMENT PLAN

N.A scale : APRIL 2025



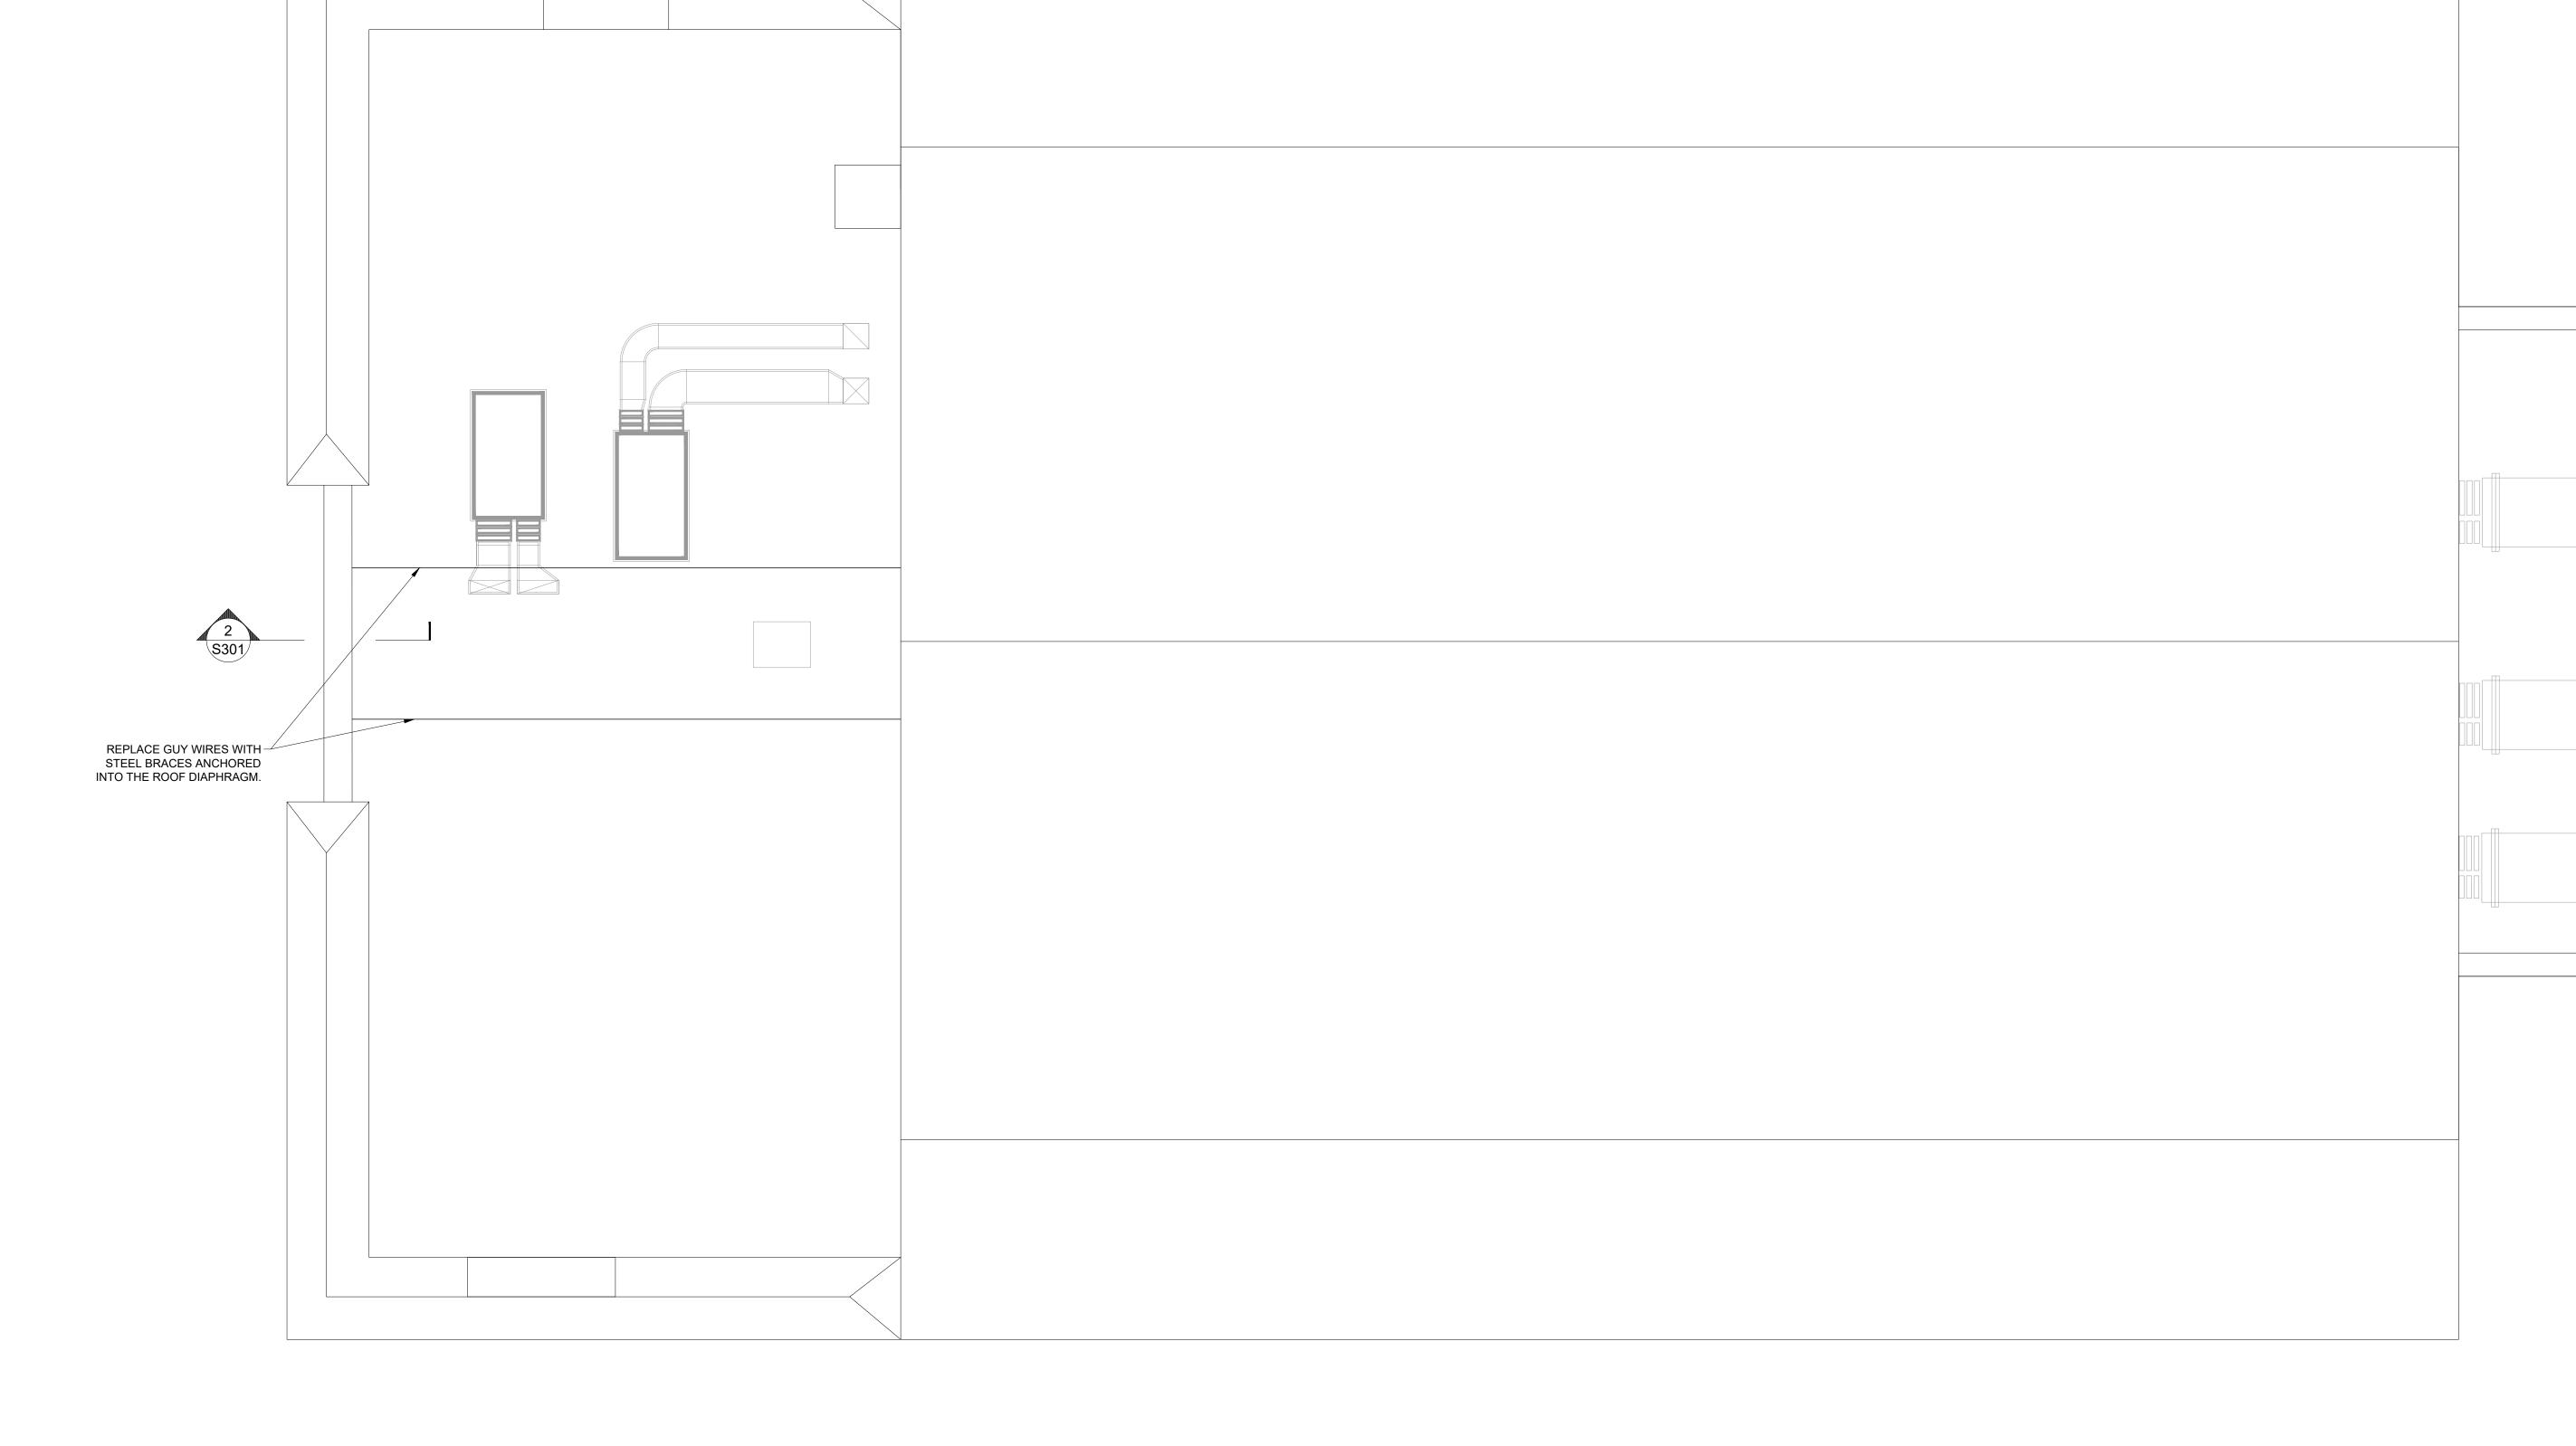
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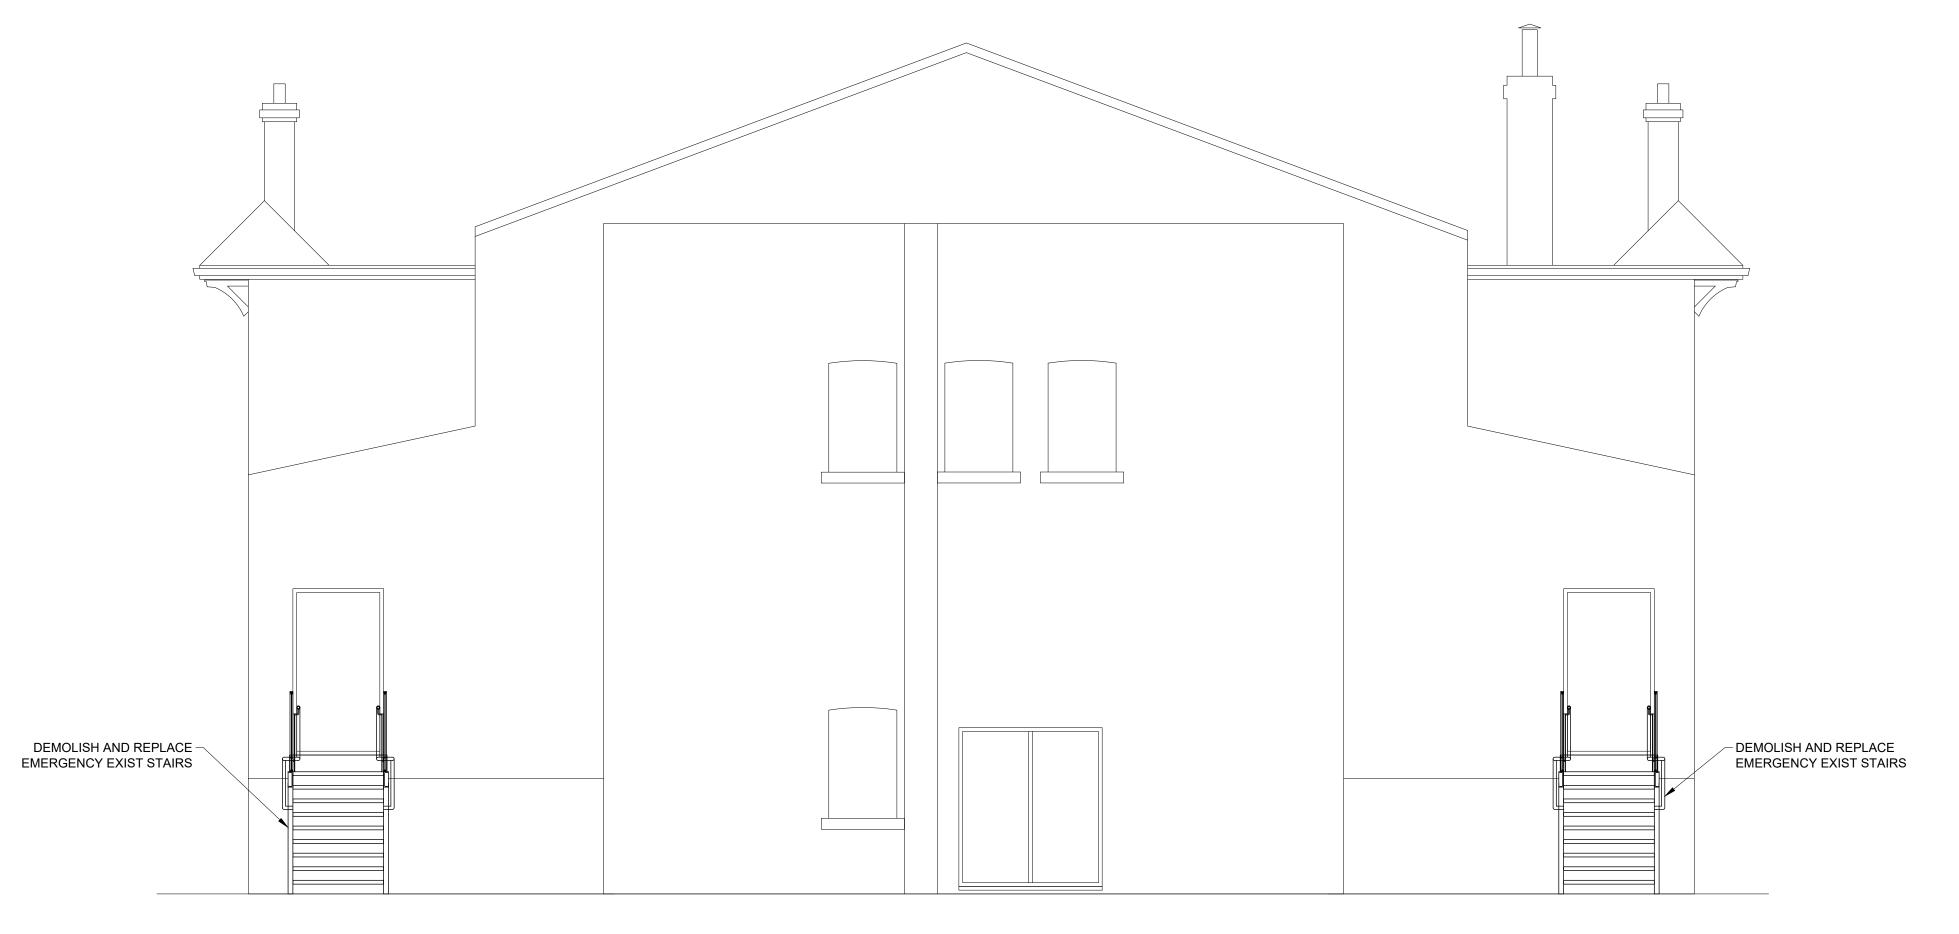


01 - Concept Drawings Issued for Heritage Permit June 9, 2025 revision date

CLARKE MEMORIAL HALL RESTORATION Address: 161 LAKESHORE RD W,MISSISSAUGA,ON ROOF PLAN

project no. : 250167 scale : N.A date : APRIL 2025







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general notes :


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CLARKE MEMORIAL HALL RESTORATION address: 161 lakeshore rd w,mississauga,on

Address: 161 LAKESHORE RD W,MISSISSAUGA,ON
NORTH AND SOUTH
ELEVATION

project no.: 250167 scale: N.A date: APRIL 2025

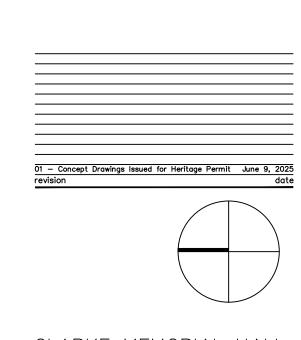drawing no



2 WEST ELEVATION S202 SCALE 1:50

- EXTENT OF REPOINTING AND LOCALIZED CONSOLIDATION OF MASONRY

SELECT REMOVALS TO EVALUATE CORE WHERE NO STONES COME LOOSE.

REQUIRED AROUND BOILER ROOM AND 15% CORE REBUILDING ELSEWHERE)

REMOVAL OF STONES THAT FALL OUT AFTER RAKING JOINTS

• REMOVAL OF EXTERIOR HARD POINTING MORTARS THROUGHOUT. DEEP RAKING OUT JOINTS.

CONSOLIDATION OF ANY DISCOVERED VOID CORE AREAS (ASSUME 75% CORE REBUILDING

Address: 161 LAKESHORE RD W,MISSISSAUGA,ON EAST AND WEST ELEVATION

scale : N.A APRIL 2025

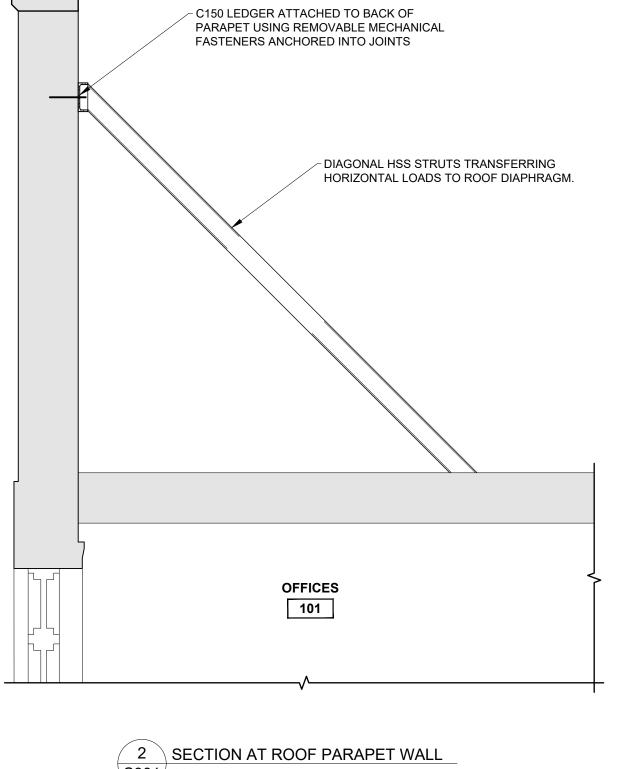
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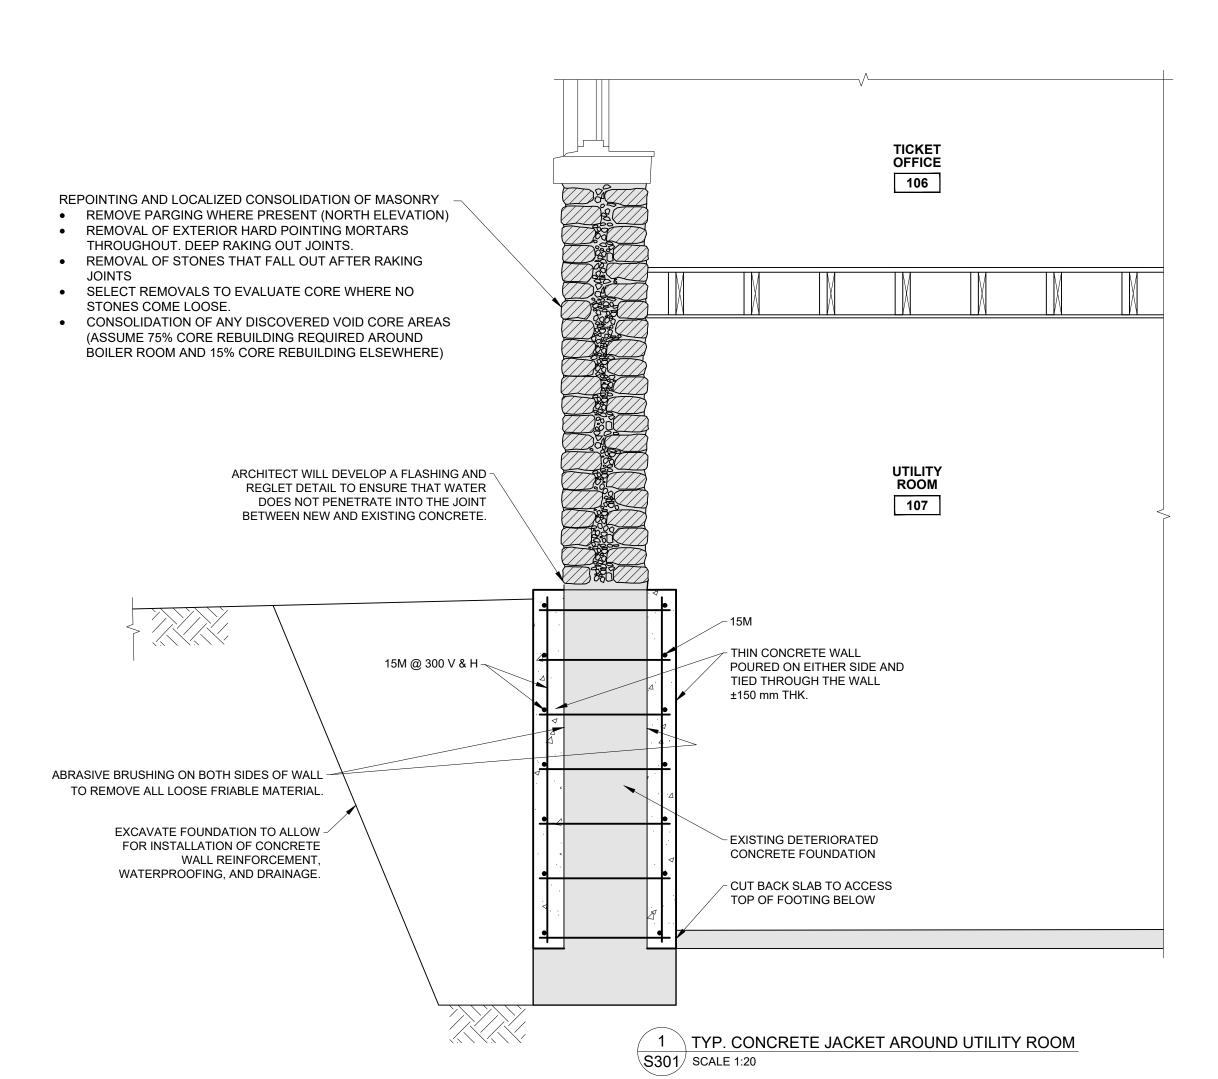
\$301 SCALE 1:20

01 - Concept Drawings Issued for Heritage Permit June 9, 2025 revision date

CLARKE MEMORIAL HALL

RESTORATION Address: 161 LAKESHORE RD W,MISSISSAUGA,ON
SECTIONS AND DETAILS

APRIL 2025



GENERAL MECHANICAL CONDITIONS

CONDITIONS.

TESTING TO DELIVER A COMPLETE AND FUNCTIONAL SYSTEMS, READY FOR OPERATION.

2. PERFORM WORK IN A CLEAN AND WORKMANLIKE MANNER. EXERCISE CARE

1. CONTRACTOR IS RESPONSIBLE FOR ALL WORK, LABOUR, MATERIALS,

- PERFORM WORK IN A CLEAN AND WORKMANLIKE MANNER. EXERCISE CARE
 TO DISRUPTION TO OTHER AREAS OF THE BUILDING WHICH ARE TO
 REMAIN IN OPERATION. ISOLATE WORK AREAS AS REQUIRED TO CONTAIN
 DUST AND DEBRIS WITHIN THE CONSTRUCTION AREA.
- DUST AND DEBRIS WITHIN THE CONSTRUCTION AREA.

 3. THE DRAWINGS ARE INTENDED TO BE DIAGRAMMATIC AND ARE DEVELOPED ON THE INDICATED BASIS OF DESIGN EQUIPMENT. ALL ITEMS MAY NOT BE SHOWN OR NOT SHOWN IN THEIR EXACT LOCATION, OR WITH EXACT DIMENSIONS AND DETAILS. THE CONTRACTOR SHALL VERIFY

THE ACTUAL DIMENSIONS OF THE EQUIPMENT PROPOSED TO ENSURE THAT

- THE EQUIPMENT WILL FIT IN THE AVAILABLE SPACE.

 4. FIELD VERIFY ALL DIMENSIONS AND EXISTING CONDITIONS PRIOR TO PROCEEDING WITH ANY WORK. WHERE DISCREPANCIES OCCUR BETWEEN THESE DOCUMENTS AND EXISTING CONDITIONS, REPORT THE CONDITIONS
- AND/OR ENGINEER.

 5. CONTRACTOR SHALL BE RESPONSIBLE FOR THE SAFEKEEPING OF THEIR OWN PROPERTY ON THE JOB SITE. OWNER ASSUMES NO RESPONSIBILITY
- FOR PROTECTION OF PROPERTIES.

 6. PRIOR TO STARTING CONSTRUCTION, DETERMINE EXACT INVERT ELEVATION, SIZE, DEPTH AND LOCATION OF EXISTING UTILITIES WHERE CONNECTIONS ARE TO BE MADE OR INTERSECTIONS OCCUR. NOTIFY ENGINEER OF ANY DISCREPANCY BETWEEN DRAWINGS AND ACTUAL FIELD
- 7. CONSTRUCT WORK TO ALL APPLICABLE CODES, LAWS AND REGULATIONS GOVERNING OR RELATING TO ANY PORTION OF THIS WORK. CORRECT AND WORK IN MODEL AND OF APPLICA
- ANY WORK IN VIOLATION OF ABOVE.

 8. INSTALL OR ERECT PRODUCTS IN ACCORDANCE WITH MANUFACTURER'S INSTRUCTIONS. OBTAIN WRITTEN INSTRUCTIONS DIRECTLY FROM
- MANUFACTURER.

 9. PROVIDE AND MAINTAIN TEMPORARY FIRE PROTECTION DURING
- PERFORMANCE OF THE WORK.

 10. MANUFACTURER AND/OR THIRD-PARTY AGENT AS NOTED IN DRAWINGS.

 11. INSTALL WORK SO AS TO BE READILY ACCESSIBLE FOR OPERATION,
 MAINTENANCE AND REPAIR PROVIDE SLEEVES AND ACCESS DOORS.
- REQUIRED FOR THE SERVICING OF CONCEALED EQUIPMENT.

 12.REMOVE AND RELOCATE EXISTING WORK AS REQUIRED, NECESSARY FOR THE PERFORMANCE OF THE GENERAL WORK. ALL EXISTING CONDITIONS MAY NOT BE COMPLETELY DETAILED ON THE DRAWINGS. CONTRACTOR TO SURVEY THE SITE AND INCLUDE ALL CHANGES IN MAKING UP THE WORK
- 13.SEAL ALL OPENINGS AROUND PIPES & DUCTS THROUGH PARTITIONS AND WALLS WITH APPROVED FIRESTOPPING MATERIAL.
- 14.GAS PIPING AND GAS VENTS SHALL CONFORM TO CSA B149.1 NATURAL GAS AND PROPANE INSTALLATION CODE WITH LATEST AMENDMENTS BY TSSA. PAINTING/BANDING OF GAS PIPING TO SATISFACTION OF AUTHORITIES HAVING JURISDICTION SHALL BE BY THIS CONTRACTOR.

 15.CONSTRUCT WORK IN A MANNER SATISFACTORY TO THE OWNER.
- 16.REMOVE AND DISPOSE OF ALL EXISTING EQUIPMENT AS INDICATED, AS REQUIRED TO COMPLETE SCOPE OF WORK. VISIT SITE AND VERIFY SCOPE PRIOR TO SUBMITTING BID.
- 17.CLEAN FROM ALL FIXTURES AND EQUIPMENT DUST, DIRT, FINGER-PRINTS, PAINT, GREASE, CONSTRUCTION AND DEMOLITION DEBRIS. CLEAN AND TOUCH UP SURFACES OF SHOP-PAINTED EQUIPMENT SCRATCHED OR MARRED DURING SHIPMENT OR INSTALLATION, TO MATCH ORIGINAL EDITION.
- 18. COORDINATE WORK OF OTHER TRADES (ELECTRICAL, SPRINKLER, STRUCTURAL, ETC.). ENSURE THAT PROPER ARRANGEMENTS AND PROVISIONS ARE MADE FOR THIS WORK. COORDINATE MECHANICAL REQUIREMENTS OF ALL OWNER-SUPPLIED EQUIPMENT PRIOR TO
- 19.ROOF CURB & OPENINGS: MECHANICAL CONTRACTOR SHALL SUPPLY ALL ROOF FLASHINGS, CURBS, STRUCTURAL SUPPORTS FOR ROOF OPENINGS AND COUNTER FLASHING FOR MECHANICAL EQUIPMENT AS REQUIRED FOR COMPLETION OF WORK.
- ELECTRICAL WIRING AND CONTROLS

 1. ALL POWER WIRING FOR ALL MECHANICAL EQUIPMENT SHALL BE DONE BY DIVISION 26 ELECTRICAL, EXCEPT WHERE SPECIFICALLY NOTED
- OTHERWISE.

 2. THE MECHANICAL DIVISION SHALL PROVIDE ALL STARTERS, RELAYS, CONTROL DEVICES, AND ANY BUILT-IN SAFETY SWITCHES. THE ELECTRICAL
- WILL PROVIDE ALL FIELD-MOUNTED SAFETY DISCONNECTS.

 3. THE MECHANICAL DIVISION SHALL PROVIDE ALL CONNECTIONS AND WIRING FOR CONTROLS, AND INTERLOCKS.
- SUBSTITUTIONS

 1. ALL EQUIPMENT AND MATERIALS SHALL BE AS SPECIFIED OR "APPROVED EQUAL" BY ENGINEER. ALTERNATES MAY BE SUBMITTED IN PLACE OF SPECIFIED MECHANICAL FOLLIPMENT. CONTRACTOR SHALL INCLUDE ALL
- SPECIFIED MECHANICAL EQUIPMENT. CONTRACTOR SHALL INCLUDE ALL SPECIFIED MAJOR EQUIPMENT IN THE BASE BID AND SHOW LINE ITEM PRICE REDUCTIONS FOR PROPOSED ALTERNATES. ALTERNATES FOR MINOR EQUIPMENT MAY BE SUBSTITUTED WITHOUT PRESENTING LINE ITEM PRICE REDUCTIONS. FINAL APPROVAL OF ALL ALTERNATES SUBJECT TO OWNER/ENGINEER REVIEW. SUBMIT ALL REQUESTED INFORMATION TO ENGINEER FOR REVIEW OF ALTERNATES.
- 2. CONTRACTOR IS RESPONSIBLE FOR ALL COSTS RELATED TO SUBSTITUTION TO DELIVER A COMPLETE AND FUNCTIONAL SYSTEM, READY FOR OPERATION. THIS INCLUDES CHANGES IN DUCT OR PIPING ARRANGEMENT OR SIZE, ELECTRICAL REQUIREMENTS (OVERCURRENT PROTECTION, WIRING, INTERLOCKS), REQUIRED ANCILLARY COMPONENTS, ADDITIONAL SUPPORTS, ETC.
- 1. TEST, ADJUST, BALANCE ALL AIR MOVING EQUIPMENT, AIR DISTRIBUTION, HEATING SYSTEMS, EXHAUST SYSTEMS, EXHAUST AND MAKE-UP SYSTEMS, ALL HYDRONIC SYSTEMS AS SPECIFIED AND AS INDICATED ON DRAWINGS TO NEBB OR AABC STANDARD.

BALANCING

- 2. TAB SHALL NOT BEGIN UNTIL ALL SYSTEMS ARE COMPLETED AND IN FULL WORKING ORDER.
- 3. CHANGES TO FILTERS, DRIVES, AND DAMPERS OR THE ADDITION OF DAMPERS, CONTROL DEVICES OR GAUGES REQUIRED TO CORRECT BALANCE AS REQUIRED SHALL BE MADE AT NO ADDITIONAL COST TO OWNER.
- 4. PRIOR TO TAB, ALL EQUIPMENT AND SYSTEMS SHALL BE RUN THROUGH THEIR CYCLE TO CHECK FOR CORRECT WIRING AND SEQUENCING
- 1. CARRY OUT WORK IN ACCORDANCE WITH THE REQUIREMENTS OF THE
 ONTARIO BUILDING CODE, OCCUPATIONAL HEALTH AND SAFETY ACT AND
 REGULATIONS AND THE MINISTRY OF LABOUR GUIDELINES.
- CHECK AND VERIFY ALL DIMENSIONS AT THE SITE BEFORE PROCEEDING WITH ANY WORK.

 SHEET METAL WORK MUST BE PERFORMED BY LICENSED SHEET METAL
- AUTHORITY HAVING JURISDICTION.

 4. ALL SYSTEMS SHALL BE INSTALLED IN ACCORDANCE WITH CODE REQUIREMENT, AND TO ASHRAE AND SMACNA STANDARDS. ALL MATERIAL AND EQUIPMENT SHALL BE NEW. DUCTWORK SHALL BE OF GAUGES AS

WORKERS POSSESSING A VALID CERTIFICATE OF QUALIFICATION FROM

- AND EQUIPMENT SHALL BE NEW. DUCTWORK SHALL BE OF GAUGES AS OUTLINED BY SMACNA STANDARDS. EQUIPMENT TO BE AS OUTLINED ON THE DRAWINGS.
- 5. LOCATION OF DUCTWORK AND EQUIPMENT.
 5.1.INSTALL AS REQUIRED FOR PROPER INSTALLATION IN AVAILABLE SPACE
- AVOIDING. INTERFERENCE WITH ARCHITECTURAL AND STRUCTURAL MEMBERS AND WORK OF OTHER TRADES.

 5.2. PRESERVE HEADROOM AND KEEP OPENINGS AND PASSAGE WAYS
- CLEAR.

 5.3. DUCTS IN A NEAT MANNER, SYMMETRICAL WITH BUILDING LINES,
- LIGHTS, CEILING TILE PATTERN, ETC.

 5.4. DRAWINGS ARE DIAGRAMMATIC AND APPROXIMATE AND ARE SUBJECT
- TO REARRANGEMENT FOR PROPER INSTALLATION. DUCTWORK AND PIPING MAY BE SHOWN DISTORTED TO AVOID CONFUSION.
- 5.5. LOCATE DIFFUSERS AND GRILLES IN ACCORDANCE WITH LIGHTING AND OTHER CEILING DEVICES.5.6. PROVIDE ACCESS DOORS IN FINISHES WALLS AND CEILINGS FOR
- ACCESS TO CONCEALED DAMPERS, EQUIPMENT.

 5.7. MAINTAIN A CLEAN PREMISES INCLUDING REMOVAL OF SCRAPS AND
- INSTALLATION RELATED DEBRIS FROM AREA. LEAVE ENTIRE INSTALLATION IN A NEAT, CLEAN AND USABLE CONDITION.

 5.8. HOIST AND SET IN PLACE OF ALL FURNISHED HEATING, AIR
- CONDITIONING, EXHAUST AND MAKE-UP AIR EQUIPMENT, UNLESS OTHERWISE SPECIFIED. REVIEW HOISTING AND RIGGING PLAN WITH OWNER.
- 5.9. SUPPORT ALL DUCTWORK.
- 5.10. ALL DUCT JOINTS, SEAMS, FITTINGS, ETC. SHALL BE SEALED TO SEAL CLASS A, TO ENSURE WATER AND AIR TIGHTNESS WITH DUCT SEALANT CARLISLE DUCT-SEAL 321 OR EQUAL, APPLIED IN ACCORDANCE WITH MANUFACTURER'S RECOMMENDATIONS.
 5.11. USE DUCT SIZES AS SHOWN OR EQUIVALENT AS REQUIRED TO
- SUIT SITE CONDITIONS.

 5.12. DUCT CONNECTIONS TO ALL EQUIPMENT (EXCEPT EXHAUST FANS UNDER 150 CFM) IS TO BE COMPLETE WITH FLEXIBLE DUCT CONNECTORS, DURO-DYNE SUPER METAL-FAB OR EQUAL CONSISTING
- OF 3", 24 GAUGE GALVANIZED SHEET METAL FRAME WITH 6" WIDE FLEXIBLE NEOPRENE FABRIC TO UL STANDARDS.

 5.13. ALL OPERABLE THERMOSTATS AT BARRIER FREE HEIGHT OF 1100-mm ABOVE FINISHED FLOOR UNLESS OTHERWISE INDICATED.
- 5.14. DUCT INSULATION: PROVIDE INSULATION TYPES AND THICKNESS ACCORDING TO TABLES.5.15. FIRE/SMOKE DAMPERS: DYNAMIC FIRE DAMPERS SHALL BE U.L.C.

APPROVED AND INSTALLED AS PER MANUFACTURER'S REQUIREMENTS

AND IN ACCORDANCE WITH OBC REQUIREMENTS. VENTEX OR EQUAL.

- INSTALL WHERE SHOWN OR AS NOTED ON THE DRAWING.
- 5.16. LOCATE DIFFUSERS, GRILLES & REGISTERS TO SUIT LIGHTING AND CEILING PLAN.

SYSTEMS

5.17. PROVIDE FLEXIBLE CONNECTIONS BETWEEN ALL DUCTWORK AND VIBRATING EQUIPMENT, INCLUDING FANS.
5.18. VIBRATION ISOLATION HANGERS AND SUPPORTS SHALL BE USED TO INSTALL ALL VIBRATING EQUIPMENT, INCLUDING FANS. HYDRONIC


FAN SCHEDULE												
	AIR FLOW	ESP	FAN SPEED	MOTOR SPEED	MOTOR POWER	VOLTAGE	FLA	DIMENSIONS [L/W/H]	WEIGHT	BASIS OF DESIGN		
DESCRIPTION	[L/s]	[Pa]	[RPM]	[RPM]	[kW]	[V/Ph/Hz]	[A]	[mm]	[kg]	MAKE	MODEL	NOTES
L1 CLOAK ROOM EXHAUST	67	62	710		0.102	120/1/60	1.4	311/311/298		CARNES OR APPROVED EQUIVALENT	VCDD015C	WITH VXCBWK WEATHER HOOD C/W BACKDRAFT DAMPER AND BIRD SCREEN
L1 WASHROOM EXHAUST	283	144	2433		0.373	120/1/60	6.6	375/350/350	21.8	GREENHECK OR APPROVED EQUIVALENT	SQ-7-M1-VG	C/W BACKDRAFT DAMPER
BASEMENT STORAGE ROOM EXHAUST	283	144	2433		0.373	120/1/60	6.6	375/350/350	21.8	GREENHECK OR APPROVED EQUIVALENT	SQ-7-M1-VG	C/W BACKDRAFT DAMPER
BASEMENT ELECTRICAL ROOM EXHAUST	142	129	1551		0.124	120/1/60	2.8	400/375/375	15.4	GREENHECK OR APPROVED EQUIVALENT	SQ-90-VG	C/W BACKDRAFT DAMPER AND WITH VENTEX WHD-90-12 WEATHER HOOD C/W BIRD SCREEN

DUCTWORK MATERIALS SCHEDULE						
/ICE	MATERIAL	INSULATION	FINISH			
AUST	GALVANIZED - RECT OR SPIRAL	FIBERGLASS W/ FSK ON DISCHARGE OF EXHAUST FAN (MIN R-7.5)				

	DIFFUSER AND GRILLE SCHEDULE								
			AIR FLOW	NECK SIZE	DIMENSIONS [W/H]	WEIGHT			
AG	QUANTITY	DESCRIPTION	[L/s]	[mm]	[mm]	[kg]	MAKE	MODEL	NOTES
	AS INDICATED	EXHAUST GRILLE - CEILING	AS INDICATED		AS INDICATED		PRICE	530	45° DEFLECTION 3/4" BLADE SPACING

PLUMB	ING FIXTURE SPECIALTIES SCHEDULE
EQUIPMENT	SPECIFICATION
	ZURN Z556-FO-Y-P CAST IRON FLOOR DRAIN WITH A 213 mm (8 3/8") IN DIAM., 171 mm (6 3/4") IN DIAM. GRATE, ADJUSTABLE FRAME AND SEDIMENT BUCKET; ALL CAST IRON. TRAP PRIMER CONNECTION.

	PIPING MATERIALS SCHEDULE						
ERVICE	MATERIAL	INSULATION	FINISH				
HW/DCW/DHWR	COPPER TYPE 'L'	PRE-FORMED FIBREGLASS W/ ASJ	PVC (where exposed to mechanical damage)				
WS/HWR	CARBON STEEL - SCHED.40	PRE-FORMED FIBREGLASS W/ ASJ	PVC (where exposed to mechanical damage)				
ATURAL GAS	CARBON STEEL - SCHED.40		PAINTED YELLOW				

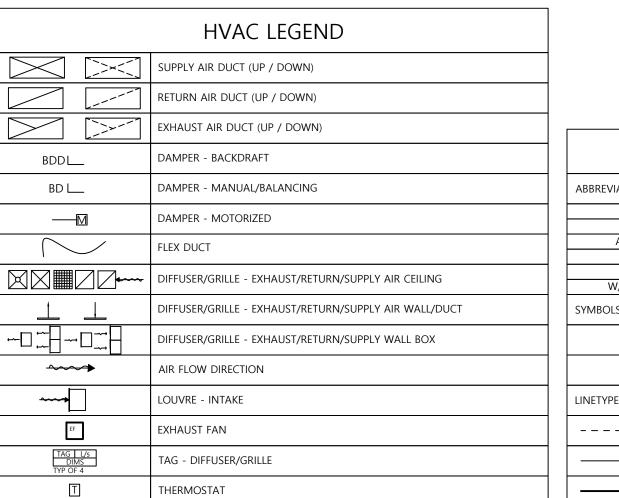

		SEAL	
	GENERAL LEGEND		
VIATIONS			
AFF, BFF	ABOVE FINISHED FLOOR, BELOW FINISHED FLOOR		
AFC, BFC	ABOVE FINISHED CEILING, BELOW FINISHED CEILING		
AFCT, BFCT	ABOVE FINISHED COUNTERTOP, BELOW FINISHED COUNTERTOP		
UON	UNLESS OTHERWISE NOTED		
TYP	TYPICAL		
W/, W/O, C/W	WITH, WITHOUT, COMPLETE WITH	DRAWINGS 1	· (
DLS		SITE: CLA	R
─ 65Ø	TAG - DIMENSION	161 L	SS
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'PES		TITLE: MEC	
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	EXISTING	N/A SCALE AT ARCH D	:
	· NEW	25130	
		PROJECT NO:	

SHEET	TLIST SCHEDULE
IUMBER	SHEET TITLE
1100	NOTES, LEGENDS AND SCHEDULES
1200	MECHANICAL BASEMENT LAYOUTS
1201	HVAC L1 LAYOUTS
1202	HVAC ROOF LAYOUTS
	· · · · · · · · · · · · · · · · · · ·

- CLIENT REVIEW - 50% 2025-04-08

REV. DESCRIPTION DATE

2025-06-09

HERITAGE PERMIT

JDX Advance Services Inc.
687 Barton Street, Suite 106
Stoney Creek, Ontario
289-329-0918 | www.JDXadvance.com

CLIENT: CHERIE NG ARCHITECT INC.

OWNER: CITY OF MISSISSAUGA
300 CITY CENTRE DRIVE
MISSISSAUGA, ON L5B 3C1

SEAL

DRAWINGS TO BE USED ONLY FOR INDICATED PURPOSES

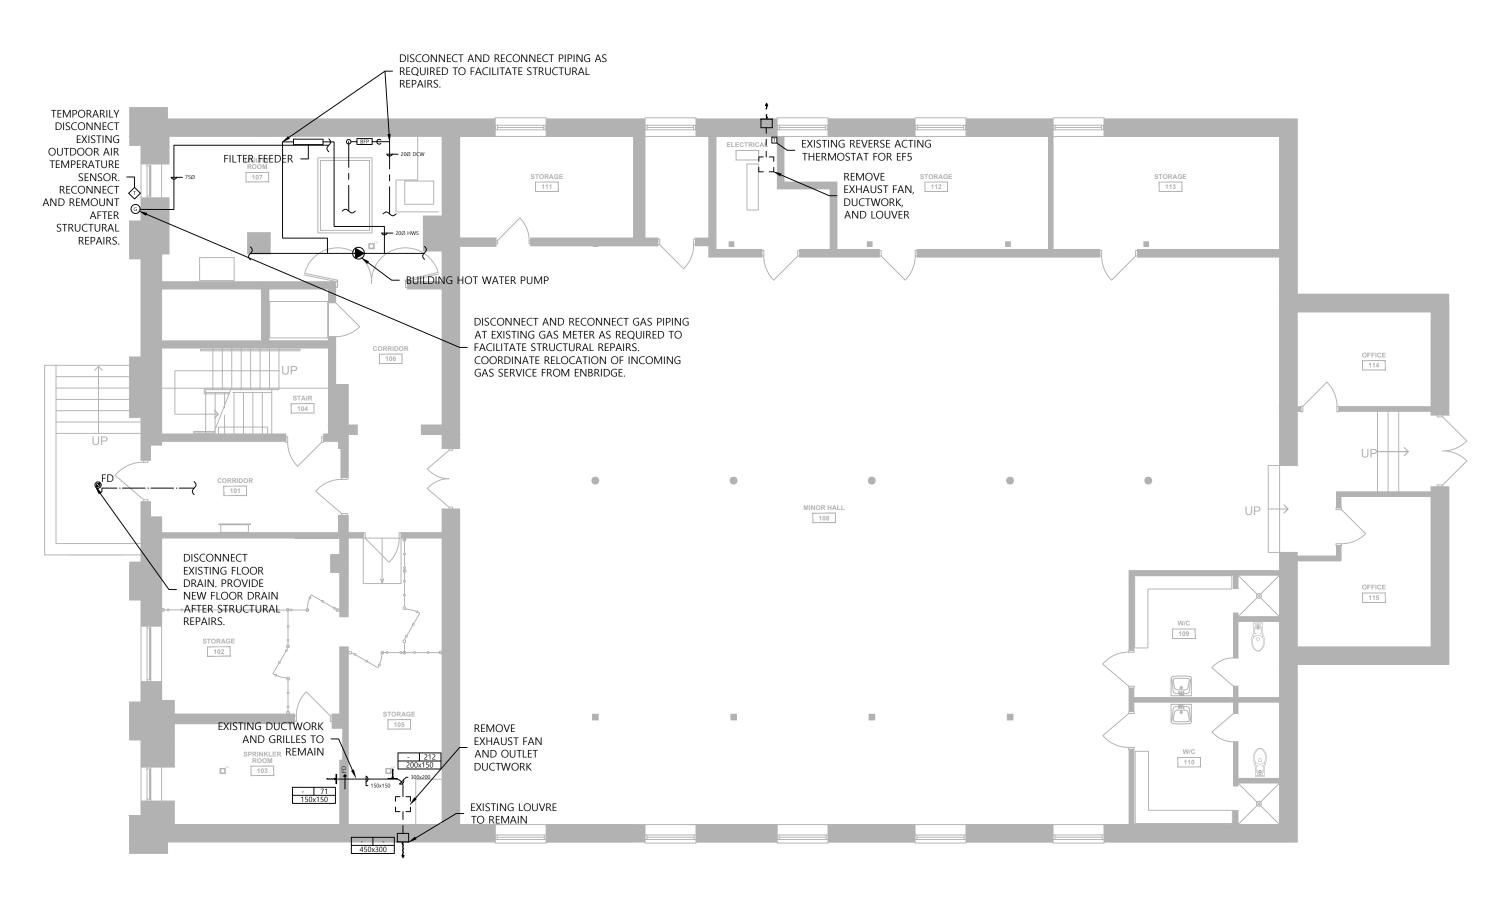
SITE: CLARKE MEMORIAL HALL
161 LAKESHORE RD W
MISSISSAUGA, ONTARIO L5H 1G3

PROJECT: CLARKE MEMORIAL HALL RENOVATION

TITLE: MECHANICAL
NOTES, LEGENDS AND SCHEDULES


DRAWING NO:

CHECKED:



BASEMENT MECHANICAL LAYOUT DEMO

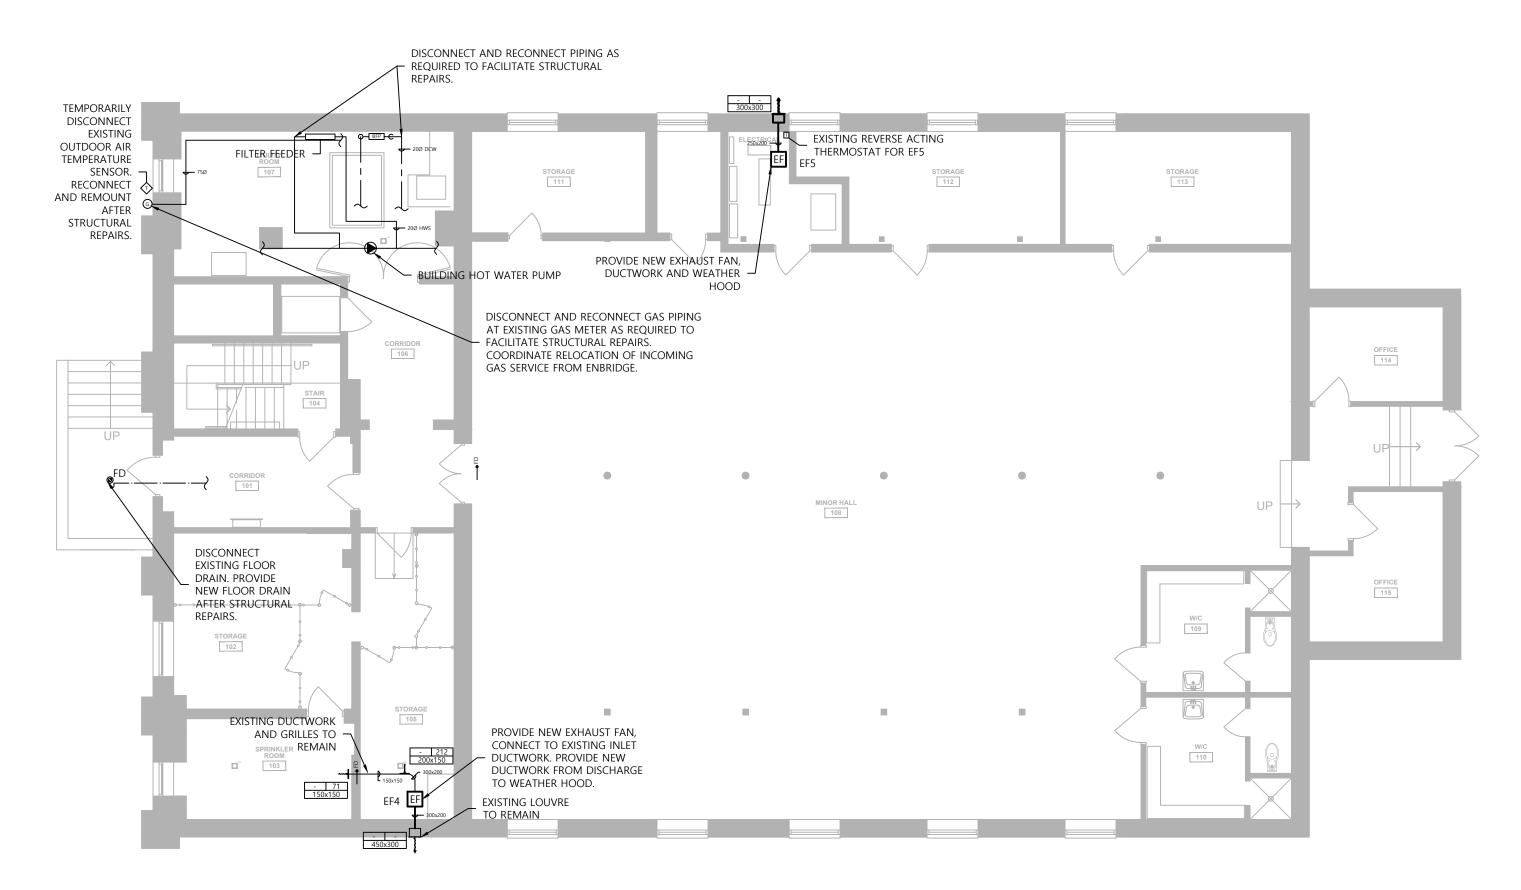1:100



BASEMENT MECHANICAL LAYOUT RETROFIT

A HERITAGE PERMIT 2025-06-09 CLIENT REVIEW - 50% 2025-04-08 REV. DESCRIPTION DATE

> JDX Advance Services Inc. 687 Barton Street, Suite 106 Stoney Creek, Ontario 289-329-0918 | www.JDXadvance.com

CLIENT: CHERIE NG ARCHITECT INC.

OWNER: CITY OF MISSISSAUGA 300 CITY CENTRE DRIVE MISSISSAUGA, ON L5B 3C1

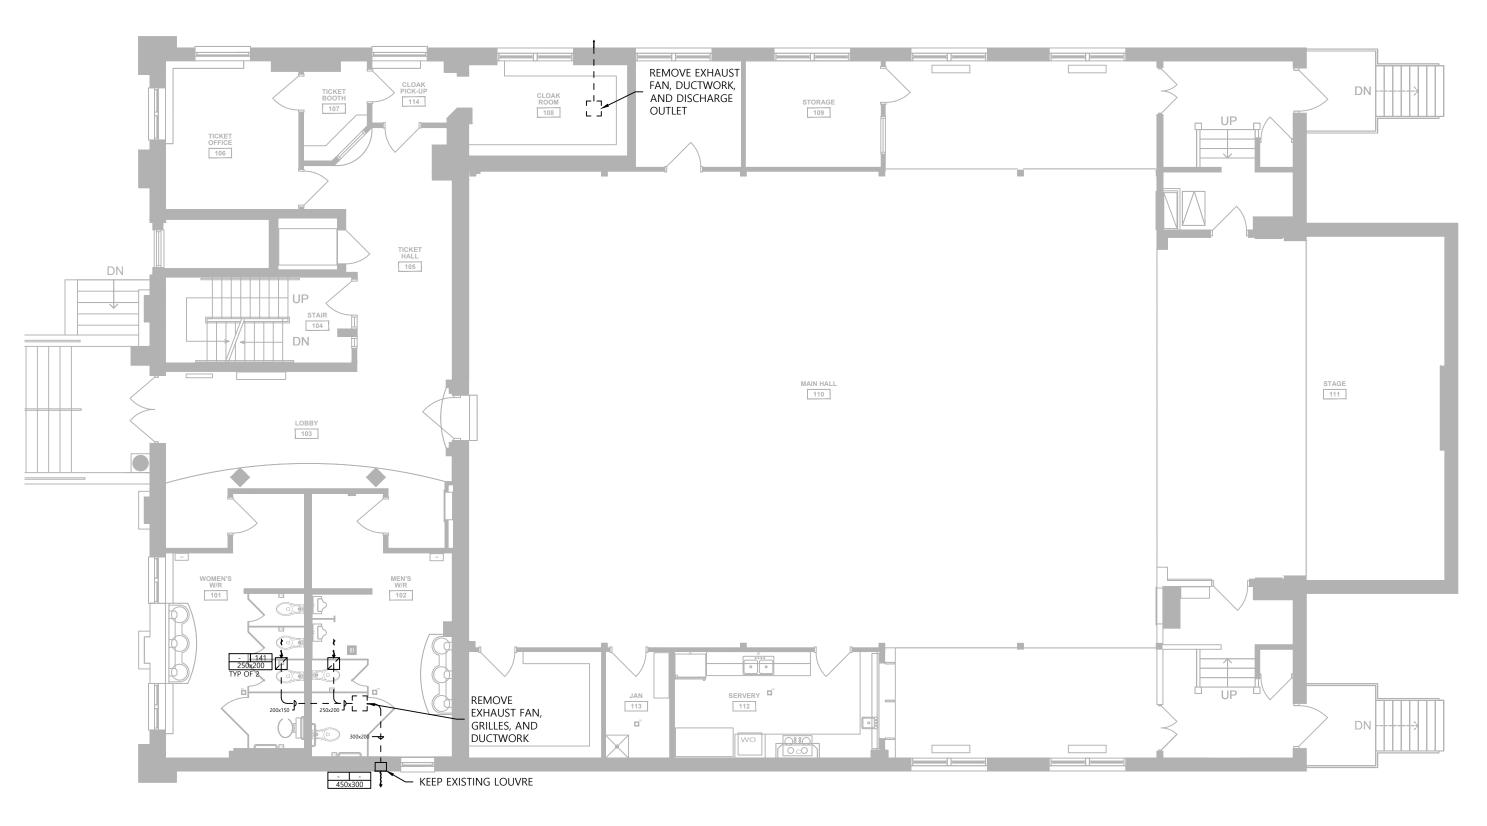
DRAWINGS TO BE USED ONLY FOR INDICATED PURPOSES CLARKE MEMORIAL HALL 161 LAKESHORE RD W MISSISSAUGA, ONTARIO L5H 1G3

PROJECT: CLARKE MEMORIAL HALL RENOVATION


TITLE: MECHANICAL
MECHANICAL BASEMENT LAYOUTS AS STATED CHECKED: SCALE AT ARCH D: 25130 PROJECT NO:

DRAWING NO:

REVISION:



L1 HVAC LAYOUT DEMO

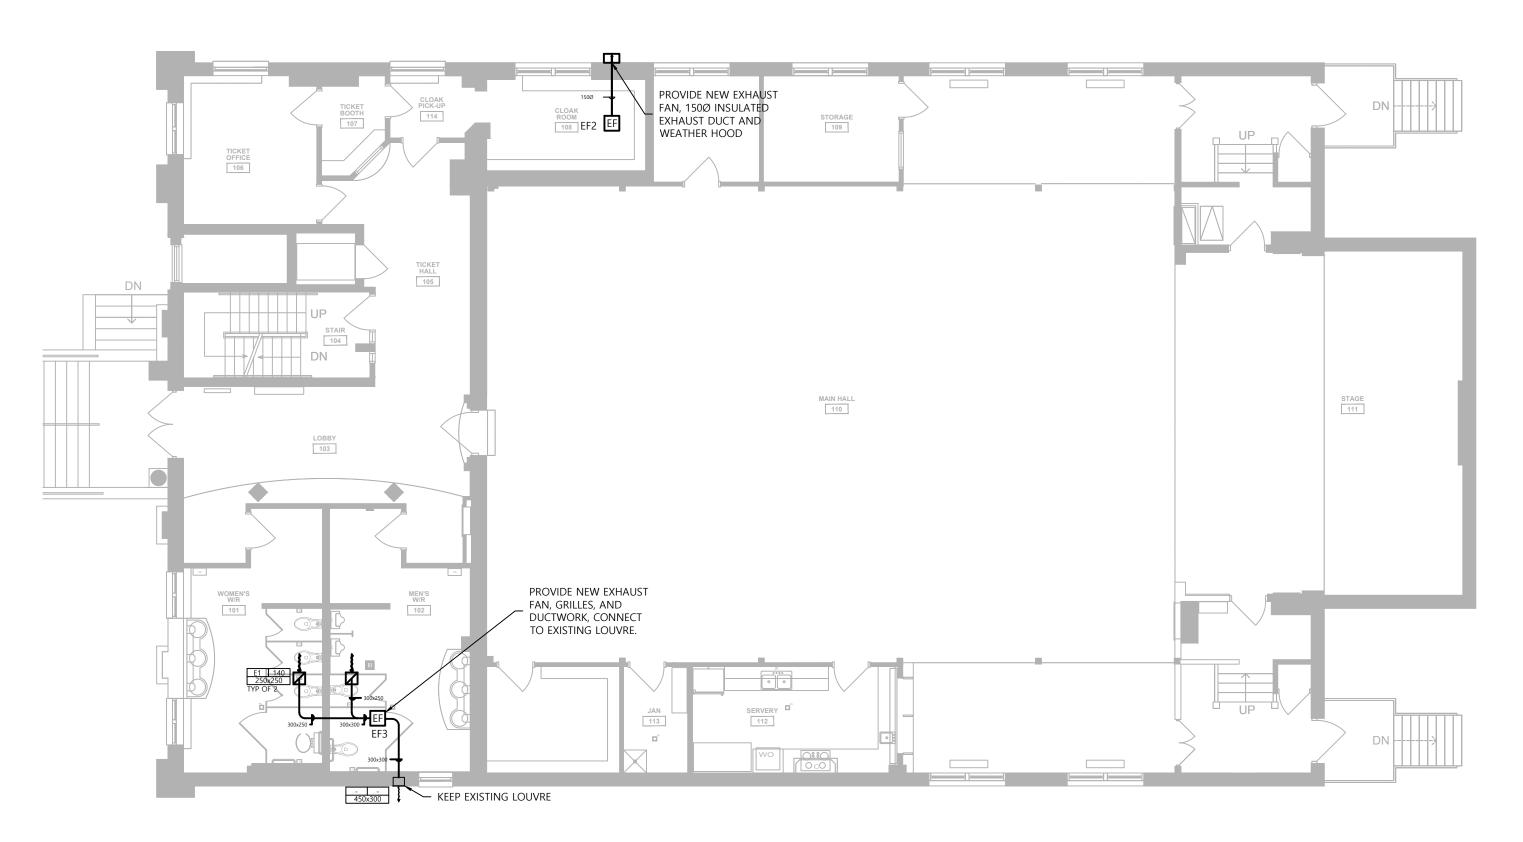

L1 HVAC LAYOUT RETROFIT

1:100

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OWNER: CITY OF MISSISSAUGA 300 CITY CENTRE DRIVE MISSISSAUGA, ON L5B 3C1

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SITE: CLARKE MEMORIAL HALL

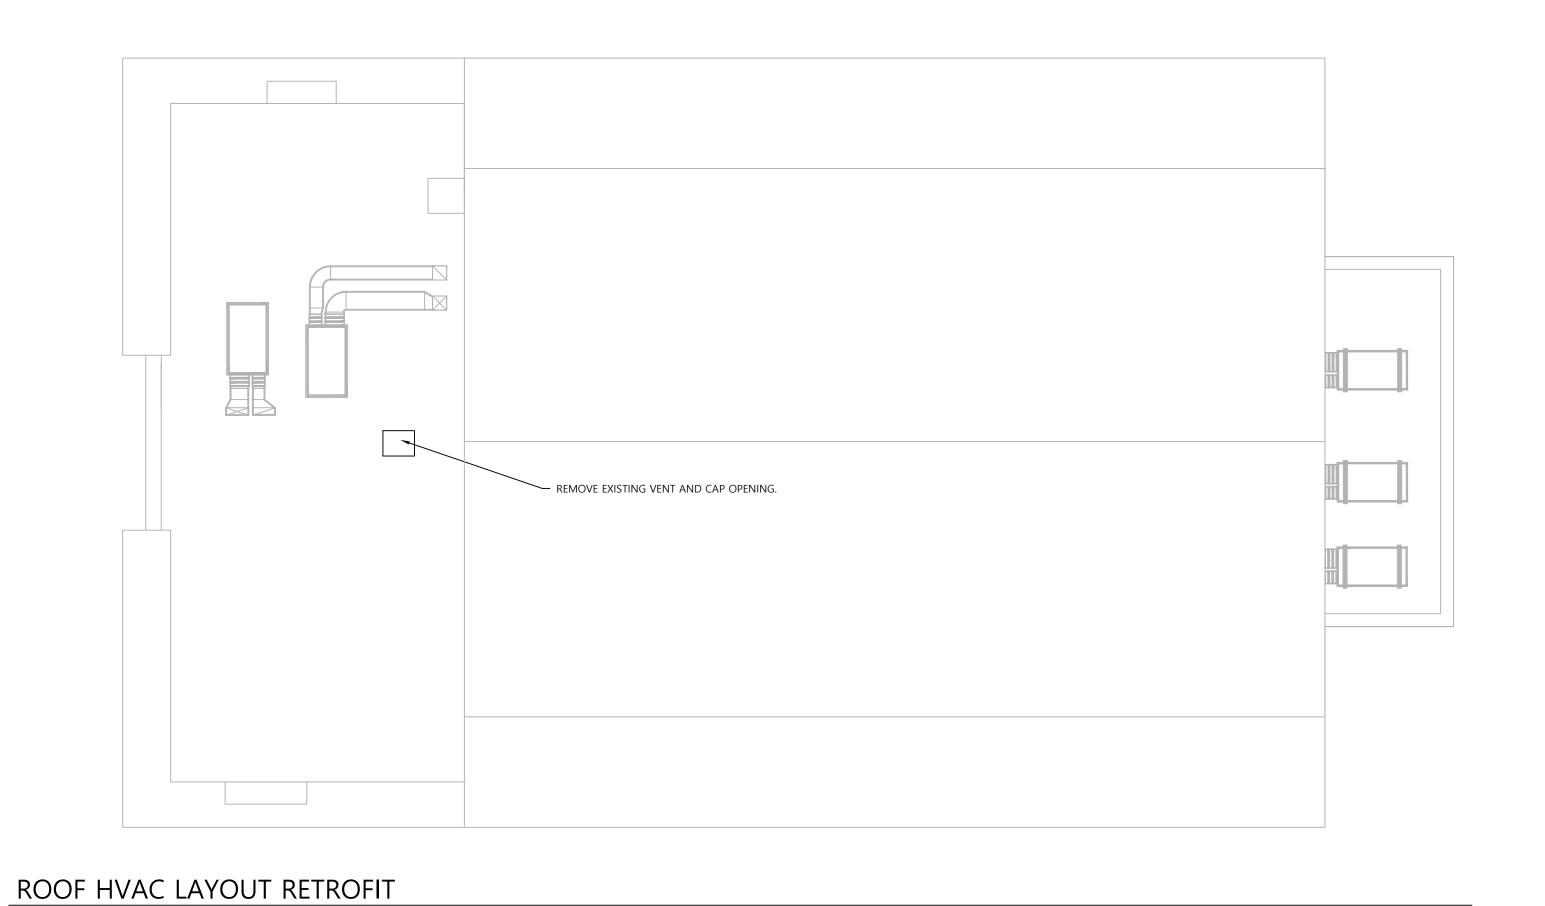
161 LAKESHORE RD W

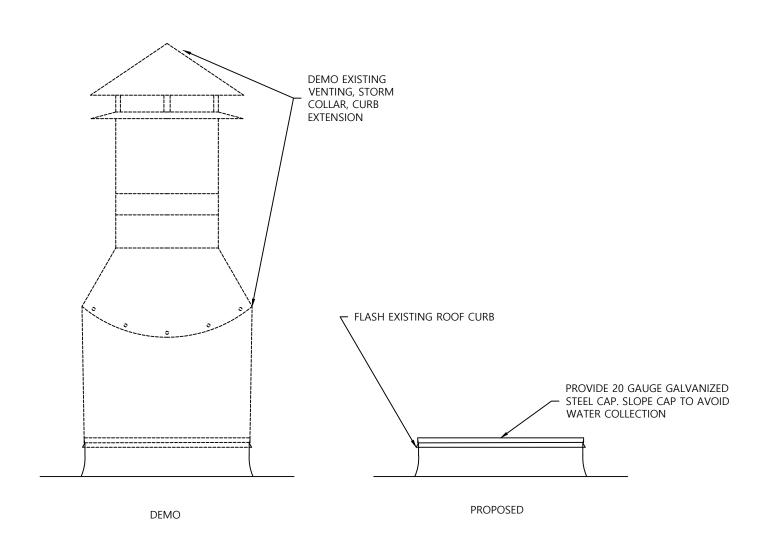
MISSISSAUGA, ONTARIO L5H 1G3

PROJECT: CLARKE MEMORIAL HALL RENOVATION

TITLE: MECHANICAL HVAC L1 LAYOUTS

AS STATED JD SCALE AT ARCH D: CHECKED: 25130 M20 project no: Drawing no: REVISION:





ROOF VENT DETAIL SCALE: NTS

A HERITAGE PERMIT 2025-06-09 2025-04-08 CLIENT REVIEW - 50% DATE REV. DESCRIPTION



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CLIENT: CHERIE NG ARCHITECT INC.

OWNER: CITY OF MISSISSAUGA
300 CITY CENTRE DRIVE
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drawings to be used only for indicated purposes SITE: CLARKE MEMORIAL HALL
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MISSISSAUGA, ONTARIO L5H 1G3

PROJECT: CLARKE MEMORIAL HALL RENOVATION

TITLE: MECHANICAL HVAC ROOF LAYOUTS AS STATED CHECKED: SCALE AT ARCH D: 25130 M20
PROJECT NO: DRAWING NO:

REVISION:

- 2. PERFORM WORK IN A CLEAN AND WORKMANLIKE MANNER. EXERCISE CARE TO DISRUPTION TO OTHER AREAS OF THE BUILDING WHICH ARE TO REMAIN IN OPERATION. ISOLATE WORK AREAS AS REQUIRED TO CONTAIN DUST AND DEBRIS WITHIN THE CONSTRUCTION AREA.
- B. THE DRAWINGS ARE INTENDED TO BE DIAGRAMMATIC AND ARE DEVELOPED ON THE INDICATED BASIS OF DESIGN EQUIPMENT. ALL ITEMS MAY NOT BE SHOWN OR NOT SHOWN IN THEIR EXACT LOCATION, OR WITH EXACT DIMENSIONS AND DETAILS. THE CONTRACTOR SHALL VERIFY THE ACTUAL DIMENSIONS OF THE EQUIPMENT PROPOSED TO ENSURE THAT THE EQUIPMENT WILL FIT IN THE AVAILABLE SPACE.
- 4. FIELD VERIFY ALL DIMENSIONS AND EXISTING CONDITIONS PRIOR TO PROCEEDING WITH ANY WORK. WHERE DISCREPANCIES OCCUR BETWEEN THESE DOCUMENTS AND EXISTING CONDITIONS, REPORT THE CONDITIONS AND/OR ENGINEER.
- 5. CONTRACTOR SHALL BE RESPONSIBLE FOR THE SAFEKEEPING OF THEIR OWN 16. WIRING DEVICES: INSTALL SWITCHES, RECEPTACLES, WIRING DEVICE, AND PROPERTY ON THE JOB SITE. OWNER ASSUMES NO RESPONSIBILITY FOR PROTECTION OF PROPERTIES
- 6. PRIOR TO STARTING CONSTRUCTION, DETERMINE EXACT INVERT ELEVATION, SIZE, DEPTH AND LOCATION OF EXISTING UTILITIES WHERE CONNECTIONS ARE TO BE MADE OR INTERSECTIONS OCCUR. NOTIFY ENGINEER OF ANY DISCREPANCY BETWEEN DRAWINGS AND ACTUAL FIELD CONDITIONS.
- 7. CONSTRUCT WORK TO ALL APPLICABLE CODES, LAWS AND REGULATIONS GOVERNING OR RELATING TO ANY PORTION OF THIS WORK. CORRECT ANY WORK IN VIOLATION OF ABOVE.

8. INSTALL OR ERECT PRODUCTS IN ACCORDANCE WITH MANUFACTURER'S

- INSTRUCTIONS. OBTAIN WRITTEN INSTRUCTIONS DIRECTLY FROM
- 9. PROVIDE AND MAINTAIN TEMPORARY FIRE PROTECTION DURING PERFORMANCE OF THE WORK.
- 10.INSTALL WORK SO AS TO BE READILY ACCESSIBLE FOR OPERATION, MAINTENANCE AND REPAIR. PROVIDE SLEEVES AND ACCESS DOORS
- REQUIRED FOR THE SERVICING OF CONCEALED EQUIPMENT. 11.REMOVE AND RELOCATE EXISTING WORK AS REQUIRED, NECESSARY FOR THE PERFORMANCE OF THE GENERAL WORK. ALL EXISTING CONDITIONS MAY NOT BE COMPLETELY DETAILED ON THE DRAWINGS. CONTRACTOR TO SURVEY THE SITE AND INCLUDE ALL CHANGES IN MAKING UP THE WORK
- PROPOSAL. 12. SEAL ALL OPENINGS AROUND CABLES AND CONDUITS THROUGH PARTITIONS AND WALLS WITH APPROVED FIRESTOPPING MATERIAL. REFER TO ARCHITECTURAL DRAWINGS FOR FIRE AND SMOKE SEAL RATINGS OF
- 13. CONSTRUCT WORK IN A MANNER SATISFACTORY TO THE OWNER. 14.CLEAN FROM ALL FIXTURES AND EQUIPMENT DUST, DIRT, FINGER-PRINTS,
- TOUCH UP SURFACES OF SHOP-PAINTED EQUIPMENT SCRATCHED OR MARRED DURING SHIPMENT OR INSTALLATION, TO MATCH ORIGINAL 15. COORDINATE WORK OF OTHER TRADES (MECHANICAL, SPRINKLER,

PAINT GREASE CONSTRUCTION AND DEMOLITION DERRIS CLEAN AND

- STRUCTURAL, ETC.). ENSURE THAT PROPER ARRANGEMENTS AND PROVISIONS ARE MADE FOR THIS WORK. COORDINATE ELECTRICAL REQUIREMENTS OF ALL OWNER-SUPPLIED EQUIPMENT PRIOR TO ROUGH-IN.
- 1. THE CONTRACTOR SHALL SECURE ALL PERMITS OR APPLICATIONS AND PAY ANY AND ALL FEES.
- EQUIPMENT AND WIRING . MATERIALS AND EQUIPMENT: ALL ELECTRICAL PRODUCTS SHALL BE TESTED, CERTIFIED, AND LABELED IN ACCORDANCE WITH A CERTIFICATION PROGRAM ACCREDITED BY THE STANDARDS COUNCIL OF CANADA, CSA. WHERE A PRODUCT IS NOT SO LABELED, PROVIDE WRITTEN APPROVAL BY THE AUTHORITY HAVING JURISDICTION. WHERE CSA CERTIFIED MATERIAL AND/OR EQUIPMENT IS NOT AVAILABLE, OBTAIN SPECIAL APPROVAL FROM AUTHORITY HAVING JURISDICTION.
- 2. MOTORS, ELECTRIC HEATING, CONTROLS AND DISTRIBUTION DEVICES AND EQUIPMENT TO OPERATE SATISFACTORILY AT 60HZ WITHIN NORMAL OPERATING LIMITS ESTABLISHED BY CAN3-C235 (PREFERRED VOLTAGE LEVELS FOR AC SYSTEMS, 0 TO 50,000V). EQUIPMENT TO OPERATE IN EXTREME OPERATING CONDITIONS ESTABLISHED IN ABOVE STANDARD AT 40°C AMBIENT WITHOUT DAMAGE TO EQUIPMENT.
- 3. VERIFY INSTALLATION AND COORDINATION RESPONSIBILITIES RELATED TO BY MECHANICAL CONTRACTOR UNLESS NOTED OTHERWISE.
- 4. WARNING SIGNS ARE TO BE INSTALLED IN ACCORDANCE WITH REQUIREMENTS OF AUTHORITY HAVING JURISDICTION. 5. WIRING AND RACEWAYS:
- 5.1. CONDUCTORS TO BE COPPER, MINIMUM SIZE: 12 AWG. ACCORDANCE WITH LATEST ELECTRICAL CODE.
- 5.3. ARMOURED CABLES (AC90) SHALL ONLY BE USED FOR FINAL CONNECTIONS TO LIGHT FIXTURES IN LENGTH NOT EXCEEDING 8', AND FOR RUNS CONCEALED IN STEEL PARTITIONS. PROVIDE SUFFICIENT JUNCTION BOXES AT CEILING TO MAINTAIN NEAT CEILING SPACE AND KEEP EXPOSED ARMOURED CABLES LESS THAN 8' IN LENGTH. 5.4. MINIMUM CONDUIT SIZE: 3/4" EMT OR OF TYPE APPROVED FOR
- INTENDED USE AND AREA INSTALLED. 5.5. INSTALL CONDUITS TO CONSERVE HEADROOM IN EXPOSED LOCATIONS AND CAUSE MINIMUM INTERFERENCE IN SPACES THROUGH WHICH THEY
- 5.6. CONCEAL CONDUITS EXCEPT IN UNFINISHED AREAS. RUN PARALLEL OR PERPENDICULAR TO BUILDING LINES.
- 5.7. PROVIDE BOXES AND FITTINGS SUITABLE FOR INTENDED USE AND AREA INSTALLED. 5.8. ENSURE LUGS, TERMINALS, SCREWS USED FOR TERMINATION OF WIRING
- ARE SUITABLE FOR EITHER COPPER OR ALUMINUM CONDUCTORS. 5.9. BOND AND GROUND AS REQUIRED TO LATEST EDITION OF ONTARIO ELECTRICAL SAFETY CODE.
- 6. IDENTIFY ELECTRICAL EQUIPMENT WITH LAMACOID NAMEPLATES (3MM THICK PLASTIC ENGRAVING SHEET, MATTE WHITE FINISH FACE, BLACK CORE). WORDING ON NAMEPLATE TO BE APPROVED BY CONSULTANT PRIOR TO MANUFACTURE.
- 7. COLOUR CODE CONDUITS, BOXES, AND METALLIC SHEATHED CABLES. CODE WITH PLASTIC TAPE OR PAINT - INSIDE BOXES IN AREAS WITH EXPOSED CEILINGS AND IN FINISHED AREAS; AT POINTS WHERE CONDUITS OR CABLES ENTERS WALL, CEILING, OR FLOOR, AND AT 50' INTERVALS: YELLOW FOR 600V; BLUE FOR 208V; RED FOR FIRE ALARM, AND NONE FOR
- 8. CONFIRM FINISHES OF EQUIPMENT DURING SHOP DRAWING SUBMITTALS. 9. MOUNTING HEIGHT OF EQUIPMENT IS FROM FINISHED FLOOR TO CENTRELINE OF EQUIPMENT UNLESS SPECIFIED OR INDICATED OTHERWISE. CONFIRM ALL HEIGHTS WITH LOCAL INSPECTORS PRIOR TO ROUGH-IN TO ENSURE THEY MEET LOCAL INTERPRETATION OF CODE. 9.1. LOCAL SWITCHES: 43"
- 9.2. WALL RECEPTACLES: 12" OR MATCH EXISTING 9.3. WALL RECEPTACLES ABOVE TOP OF COUNTERS OR COUNTER SPLASH
- 9.4. WALL RECEPTACLES IN MECHANICAL ROOMS: 43"

9.9. MANUAL PULL STATIONS: 47"

- 9.5. PANEL BOARDS: AS REQUIRED BY CODE 9.6. TELEPHONE AND DATA OUTLETS: 12" OR MATCH EXISTING
- 9.7. OPERATOR PUSHBUTTONS: 43" (CONFIRMED WITH BUILDING INSPECTOR) 9.8. THERMOSTATS: 43"
- 9.10. VISUAL SIGNAL DEVICES : TOP OF DEVICE 94" AFF WHERE CEILING HEIGHTS ALLOW, ELSE TOP OF
- 9.11. DEVICE 6" BELOW CEILING (ENTIRE LENS FOR VISUAL SIGNAL COMPONENT MUST BE BETWEEN 79" AND 94" AFF).
- 9.12. END OF LINE RESISTORS: TOP OF DEVICE 70" AFF. 9.13. EMERGENCY TELEPHONE HANDSETS: 53-59" AFF CONFIRMED WITH LOCAL BUILDING OFFICIAL
- 10.PRIOR TO ROUGH-IN LOCATE ADJACENT OUTLET BOXES 6" APART UNLESS NOTED OTHERWISE (DO NOT SCALE DRAWINGS).
- 11. COORDINATE WITH ENGINEER, OWNER MAY CHANGE LOCATION OF OUTLETS PRIOR TO INSTALLATION WITH NO CHANGE TO CONTRACT PRICE, PROVIDED DISTANCE DOES NOT EXCEED 10' FROM ORIGINAL LOCATION. 12.MECHANICAL EQUIPMENT CONNECTIONS: PROVIDE CONNECTIONS TO
- MECHANICAL EQUIPMENT AS PER DRAWINGS 13.PROVIDE CONDUIT ROUGH-IN FOR MECHANICAL CONTROLS AS PER MECHANICAL EQUIPMENT SCHEDULE.
- 14.COORDINATE MECHANICAL POWER AND CONTROL WIRING REQUIREMENTS PRIOR TO ROUGH-IN.
- 15. HANGERS AND SUPPORTS: INSTALL FASTENING AND SUPPORTS AS REQUIRED FOR EACH TYPE OF EQUIPMENT, CABLES, AND CONDUITS, IN ACCORDANCE WITH MANUFACTURER'S INSTALLATION
- RECOMMENDATIONS. 15.1. SECURE EQUIPMENT TO HOLLOW MASONRY, TILE AND PLASTER SURFACES WITH LEAD ANCHORS

15.2. SECURE EQUIPMENT TO POURED CONCRETE WITH EXPANDABLE

- 15.3. SECURE EQUIPMENT TO HOLLOW MASONRY WALLS OR
- SUSPENDED CEILINGS WITH TOGGLE BOLTS 15.4. FASTEN EXPOSED CONDUIT OR CABLES TO BUILDING
- CONSTRUCTION OR SUPPORT SYSTEM USING STRAPS 15.5. FOR SURFACE MOUNTING OF TWO OR MORE CONDUITS USE
- 15.6. PROVIDE METAL BRACKETS, FRAMES, HANGERS, CLAMPS, AND RELATED TYPES OF SUPPORT STRUCTURES WHERE INDICATED OR AS REQUIRED TO SUPPORT CONDUIT AND CABLE RUNS.
- ENSURE ADEQUATE SUPPORT FOR RACEWAYS AND CABLES DROPPED VERTICALLY TO EQUIPMENT WHERE THERE IS NO SUPPORT
- 15.8. DO NOT USE SUPPORTS OR EQUIPMENT INSTALLED FOR OTHER TRADES FOR CONDUIT OR CABLE SUPPORT EXCEPT WITH PERMISSION OF
- OTHER TRADES AND APPROVAL OF ENGINEER. COVERS FLUSH AND LEVEL WITH BUILDING LINES, ENSURE THAT OUTLET
- BOXES ARE CLEAN PRIOR TO INSTALLING DEVICES. SWITCHES, RECEPTACLES, AND WIRING DEVICES TO BE SPECIFICATION GRADE, DECORA STYLE, DEVICE COLOUR TO BE
- DETERMINED DURING SHOP DRAWING REVIEW. 16.2. COVER PLATES TO BE WHITE. THERMOPLASTIC COVER PLATE TO MATCH DEVICE COLOUR MAY BE SELECTED DURING SHOP DRAWING
- REVIEW STAGE. 17.LOAD BALANCING: MEASURE PHASE CURRENT TO PANELBOARD WITH NORMAL LOADS (LIGHTING) OPERATING AT TIME OF ACCEPTANCE;
- BALANCE OF CURRENT BETWEEN PHASES AND RECORD CHANGES. MEASURE PHASE VOLTAGES AT 18.LOADS AND ADJUST TRANSFORMER TAPS TO WITHIN 2% OF RATED

ADJUST BRANCH CIRCUIT CONNECTIONS AS REQUIRED TO OBTAIN BEST

- VOLTAGE OF EQUIPMENT. PROVIDE LOAD BALANCE REPORT AT END OF 19.MEGGER TEST: PROVIDE MEGGER TEST (1000V) OF UNDERGROUND
- SECONDARY CONDUCTORS PRIOR TO ENERGIZING SERVICE. ENGINEER TO 20.FUSES: PROVIDE CLASS J, TIME DELAY FUSES IN ALL FUSED DISCONNECT SWITCHES. ENSURE CORRECT FUSES FITTED TO PHYSICALLY MATCH
- 21.PANELBOARDS: MAINS, NUMBER OF CIRCUITS, AND NUMBER AND SIZE OF BRANCH CIRCUIT BREAKERS, WITHSTAND CURRENT, AS INDICTED ON PANEL SCHEDULES. PANELBOARDS MUST BE SHIPPED WITH HINGED AND LOCKABLE DOORS. BREAKERS ARE TO BE BOLT-ON THERMAL AND MAGNETIC TRIPPING EXCEPT AS INDICATED OTHERWISE. PROVIDE LOCK-ON DEVICES FOR FIRE ALARM, EMERGENCY, STAIRWAY, AND EXIT
- CIRCUITS. REFER TO SINGLE-LINE DIAGRAM AND RELATED NOTES FOR ADDITIONAL EQUIPMENT REQUIREMENTS. 22.INSTALL PANEL BOARDS ON G1S PAINTED PLYWOOD BACKBOARDS. 23.DISCONNECT SWITCHES: PROVIDE FUSIBLE HEAVY-DUTY DISCONNECT
- BY THREE LOCKS, AND MECHANICALLY INTERLOCKED DOOR. 24.CONDUCTOR RUNS WITH ANY PORTION OUTDOORS AND/OR
- UNDERGROUND TO BE RWU90. ALL OTHER RUNS RW90. 25.PROVIDE SEPARATE INSULATED BONDING CONDUCTOR IN EACH CONDUIT REGARDLESS OF CONDUIT MATERIAL. SIZE BONDING CONDUCTORS TO

SWITCHES WITH PROVISION FOR PADLOCKING IN ON-OFF SWITCH POSITION

- 26.CIRCUIT BREAKERS 400A AND LARGER TO HAVE ADJUSTABLE LSI TRIP
- 27.PROVIDE GROUNDING AND BONDING AS REQUIRED BY OESC, ELECTRIC UTILITY, AND EQUIPMENT MANUFACTURERS, INCLUDING BUT NOT LIMITED TO GROUNDING RODS AND GROUNDING ARRAY AT UTILITY
- 28.PERFORM ARC-FLASH HAZARD ANALYSIS AND PROVIDE ARC-FLASH WARNING LABELS ON ALL ELECTRICAL COMPONENTS RATED 60A OR GREATER. HAZARD ANALYSIS TO BE PERFORMED BY LICENSED PROFESSIONAL ENGINEER IN ONTARIO. SUBMIT ENGINEER'S REPORT. 29.PERFORM PROTECTIVE DEVICE COORDINATION STUDY TO ENSURE COORDINATION BETWEEN PROTECTIVE DEVICES. ANALYSIS TO BE PERFORMED BY LICENSED PROFESSIONAL ENGINEER IN ONTARIO. SUBMIT
- ENGINEER'S REPORT. ADJUST DEVICE TRIP SETTINGS BASED ON REPORT MOTORS, EQUIPMENT AND CONTROLS. CONTROL WIRING TO BE PROVIDED

 30.ELECTRICAL DISTRIBUTION COMPONENTS TO BE FROM ONE OF THE FOLLOWING MANUFACTURERS: EATON, SCHNEIDER, SIEMENS.

31.PROVIDE MINIMUM 3 INCH HIGH CONCRETE HOUSEKEEPING PADS FOR ALL

MOUNTING HEIGHT

DESCRIPTION

ED VAPOR-TIGHT STRIP LIGHT

FLOOR MOUNTED ELECTRICAL EQUIPMENT. 32.UTILITY TRANSFORMER AND PRIMARY WIRING BY ELECTRIC UTILITY. CONTRACTOR TO PROVIDE SECONDARY DUCT BANK, SECONDARY CONDUCTORS, TRANSFORMER BASE, AND OTHER ACCESSORIES REQUIRED

OLTAGE (V): 120 / 240			ENCLOSU	RE TYPE:	42 SLOT	
HASES:	1 φ 3 W			MOUNTIN	IG:	SURFACE	
MAINS (A):	100 A MCB			PANEL RA		100 A	
IC (A):	10000			NOTES:	107 UTILI	TY ROOM	
CCT NO	DESCRIPTION	TRIP AMPS	POLE	POLE	TRIP AMPS	DESCRIPTION	CCT NO
A-1	EM	15	1	1	15	EM	A-2
A-3	EM	15	1	1	15	EM	A-4
A-5	ELEVATOR ROOM GFCI	15	1	1	20	OUTDOOR RECP	A-6
A-7	ACCESS CONTROL PANEL	15	1	1	15	EXISTING UNLABELLED	A-8
A-9	PUMPS	15	1	1	20	ALLEY/REAR LIGHTS	A-10
A-11,13	SYSTEM PUMP	20	2	1	15	TEMP HEATER	A-12
A-11,13	SYSTEM PUMP	20	2	1	15	TEMP HEATER	A-14
A-15,17	EXISTING UNLABELLED	40	2	1	15	EXTERIOR LIGHTS	A-16
A-15,17	EXISTING UNLABELLED	40	2	1	15	EXTERIOR LIGHTS	A-18
A-19	FMC	15	1	1	15	TEMP HEATER	A-20
A-21	FMC	15	1	1	15	EXISTING UNLABELLED	A-22
A-23	EMS	15	1	1	15	EXISTING UNLABELLED	A-24
A-25	ELEVATOR PIT LIGHT	15	1	1	15	EXISTING UNLABELLED	A-26
A-27	EXISTING UNLABELLED	20	1	1	20	OUTSIDE SIGN (5MA GFI BREAKER)	A-28
A-29	ELEVATOR PIT GFCI	20	1	1	15	OUTSIDE RECP	A-30
A-31	BOILER	20	1	2	20	HTR	A-32,34
A-33,35	HTR	20	2	2	20	HTR	A-32,34
A-33,35	HTR	20	2	2	20	HTR	A-36,38
A-37	103 LOBBY PDO	15	1	2	20	HTR	A-36,38
A-39	SPARE	15	1	1	0	SPACE	A-40
A-41	SPARE	15	1	1	0	SPACE	A-42

			PAN	EL RP			
VOLTAGE (V): 120 / 240			ENCLOSU	RE TYPE:	24 SLOT	
PHASES:	1 φ 3 W			MOUNTIN	IG:	SURFACE	
MAINS (A):	100 A MLO			PANEL RA	TING (A):	100 A	
AIC (A):	0			NOTES:	113 JANIT	OR ROOM	
CCT NO	DESCRIPTION	TRIP AMPS	POLE	POLE	TRIP AMPS	DESCRIPTION	CCT NO
RP-1	BLANK	0	1	1	0	BLANK	RP-2
RP-3	BLANK	0	1	1	15	WINDOW OPERATOR	RP-4
RP-5	HOOD VENT	15	1	1	15	PLUG #4 BOTTOM	RP-6
RP-7	PLUG #10 BOTTOM	15	1	1	15	PLUG #4 TOP	RP-8
RP-9	PLUG #9 BOTTOM	15	1	1	15	PLUG #2 BOTTOM	RP-10
RP-11	PLUG #9 TOP	15	1	1	15	PLUG#2 TOP	RP-12
RP-13	UNDER BAR LOWER SECTION	15	1	1	15	PLUG #5 BOTTOM	RP-14
RP-15	PLUG #6,7 MICROWAVE	15	1	1	15	PLUG #5 TOP	RP-16
RP-17	PLUG #8 BOTTOM	15	1	1	15	PLUG #3 TOP	RP-18
RP-19	PLUG #8 TOP	15	1	1	15	PLUG #3 BOTTOM	RP-20
RP-21,23	STOVE	40	2	1	20	PLUG #1 TOP	RP-22
RP-21,23	STOVE	40	2	1	20	PLUG #1 BOTOM	RP-24

NOTE

EXTERIOR LIGHTING FIXTURE SCHEDULE

BJTAKE

ES	ELECTRICAL STRIKE	
CR	CARD READER	
DC	DOOR CONTACT	
FDC	FIRE DOOR CLOSER	
КР	SECURITY KEYPAD	
WO PO	WAVE / PUSH TO OPEN	
WL PL	WAVE / PUSH TO LOCK	
PDO	POWER DOOR OPERATOR	
RX	REQUEST TO EXIT	
RXM	REQUEST TO EXIT MOTION SENSOR	
AT	ALARM AND TIMER	
ML	MAGNETIC LOCK	
EPS EPB	EMERGENCY PANIC STRIP / BUTTON	
	SECURITY CAMERA	

SECURITY SYMBOLS

LIGHTING SYMBOLS LEGEND						
SPACE LIGHTING						
\$	WALL MOUNTED SINGLE POLE SWITCH					
\$ os	WALL MOUNTED SINGLE POLE SWITCH W/ OCCUPANCY SENSOR					
\$ □	WALL MOUNTED SINGLE POLE SWITCH W/ DIMMING					

PC	OWER DISTRIBUTION LEGEND	
\bigcirc	120V-15A, 1Φ-2W GROUNDED DUPLEX RECEPTACLE, WALL MOUNTED	1
	120V-15A, 1Φ-2W GROUNDED DUPLEX RECEPTACLE, IN COMMON FLUSH BOX, FLOOR MOUNT UON	CLIE
•	120V-15A, 1Φ-3W GROUNDED DOUBLE DUPLEX RECEPTACLE IN COMMON BOX, WALL MOUNTED	1
	120V-15A, 1Φ-3W GROUNDED DOUBLE DUPLEX RECEPTACLE, IN COMMON FLUSH BOX, FLOOR MOUNT UON	OW
•	120V, AMPACTY PER CIRCUIT, 1Φ-3W GROUNDED DUPLEX RECEPTACLE, WALL MOUNTED	SEA
•	208/240V-15A, 1Φ-3W GROUNDED DUPLEX RECEPTACLE, WALL MOUNTED	SEA
•	208/240V, AMPACITY PER CIRCUIT, 1Φ-3W GROUNDED DUPLEX RECEPTACLE, WALL MOUNTED	1
\bigcirc	POWER DIRECT CONNECTION TO EQUIPMENT AS INDICATED]
	POWER PANEL SURFACE MOUNTED]
	POWER PANEL RECESSED MOUNTED]
	DISTRIBUTION BOARD]
	DISCONNECT SWITCH - FUSED, NON-FUSED	SITE
- -	SWITCH, NON-FUSED] [
- ¢	TRANSFER SWITCH	PRO
15A 1P	CIRCUIT BREAKER	TITL
-0 15A 1P	SWITCH, FUSED]
→	CONDUIT RUN TO PANEL] SCA

ELECTRICAL FEEDER FROM UPSTREAM ELECTRICAL SERVICE

_				
	1			
		A	HERITAGE PERMIT	2
	ı	IΑ	I MEKITAGE PEKIVITI	ı /

SHEET LIST SCHEDULE

NOTES, LEGENDS AND SCHEDULES

POWER BASEMENT LAYOUTS

SHEET TITLE

POWER L1 LAYOUTS

SLD

2025-06-09 CLIENT REVIEW - 50% 2025-04-08 REV. DESCRIPTION DATE

> JDX Advance Services Inc. 687 Barton Street, Suite 106 Stoney Creek, Ontario 289-329-0918 | www.JDXadvance.com

CHERIE NG ARCHITECT INC.

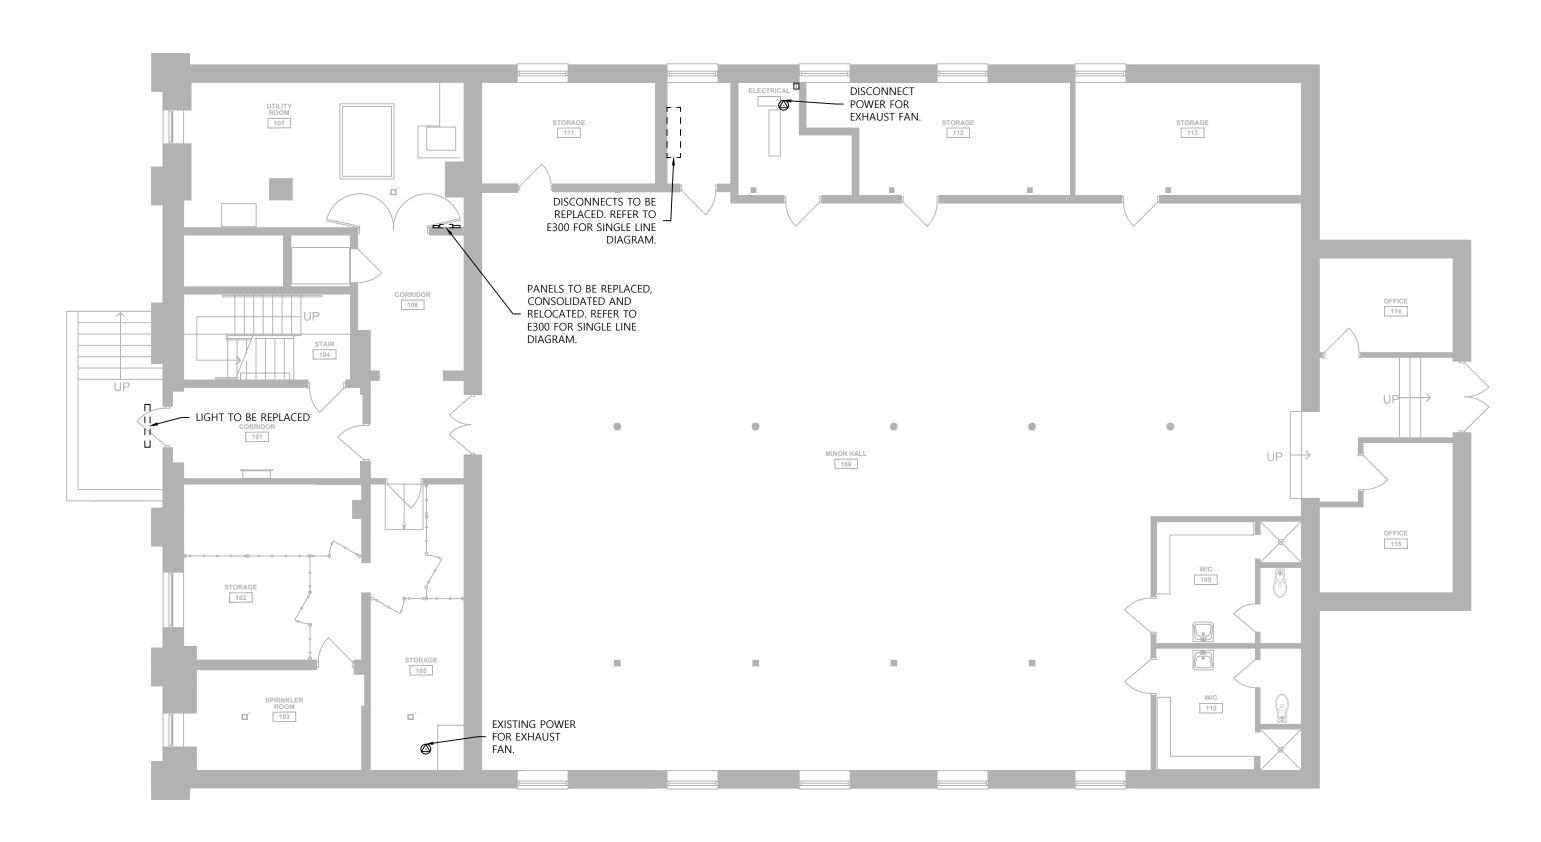
WNER: CITY OF MISSISSAUGA 300 CITY CENTRE DRIVE MISSISSAUGA, ON L5B 3C1 DRAWINGS TO BE USED ONLY FOR INDICATED PURPOSES CLARKE MEMORIAL HALL

161 LAKESHORE RD W MISSISSAUGA, ONTARIO L5H 1G3 OJECT: CLARKE MEMORIAL HALL RENOVATION

TLE: ELECTRICAL NOTES, LEGENDS AND SCHEDULES SCALE AT ARCH D: CHECKED:

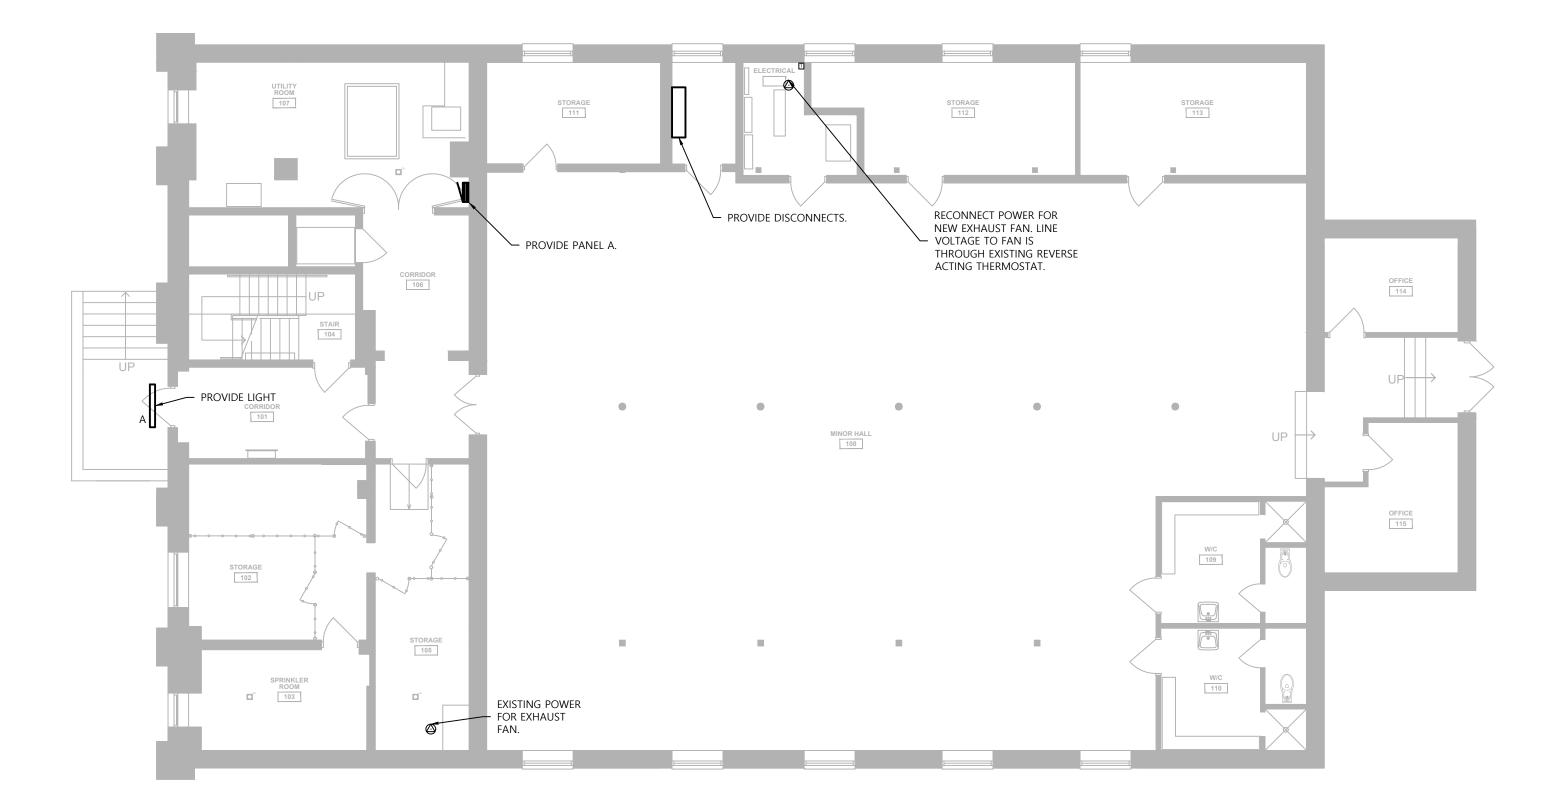
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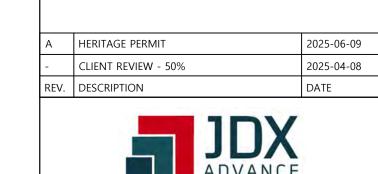


BASEMENT POWER LAYOUT DEMO

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BASEMENT POWER LAYOUT RETROFIT

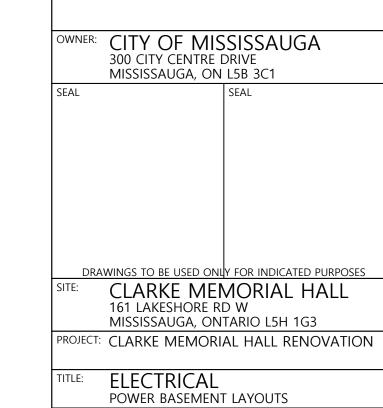


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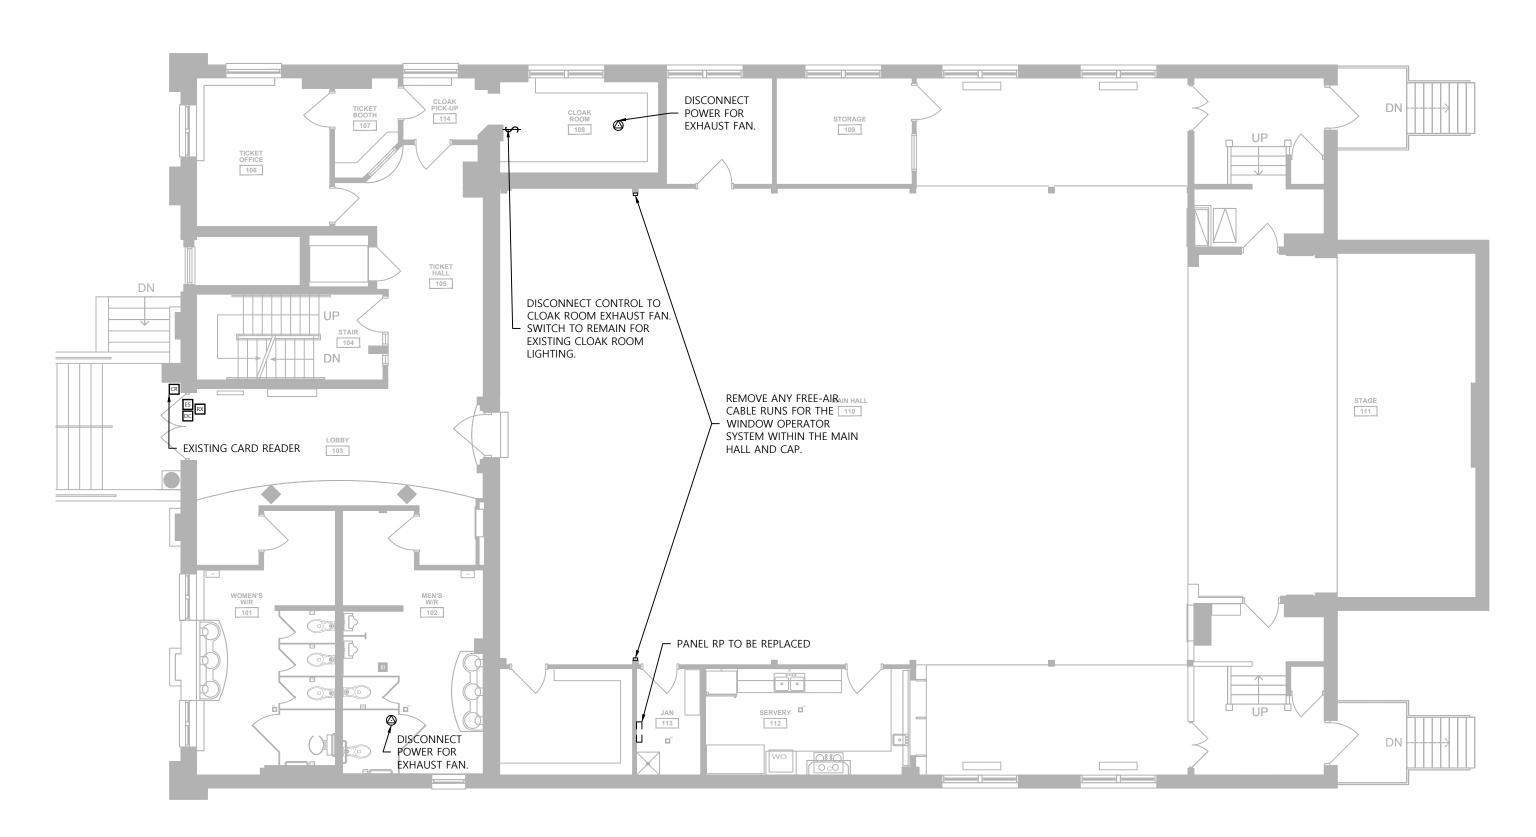
REVISION:



AS STATED

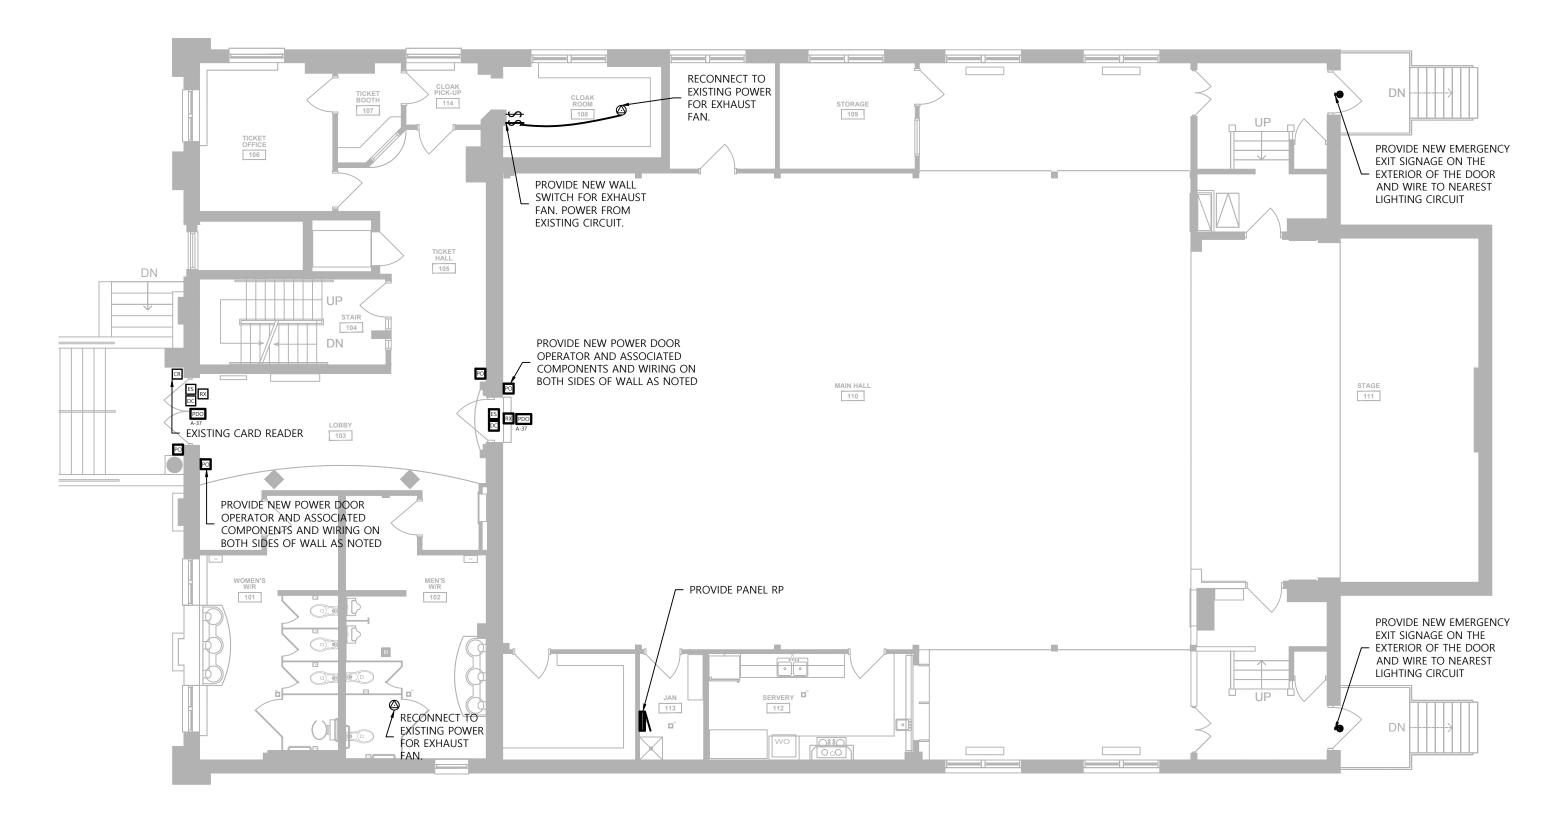
25130 E200 PROJECT NO: DRAWING NO:

SCALE AT ARCH D:



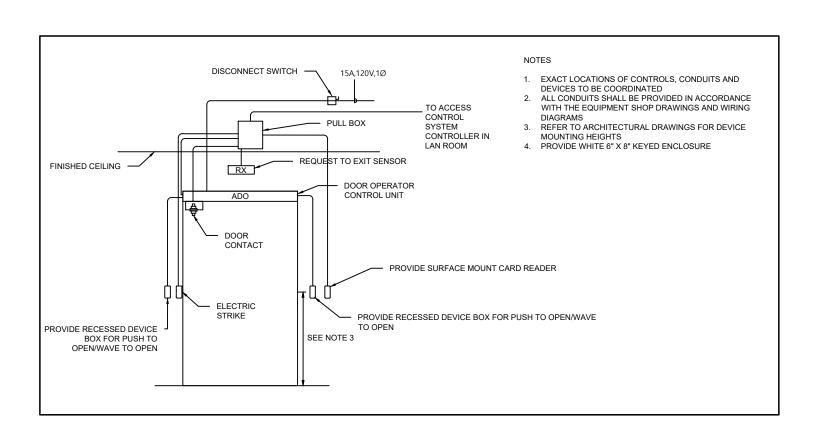
L1 POWER LAYOUT DEMO

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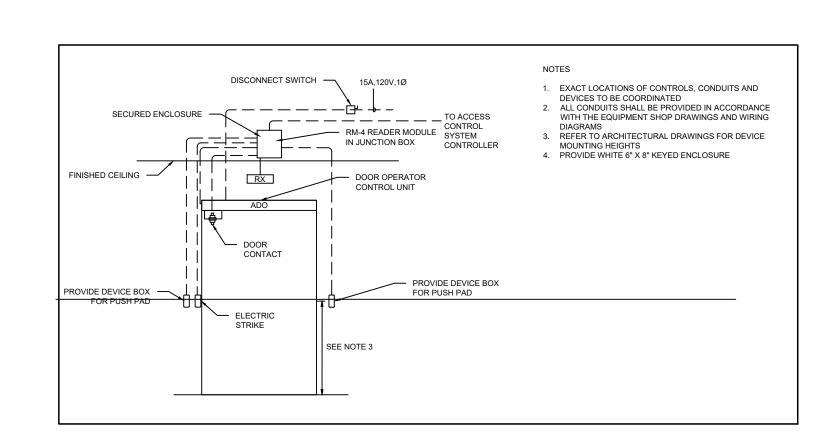


L1 POWER LAYOUT RETROFIT

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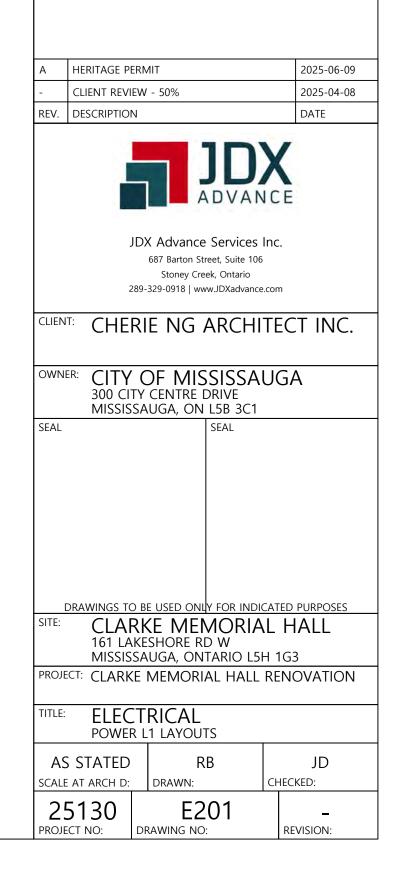



AUTOMATIC DOOR WITH PUSH PLATE AND CARD READER OPERATION SCALE: NTS





AUTOMATIC DOOR WITH PUSH PLATE OPERATION

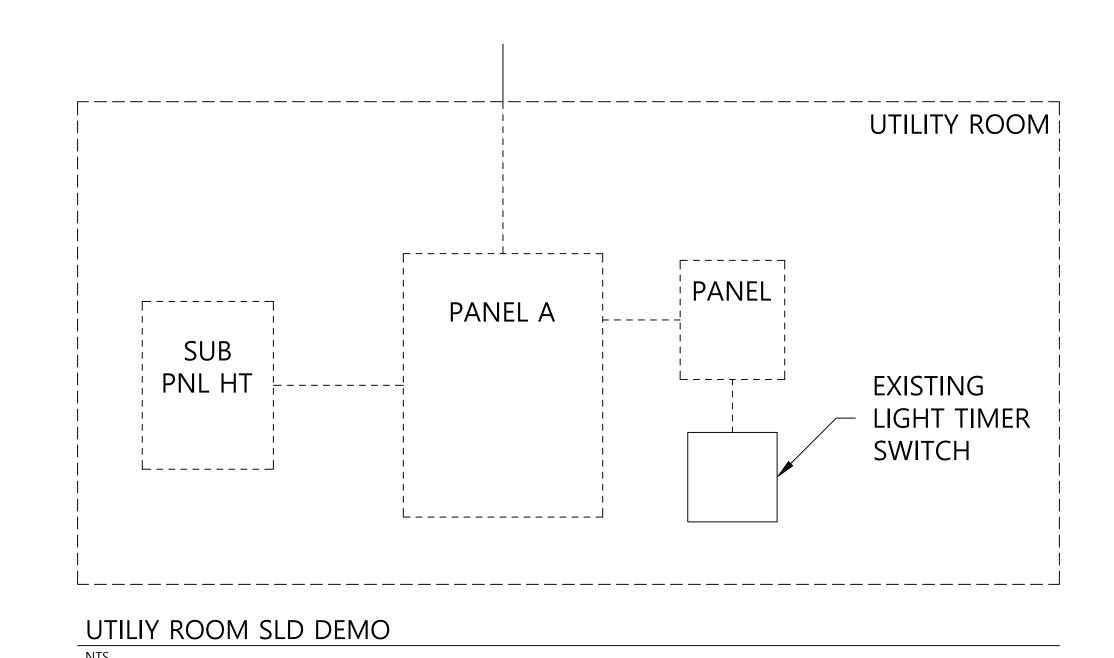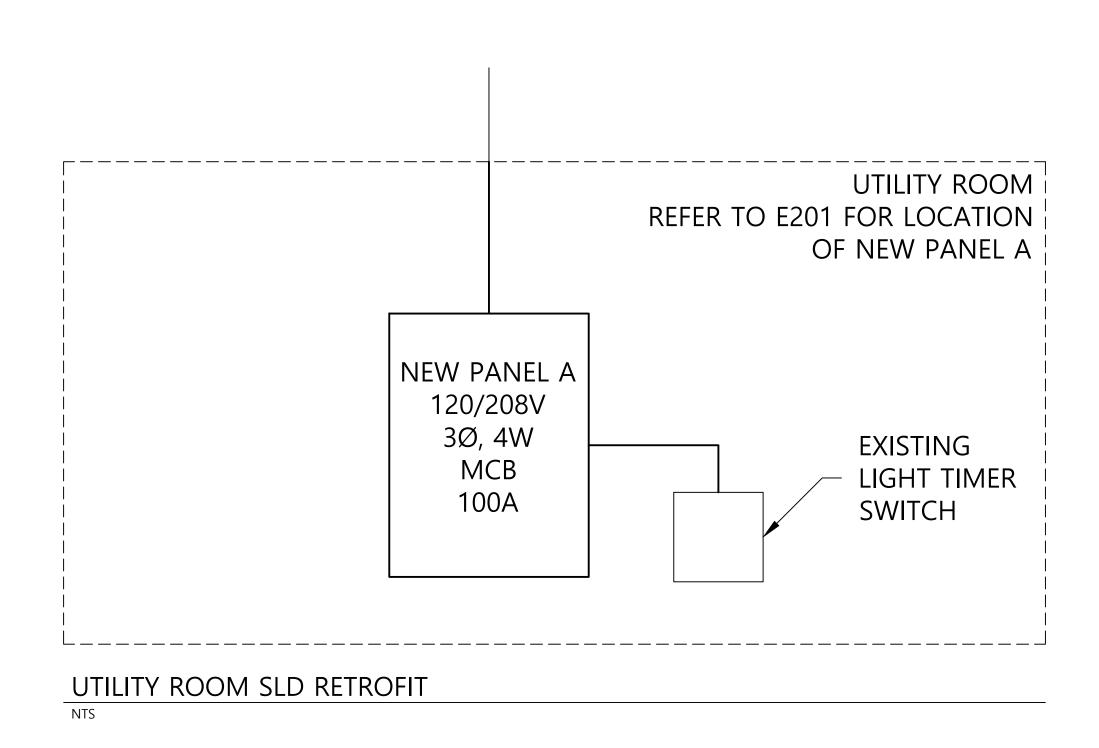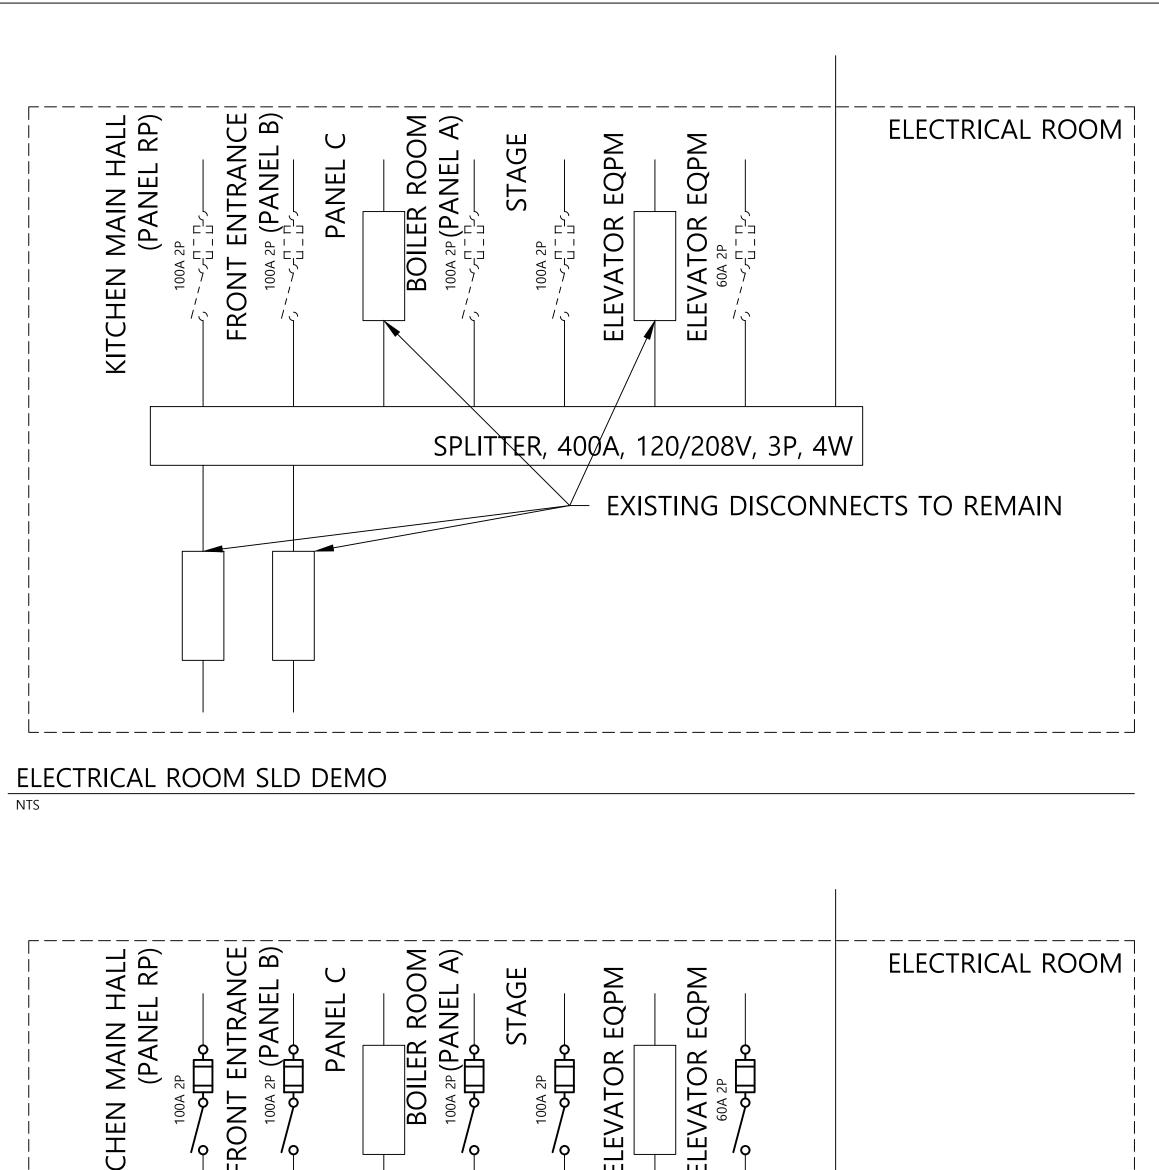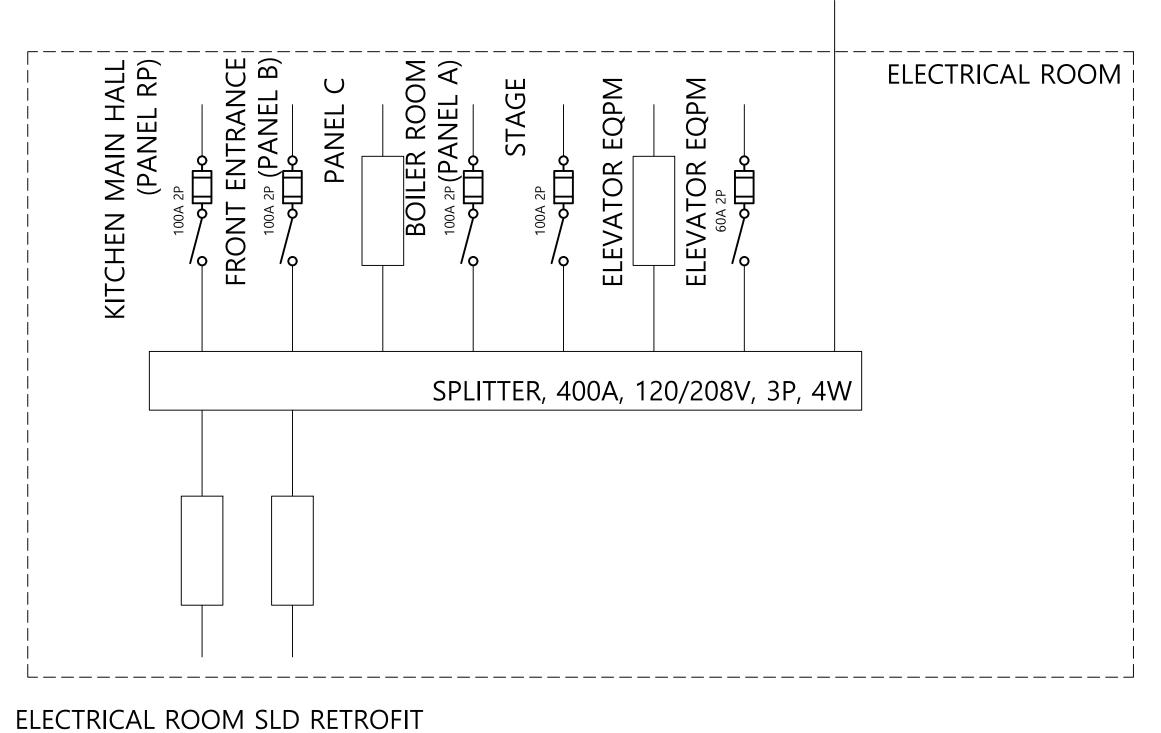
SCALE: NTS

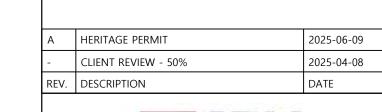








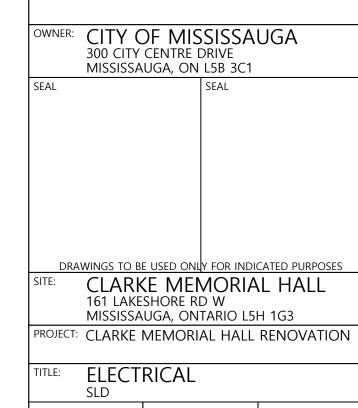






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