NAME OF PROJECT:

RENOVATION OF

ST MARY STAR OF THE SEA RECTORY

PROJECT LOCATION:

11 PETER STREET SOUTH

MISSISSAUGA, ONTARIO

L5H 2G1



Lynch + Comisso

ARCHITECTURE + LIGHT

570 Annette Street
Toronto, Ontario
M6S 2C2 Canada

416 762 2778 tel
416 762 9020 fax
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PROJECT DESCRIPTION: -												
PROJECT DESCRIPTION: -   New   S PART 11   S PART 3   S PART 5   S PART 6   S PART 7	ITEM ONTARIO BUILDING CODE					O.B.C. REFER					ENCE	
Addition		DATA	AND 9	)								
2. MAJOR OCCUPANCY(S)	1.	PROJECT DESCR	RIPTION: -			☐ New	☑ PART	11	☑ PART 3		☑ PART 9	
2. MAJOR COCUPANCY(S)   GROUP A DINSION 2 AND GROUP C RESIDENTIAL   5.1.2.1(1)   5.10.2.						☐ Addition	11.1 to	11.4	1.1.2. [A]		1.1.2. [A] & 9	9.10.1.3.
3.5 BUILDING AREA (m³)   Existing: 1150.79   New: 1.6   Total: 1867.76   1.4.1.2. [A]   1.4.1.2. [A]     4. RROSS AREA (m³)   Existing: 1120.79   New: 2.81   Total: 1117.98   1.4.1.2. [A]   1.4.1.2. [A]     5. NUMBER OF STOREYS   Above grode: 2   Below grode: 1   1.4.1.2. [A]   1.4.1.2. [A]     6. NUMBER OF STOREYS   Above grode: 2   Below grode: 1   1.4.1.2. [A]   3.2.1.1.   1.4.1.2. [A]   9.10.4     6. NUMBER OF STREETS/FIRE FIGHTER ACCESS   2   3.2.2.10. & 3.2.3.5.   9.10.20.     7. BUILDING CLASSIFICATION   GROUP A DIVISION 2 UP TP 2 STOREYS   3.2.2.208.3   9.10.20.     8. SPRINKLER SYSTEM PROPOSED   entire building   3.2.2.208.3   9.10.2.     9. STANDPIPE REQUIRED   Grove a selected floor greas   3.2.2.7.   INDEX     10. FIRE ALARM REQUIRED   Yes   Mo   3.2.4.   9.10.18.     11. WAITER SERVICE/SUPPLY IS ADEQUIATE   More yes   No   3.2.4.   9.10.18.     12. HIGH BUILDING   Yes   Mo   3.2.5.7.   N/A     13. PERMITTED CONSTRUCTION   Grombustible   Non-combustible   More combustible   More combu												
4. (BROSS AREA (m²)					ISION 2 AN	ID GROUP C R			` '			
5. NUMBER OF STOREYS			` '					<u> </u>				
6. NUMBER OF STREETS/FIRE PIGHTER ACCESS 2 7. BUILDING CLASSIFICATION — GROUP A DIVISION 2 UP TP 2 STOREYS 3.2.2.0.—8.3 9.10.2.  8. SPRINKLER SYSTEM PROPOSED — entire building		· `					Total: 111	7.98				
BUILDING CLASSIFICATION						grade: 1						9.10.4
SPRINKLER SYSTEM PROPOSED									<b>.</b>	5.		
selected compartments   3.2.1.5.   3.2.2.17.							S					
	8.	SPRINKLER SYS	TEM PROPOSED			•					9.10.8.2.	
STANDPIPE REQUIRED						•						
9. STANDPIPE REQUIRED												
9. STANDPIPE REQUIRED				_		∐ in	lieu of roof r	ating	INDEX		INDEX	
10. FIRE ALARM REQUIRED		0744100105 050			•				7.00			
11. WATER SERVICE/SUPPLY IS ADEQUATE												
12. HIGH BUILDING			<u> </u>									
13.   PERMITTED CONSTRUCTION		· · · · · · · · · · · · · · · · · · ·	/SUPPLI IS ADEQU									
ACTUAL CONSTRUCTION			ISTRUCTION - C			mhustible 🔯	Doth					
14. MEZZANINE(S) AREA (m²) N/A design of building  BASEMENT: OCCUPANCY CHURCH HALL LOAD 444 PERSONS 2ND FLOOR OCCUPANCY CHURCH NAVE LOAD 56 PERSONS 2ND FLOOR OCCUPANCY CHURCH NAVE LOAD 5 PERSONS 3RD FLOOR OCCUPAN	13.	l	<del>-</del>			_			3.2.2.2083		9.10.0.	
15. OCCUPANT LOAD BASED ON	14					indatible 🔼	Dotti		3 2 1 1 (3)–(8)		9 10 4 1	
BASEMENT: OCCUPANCY   CHURCH HALL   LOAD   444   PERSONS     1ST FLOOR   OCCUPANCY   CHURCH NAVE   LOAD   586   PERSONS     2ND FLOOR   OCCUPANCY   RECTORY   LOAD   6   PERSONS     3RD FLOOR   OCCUPANCY   RECTORY   LOAD   6   PERSONS     (Additional floor areas continued on last page)		· · · ·	<u> </u>		·	of building						
1ST FLOOR   OCCUPANCY   CHURCH NAVE   LOAD   586   PERSONS   2ND FLOOR   OCCUPANCY   CECTORY   LOAD   6   PERSONS   2ND FLOOR   OCCUPANCY   CECTORY   LOAD   CECTORY   CAdditional floor areas continued on last page)   STEP   OCCUPANCY   CECTORY   CADDITION   CONSTR. NON.   CADDITION   CADDITION   CONSTR. NON.   CADDITION   CADDITION   CONSTR. NON.   CADDITION   CADDITION   CONSTR. NON.   CADDITION   CONSTR. NON.   CADDITION   CADDITION   CONSTR. NON.   CADDITION   CADDITION   CONSTR. NON.   CADDITION   CONSTR. NON		1			-	-	PERSONS				0.011.0.	
2ND FLOOR   OCCUPANCY   RECTORY   LOAD   6   PERSONS		1ST FLOOR OCCUPANCY CHURCH NAVE LOAD 586 PERSONS										
3RD FLOOR   OCCUPANCY												
16. BARRIER-FREE DESIGN   Mo (explain)   3.8.   9.5.2.     17. HAZARDOUS SUBSTANCES   Yes   No   No (explain)   3.8.   9.5.2.     18. REQUIRED FIRE RESISTANCE RATING (FRR (HOURS)   FRR (HOURS)   No (PROPOSED FOR MEMBERS   No (PROPOSED FOR MAX. % OF OPENINGS   No (PROPOSED FOR MAX. % OF OPENINGS   No (PROPOSED FOR MAX. % OF OPENINGS   No (HOURS)   No (HOURS)   No (HOURS)     19. SPATIAL SEPARATION - CONSTRUCTION OF EBF (m²)   Mo   L/H OR H/L   No (HOURS)   NO (HOURS)   NO (HOURS)   NO (HOURS)     19. NORTH   N/A   -     NO (CHANGE   -   -   -   -   -   -   -     19. SOUTH   N/A   -     NO (CHANGE   -   -   -   -   -   -   -   -     19. SOUTH   N/A   -     NO (CHANGE   -   -   -   -   -   -   -   -   -												
9.5.2.1 (2)  17. HAZARDOUS SUBSTANCES  No  3.3.1.2. & 3.3.1.19. 9.10.1.3.(4)  18. REQUIRED FIRE RESISTANCE RATING (FRR)  No  No DESCRIPTION (SG-2)    FIRE RESISTANCE RATING (FRR)  No  No  No  No  No  No  No  No  No  N		(Additional floor	r areas continued	on last page)		-						
17.   HAZARDOUS SUBSTANCES	16.	BARRIER-FREE	(explain)			3.8.		9.5.2.				
18.   REQUIRED FIRE RESISTANCE RESISTANCE RESISTANCE RATING (FRR)   HORIZONTAL ASSEMBLIES FRR (HOURS)   OR DESCRIPTION (SG-2)   3.2.2.2.083 & 3.2.1.4.		9.5.2.1 (2)										
FIRE   RESISTANCE   RATING (FRR)   FRR (HOURS)   OR DESCRIPTION (SG-2)   3.2.1.4.	17.	HAZARDOUS SU	BSTANCES	□ Ye	es 🛭 No				3.3.1.2. & 3.3.1	.19.	9.10.1.3.(4)	
RESISTANCE RATING (FRR)	18.								3.2.2.2083 &		9.10.8.	
RATING (FRR)			FRR (	(HOURS)		OR DESCR	RIPTION (SG-2	2)	3.2.1.4.		9.10.9.	
Mezzanine: N/A Hours   LISTED DESIGN NO. OR DESCRIPTION (SG-2)		RATING (FRR)										
FRR OF   SUPPORTING MEMBERS   SUPPORTING MEMBERS   OR DESCRIPTION (SG-2)												
SUPPORTING MEMBERS   OR DESCRIPTION (SG-2)									-			
Roof:   0   Hours								2)				
Mezzanine: N/A Hours		Floors: N/A Hours						]				
19.   SPATIAL SEPARATION - CONSTRUCTION OF EXTERIOR WALLS   3.2.3.   9.10.14.		Roof: 0 Hours							]			
WALL BEF (m²)         L.D. (m)         L/H OR H/L         PERMITTED MAX. % OF OPENINGS         PROPOSED % OF OPENINGS         FRR (HOURS)         LISTED DESIGN OR DESCRIPTION         COMB. CONST. NONC. CLADDING         NON-CONSTR. NONC. CLADDING           NORTH         N/A         -         -         NO CHANGE         -<		Mezzanine: N/A Hours										
EBF (m²)	19.	SPATIAL SEPARA	ATION - CONSTRUC	CTION OF EXTER	RIOR WALLS				3.2.3.		9.10.14.	
SOUTH         N/A         -         -         NO CHANGE         -         -         -         -         -         -           EAST         N/A         -         -         NO CHANGE         -					MAX. % OF	% OF			ESIGN OR		CONSTR. NONC.	NON-COM CONSTR.
EAST         N/A         -         -         NO CHANGE         -         -         -         -         -         -		NORTH N/A	_	-	NO CHANGE	-	-		_	-	-	-
		SOUTH N/A	_	- 1	NO CHANGE	-	-		_	_	-	_
WEST N/A NO CHANGE		EAST N/A	-	-	NO CHANGE	-	-		_	-	-	-
		WEST N/A	_	_	NO CHANGE	_	-			_	_	_

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SITE ANALYSIS								
Municipal Address:	II Peter Str	eet <b>S</b> outh						
Zoning Classification:	CR 4							
Site Stats	s.f.	m <sup>2</sup>						
Lot Area	16376.78	1521.45						
	ft	m						
Lot Frontage	66.00	20.12						
Lot Depth	228.19	69.55						
Gross Floor Area	Allo	wed		Existing			Proposed	
	s.f.	m <sup>2</sup>	s.f.	m²	%	s.f.	m <sup>2</sup>	%
T [Total]			12064.08	1120.79	73.67	12033.79	1117.98	73.48
				Prop	osed Increase	-2.81	m²	
				<u> </u>				
Building Area	Exis	ting	Proposed					
	s.f.	m²	s.f.	m²				
Church Basement*	7021.09	652.28	no ch	ange				
Rectory Basement*	620.7	57.66	no ch	ange				
Church Ground Floor	6765.55	628.54	no ch	ange				
Rectory Ground Floor	2546.96	236.62	2564.23	238.22				
Church Choir Loft	578.76	53.77	no change					
Rectory 2nd Floor	2172.81	201.86	2125.25	197.44				
* basement not included in total								
Total	12064.08	1120.79	12033.79	1117.98				
Setbacks	Regu	uired	Required		Proposed			
	ft	m	ft	m	ft	m		
Front Yard (Max)	9.84	3.00	34.56	10.53	no change			
Side Yard (East)	0.00	0.00	3.75	1.14	no change			
Side Yard (West)	0.00	0.00	0.29	0.09	no change			
Rear Yard	14.76	4.50	1.65	0.50	no change			
Building Height	Requ	Required		Required		<b>P</b> roposed		
	ft	m	ft	m	ft	m		
Rectory	52. <del>4</del> 9	16.00	22.8	6.95	no cha	ange		
Church	52.49	16.00	47.45	14.46	no cha	ngo		

no change BACKYARD AND PARKING LOT TO EAST IS NOT PART OF CHURCH PROPERTY. DISPOSAL BINS TO BE LOCATED ON DRIVEWAY. CONTRACTOR TO REVIEW STAGING AND DISPOSAL PLAN WITH CONSULTANT PRIOR TO COMMENCING WORK. ADJACENT SCHOO! **SCHOOL** PARKING LOT 49'-11 7/8" <sup>[15235]</sup> [15.24M) N52\*16'48"W 60.01'(18.29M) (23.77M) SOFT SOFT STANDSCAPE 114'-11 7/8" EXIST. FLAT [35050] N52'16'50"W 114.99' (35.05M) EAST 70.98 ENTRY • EXIST. ASPHALT WALKWAY 34'-6 3/4" ST. MARY [10535] 🞵 RECTORY EXIST. BLOCK STAR OF THE SEA PAVERS & / BUILDING CHURCH STONE PATIO EXISTING ROOF TO REMAIN 걸ㅣ SLOPE SLOPE -SLOPE SLOPE ∏ NORTH SKYLIGHT ENTRY SKYLIGHT OFFICE ENTRY SLOPE EXISTING ROOF TO REMAIN UP UP UP 10P 15"+9 3/8" UP BSMNT. ENTRY 31'-2 1/8" EXIST. SOFT ENTRY [9505] EXISTING FLAT ROOF TO REMAIN— EXIST. BLOCK

PAVERS &

STONE PATIO EX/ST. SHED SOFT SOFT SOFT EXIST.

DRIVEWAY 7 \*\*\* N52'16'48"W 60.01'(/8.29M) N52°16'50"W 164.99'(50.29M) 163'-5 1/8" [49810] CONC. SIDEWALK  $\frac{1}{(A701)}$ NEW ENTRANCE TO RESIDENCE. MODIFY FENCE 164'-11 7/8" [50290]

PETER STREET

1 SITE PLAN
SCALE: 1/16"=1'-0"

Appendix 3


Lynch + Comisso

ARCHITECTURE + LIGHT

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AUTHORIZATION OF
LYNCH + COMISSO INC.

DO NOT SCALE DRAWINGS.

	ISSUANCES:		
~ -	HERITAGE		6 APR 2021
	PERMIT		16 MAR 2021
02	CLIENT REVIEW		2 DEC 2020
01	COORDINATION		17 SEPT 2020
		,	

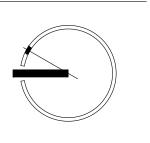CLIENT:

ST MARY STAR OF THE SEA PARISH

PROJECT NAME:

RECTORY RENOVATION

I I PETER STREET SOUTH MISSISSAUGA, ON, L5H 2G I DATE:

SEPTEMBER 2020

DRAWN BY: CHECKED BY:

JA MEL

DRAWING NAME:


OBC MAXTRIX SITE PLAN


SCALE:


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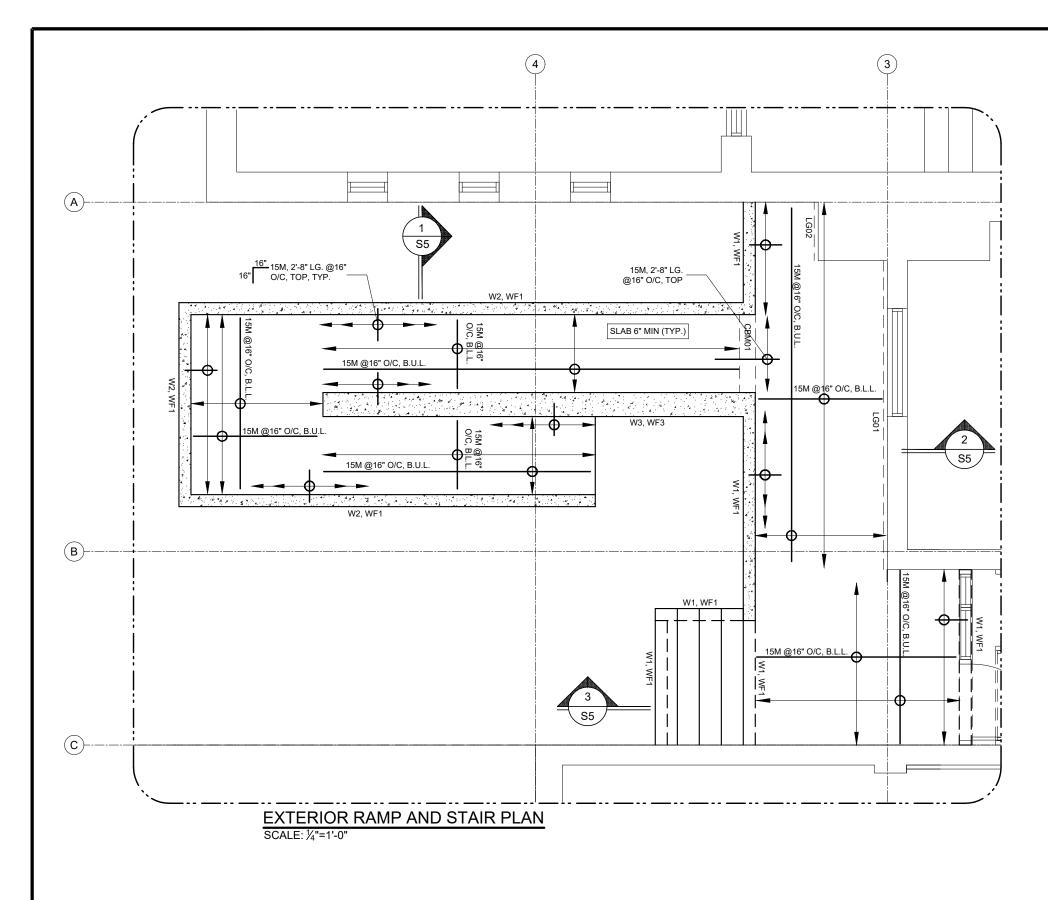
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## FOUNDATION NOTES

- ALL NEW FOOTINGS SHALL BE TAKEN DOWN TO
   UNDISTURBED SOIL CAPABLE OF SUSTAINING 2500
   PSF (120 KPA), SERVICE
- 2. ALL EXTERIOR FOOTINGS SHALL BE CARRIED DOWN TO A MINIMUM OF 1200 BELOW FINISHED GRADE.
- 3. UNDER THE FOUNDATION, PROVIDE A MINIMUM OF 127
  DEEP GRANULAR SUB-GRADE MATERIAL COMPACTED
  TO 95% MODIFIED PROCTOR DENSITY.
- 4. THE MAXIMUM SLOPE BETWEEN ADJACENT EXCAVATIONS FOR FOOTINGS OR ALONG STEPPED FOOTINGS SHALL NOT EXCEED A RISE OF 7 IN A RUN OF 10, AND MAXIMUM STEP OF APPROXIMATELY 600. REFER TO ARCHITECTURAL DRAWING FOR STEPPED FOOTING LOCATIONS.
- 5. FOOTING AND FOUNDATION WALL CONCRETE, AND ALL CONCRETE EXPOSED TO WEATHER, SHALL HAVE 7% AIR ENTRAINMENT.
- 6. THE SOIL CONSULTANT'S APPROVAL MUST BE OBTAINED BEFORE PLACING OF CONCRETE FOR THE FOOTINGS.
- 7. REFER TO THE ARCHITECTURAL DRAWINGS FOR ADDITIONAL REQUIREMENTS OF THE CONCRETE RAMP. STAIR AND PLATFORM.

# **CONCRETE RAMP & STAIR LEGEND**

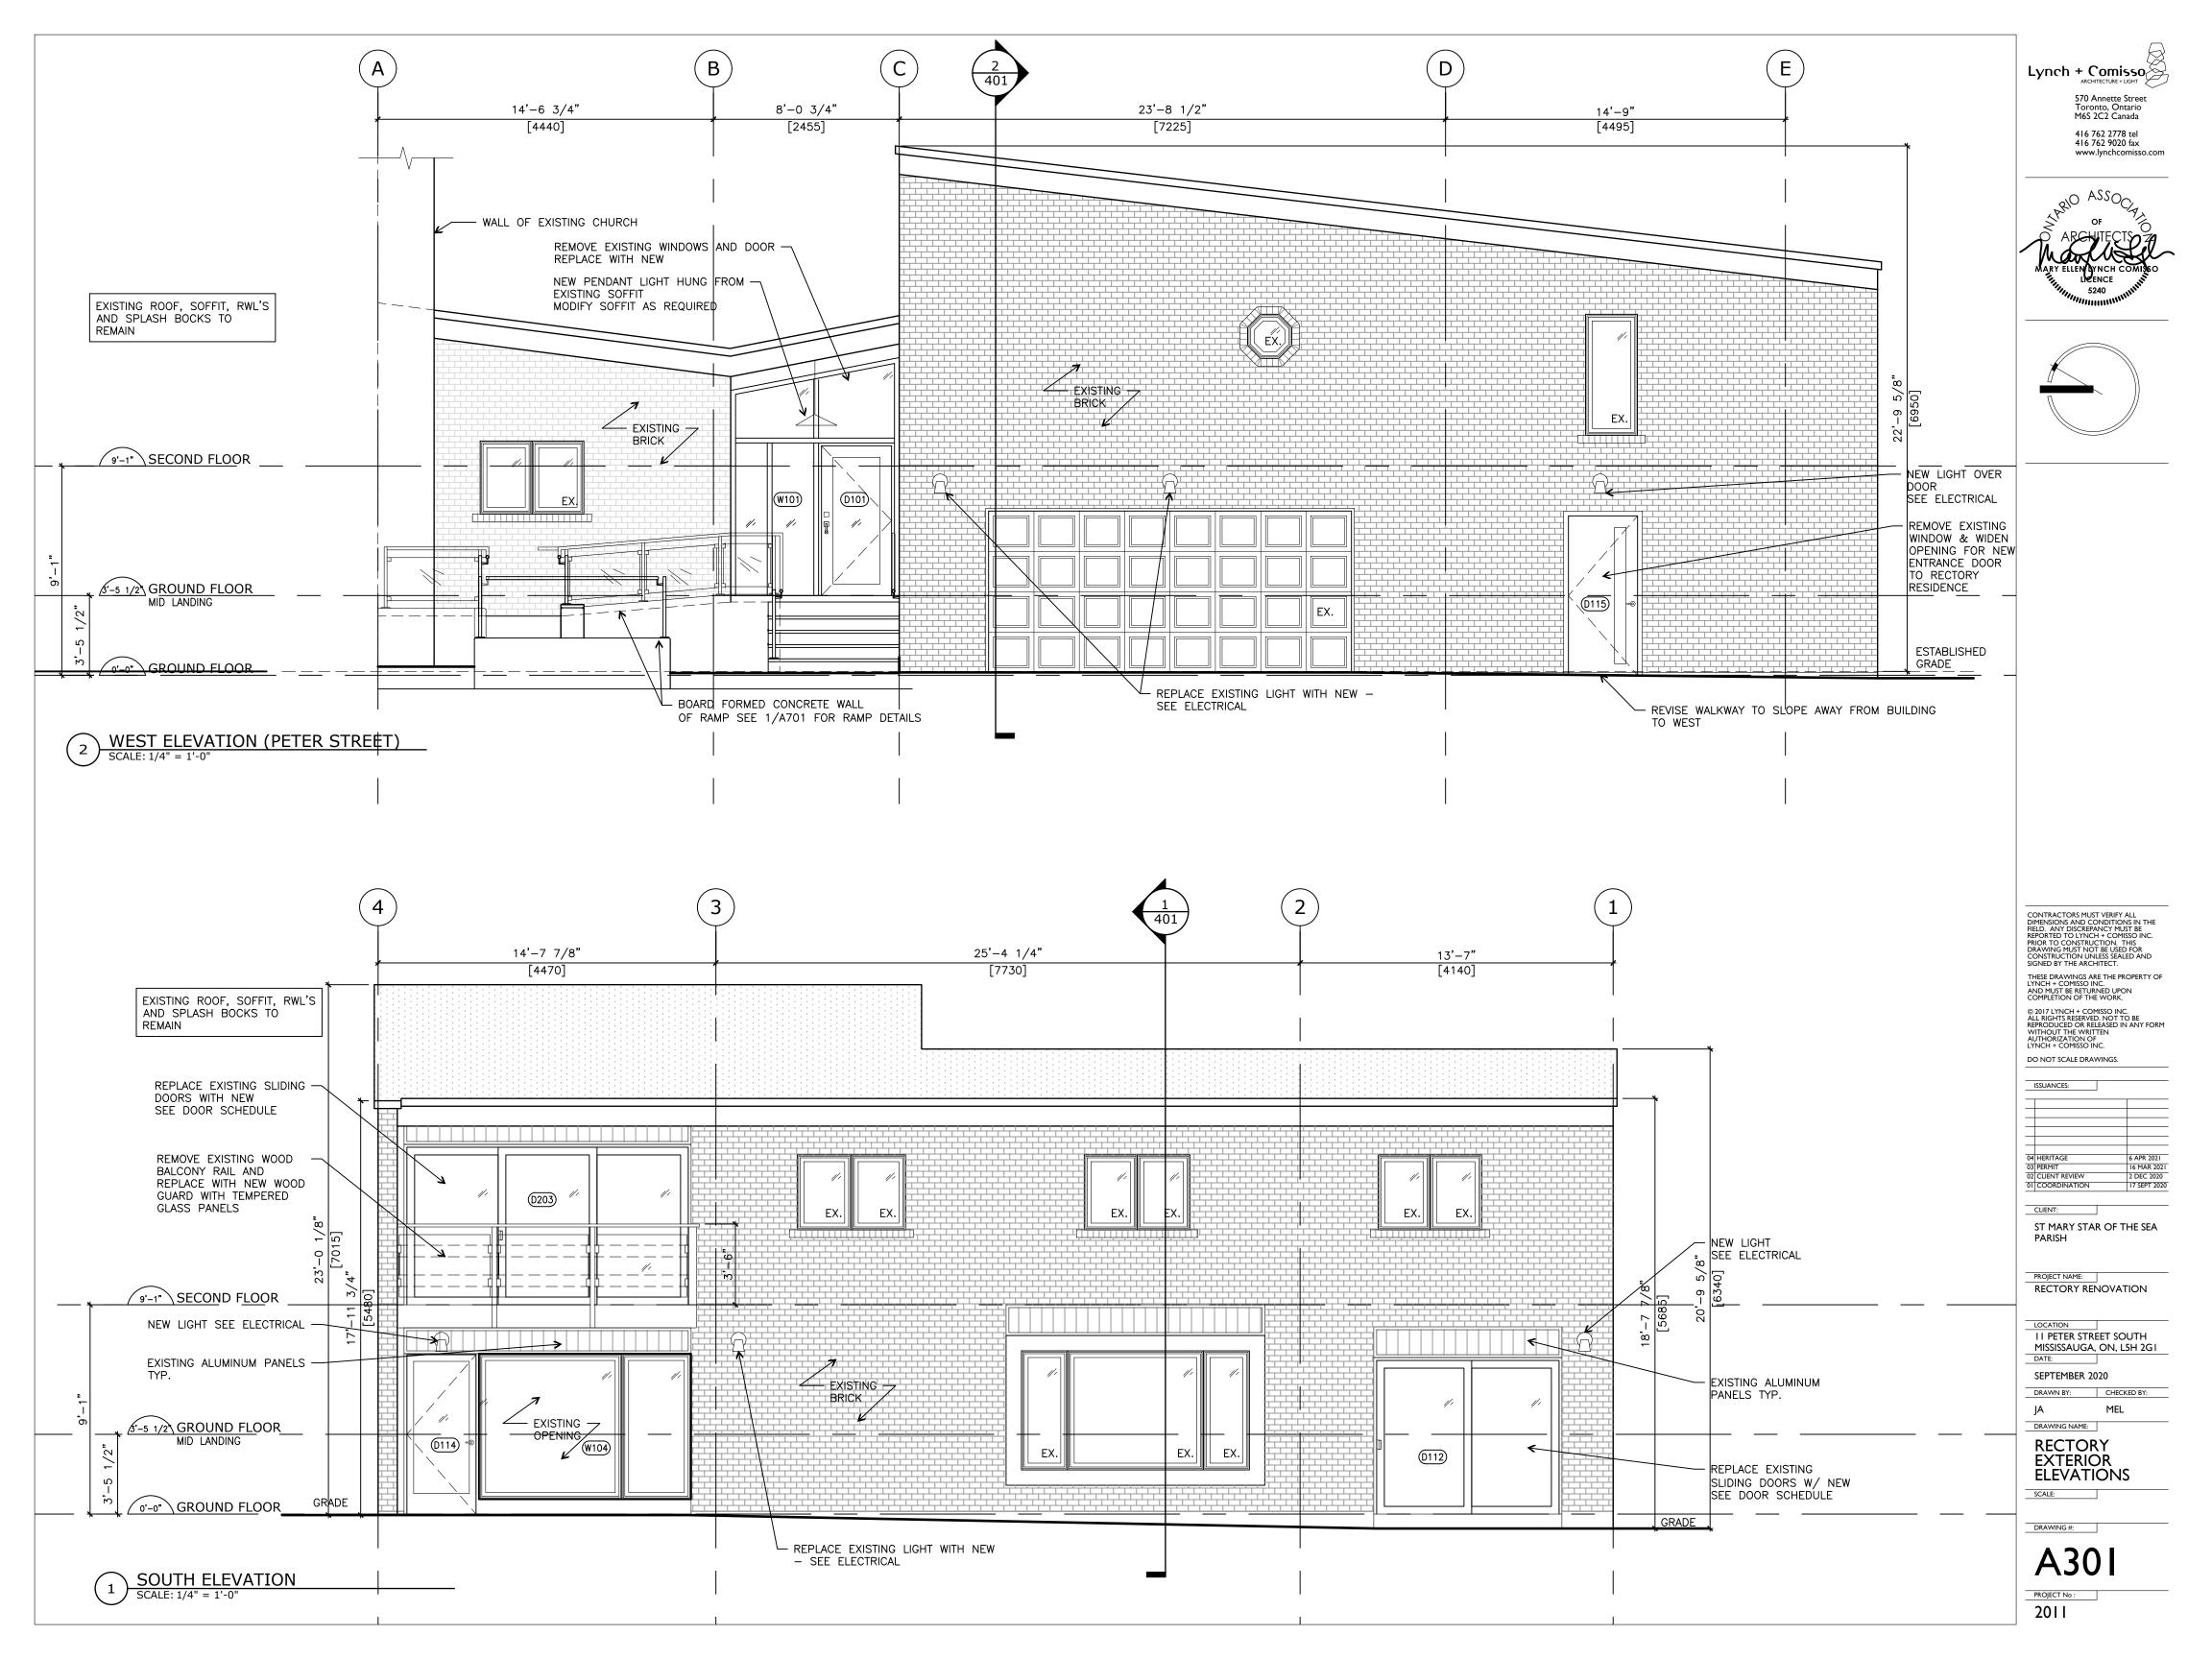- W1 DENOTES NEW 8" CONC. WALL, REINF. W/ 15M V&H @16" O/C. SEE SECTION FOR REBAR LOCATIONS.
- LUCATIONS.

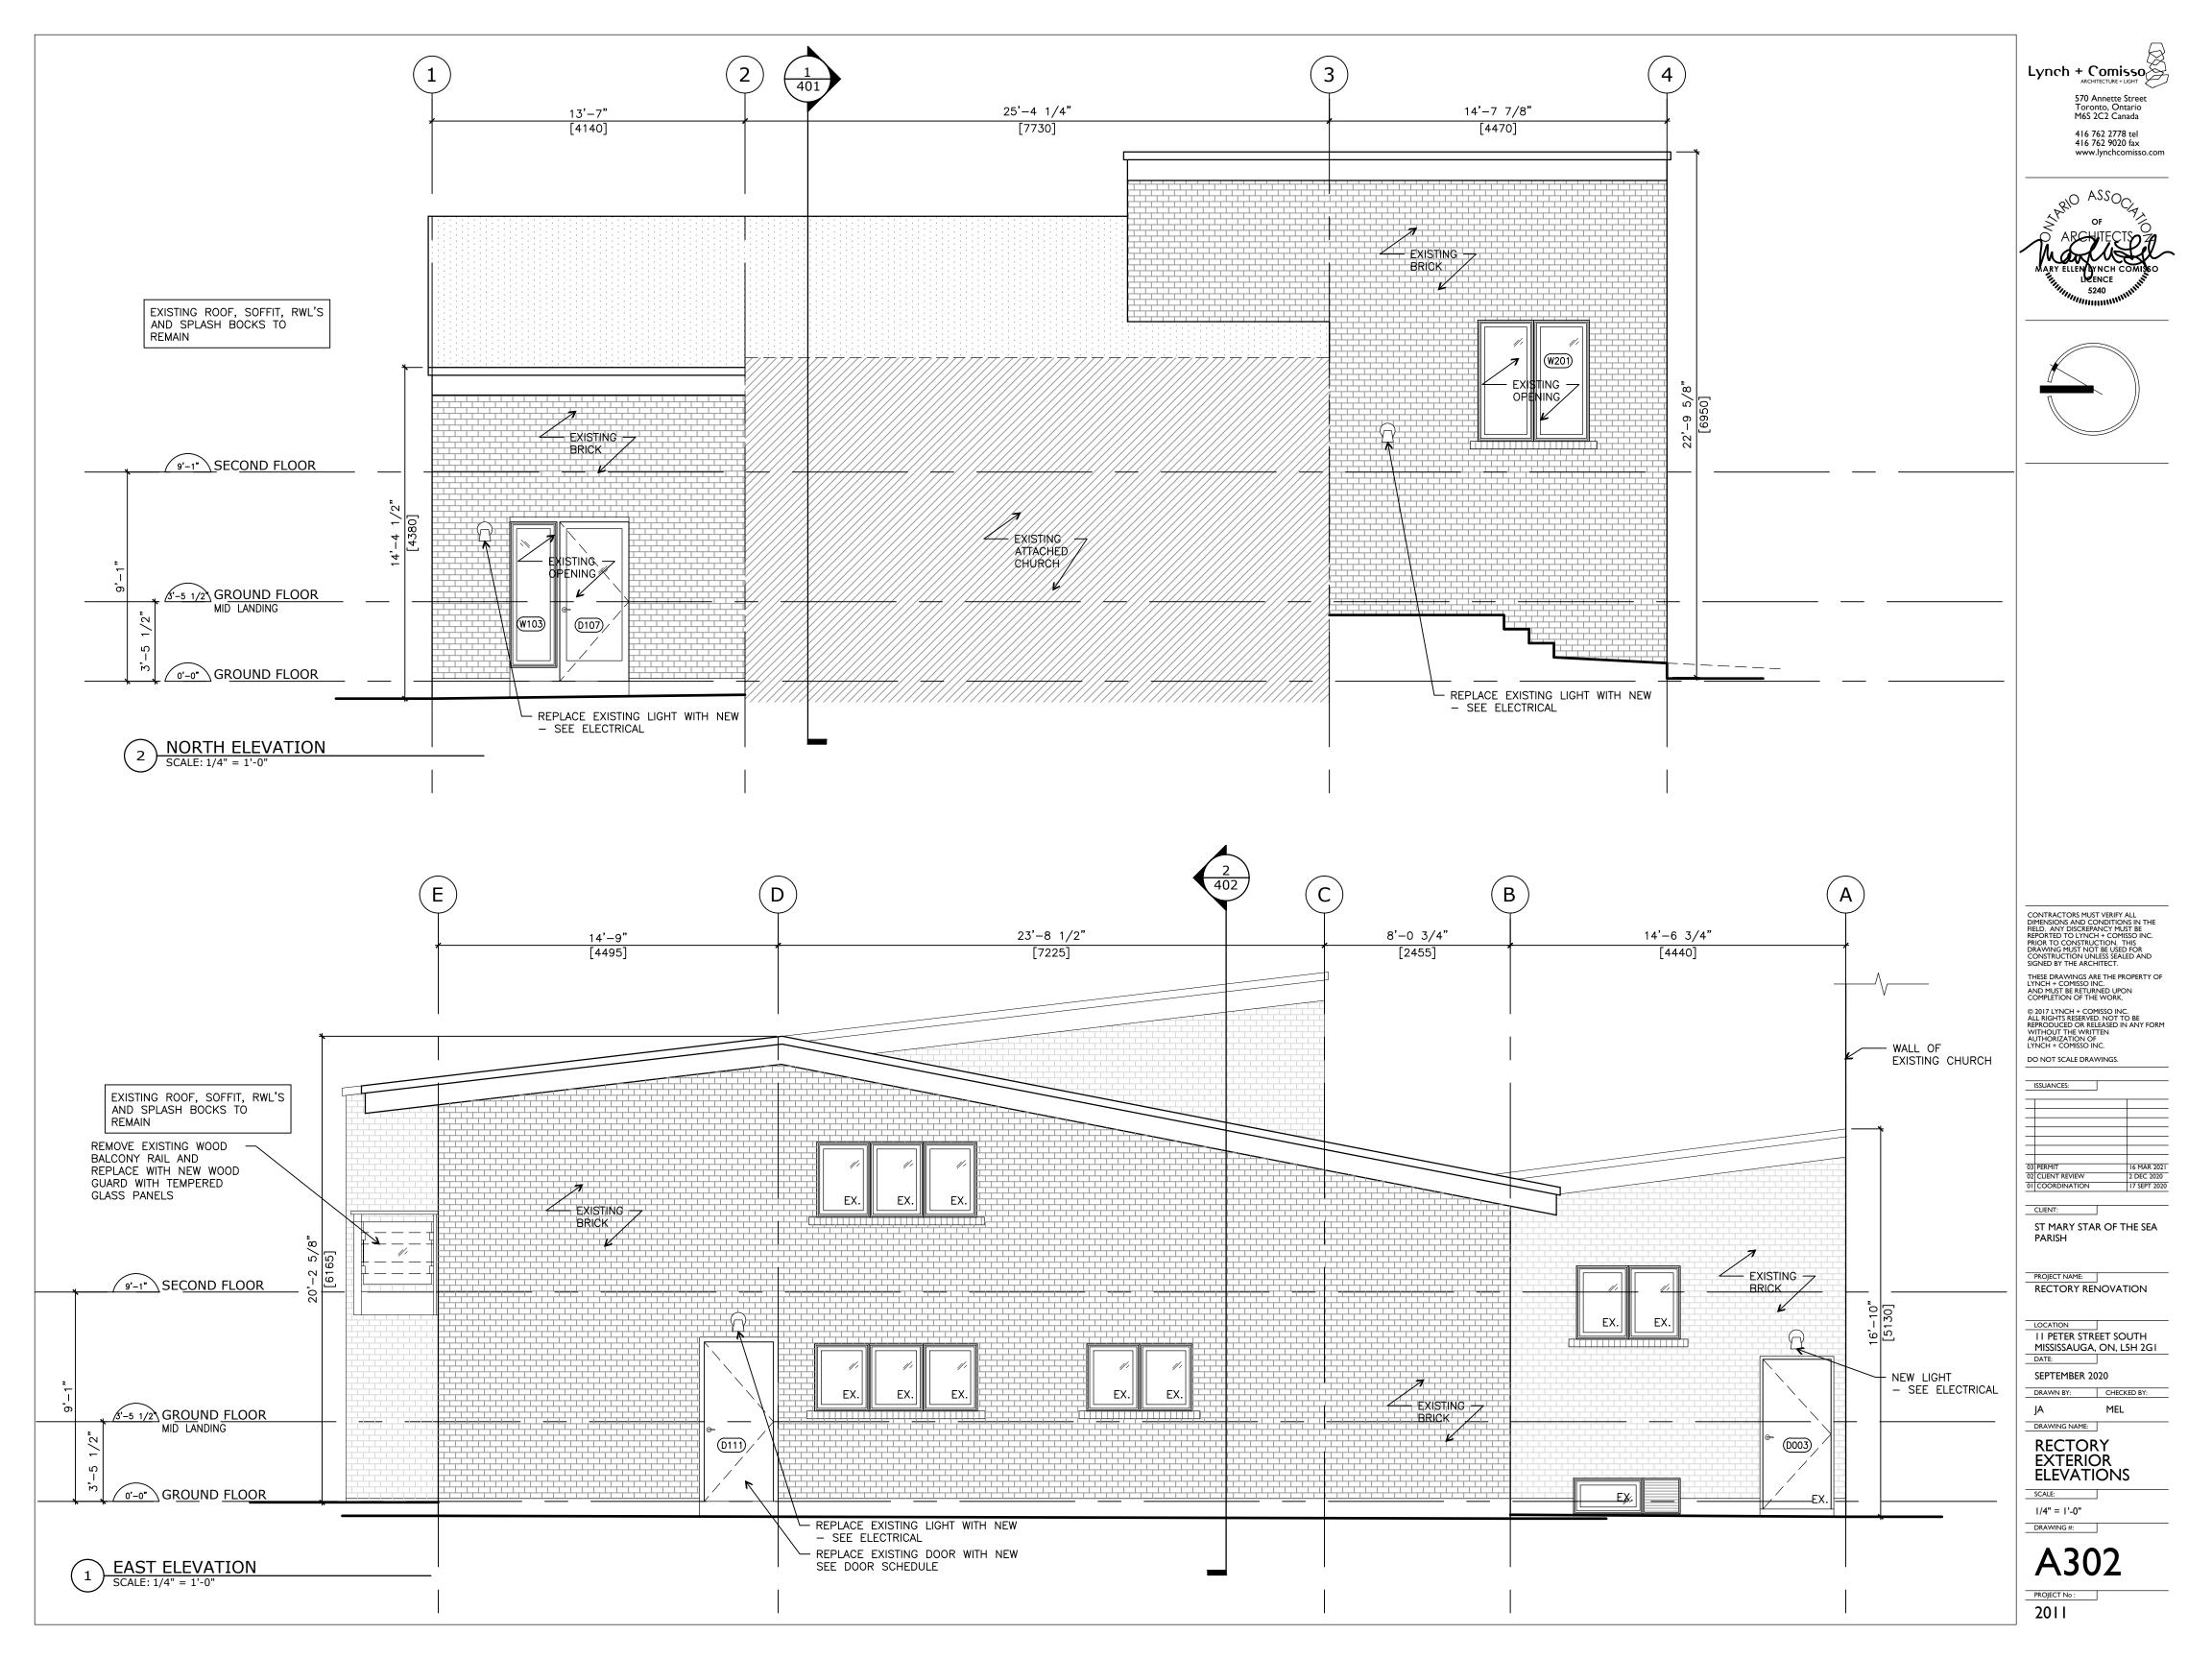   W2 DENOTES NEW 8" CONC. WALL W/ 6" CURB ABOVE RAMP, REINF. W/ 15M V&H @16" O/C. SEE SECTION FOR REBAR LOCATIONS.
- W3 DENOTES NEW 12" CONC. WALL, REINF. W/ 15M V&H @16" O/C, E.F. SEE SECTION FOR REBAR LOCATIONS.
- WF1 DENOTES NEW 1'-6"X8" DP. WALL FTG., REINF. W/2-15M LONG DIRECTION - WF3 - DENOTES NEW 1'-10"X8" DP. WALL FTG.,
- WF3 DENOTES NEW 1'-10"X8" DP. WALL FTG., REINF. W/3-15M LONG DIRECTION
- CBM01 DENOTES CONC. BEAM 8"W X 6" D, REINF. W/ 3-15M BOT. BEAM FLUSH WITH SLAB.
- LG01 DENOTES L4"X4"X½" ATTACHED TO EXIST.
  MASON. WALL W/5%" DIA. A325M THRU BOLTS @
  16" O/C, MAX., C/W BACK PL. 4"X4"X½"."
- LG02 DENOTES L4"X4"X/4" ATTACHED TO EXIST. MASON. WALL W/ %" DIA.X5" EMBED. HILTI HY-270 ANCHORS @12" O/C, MAX.
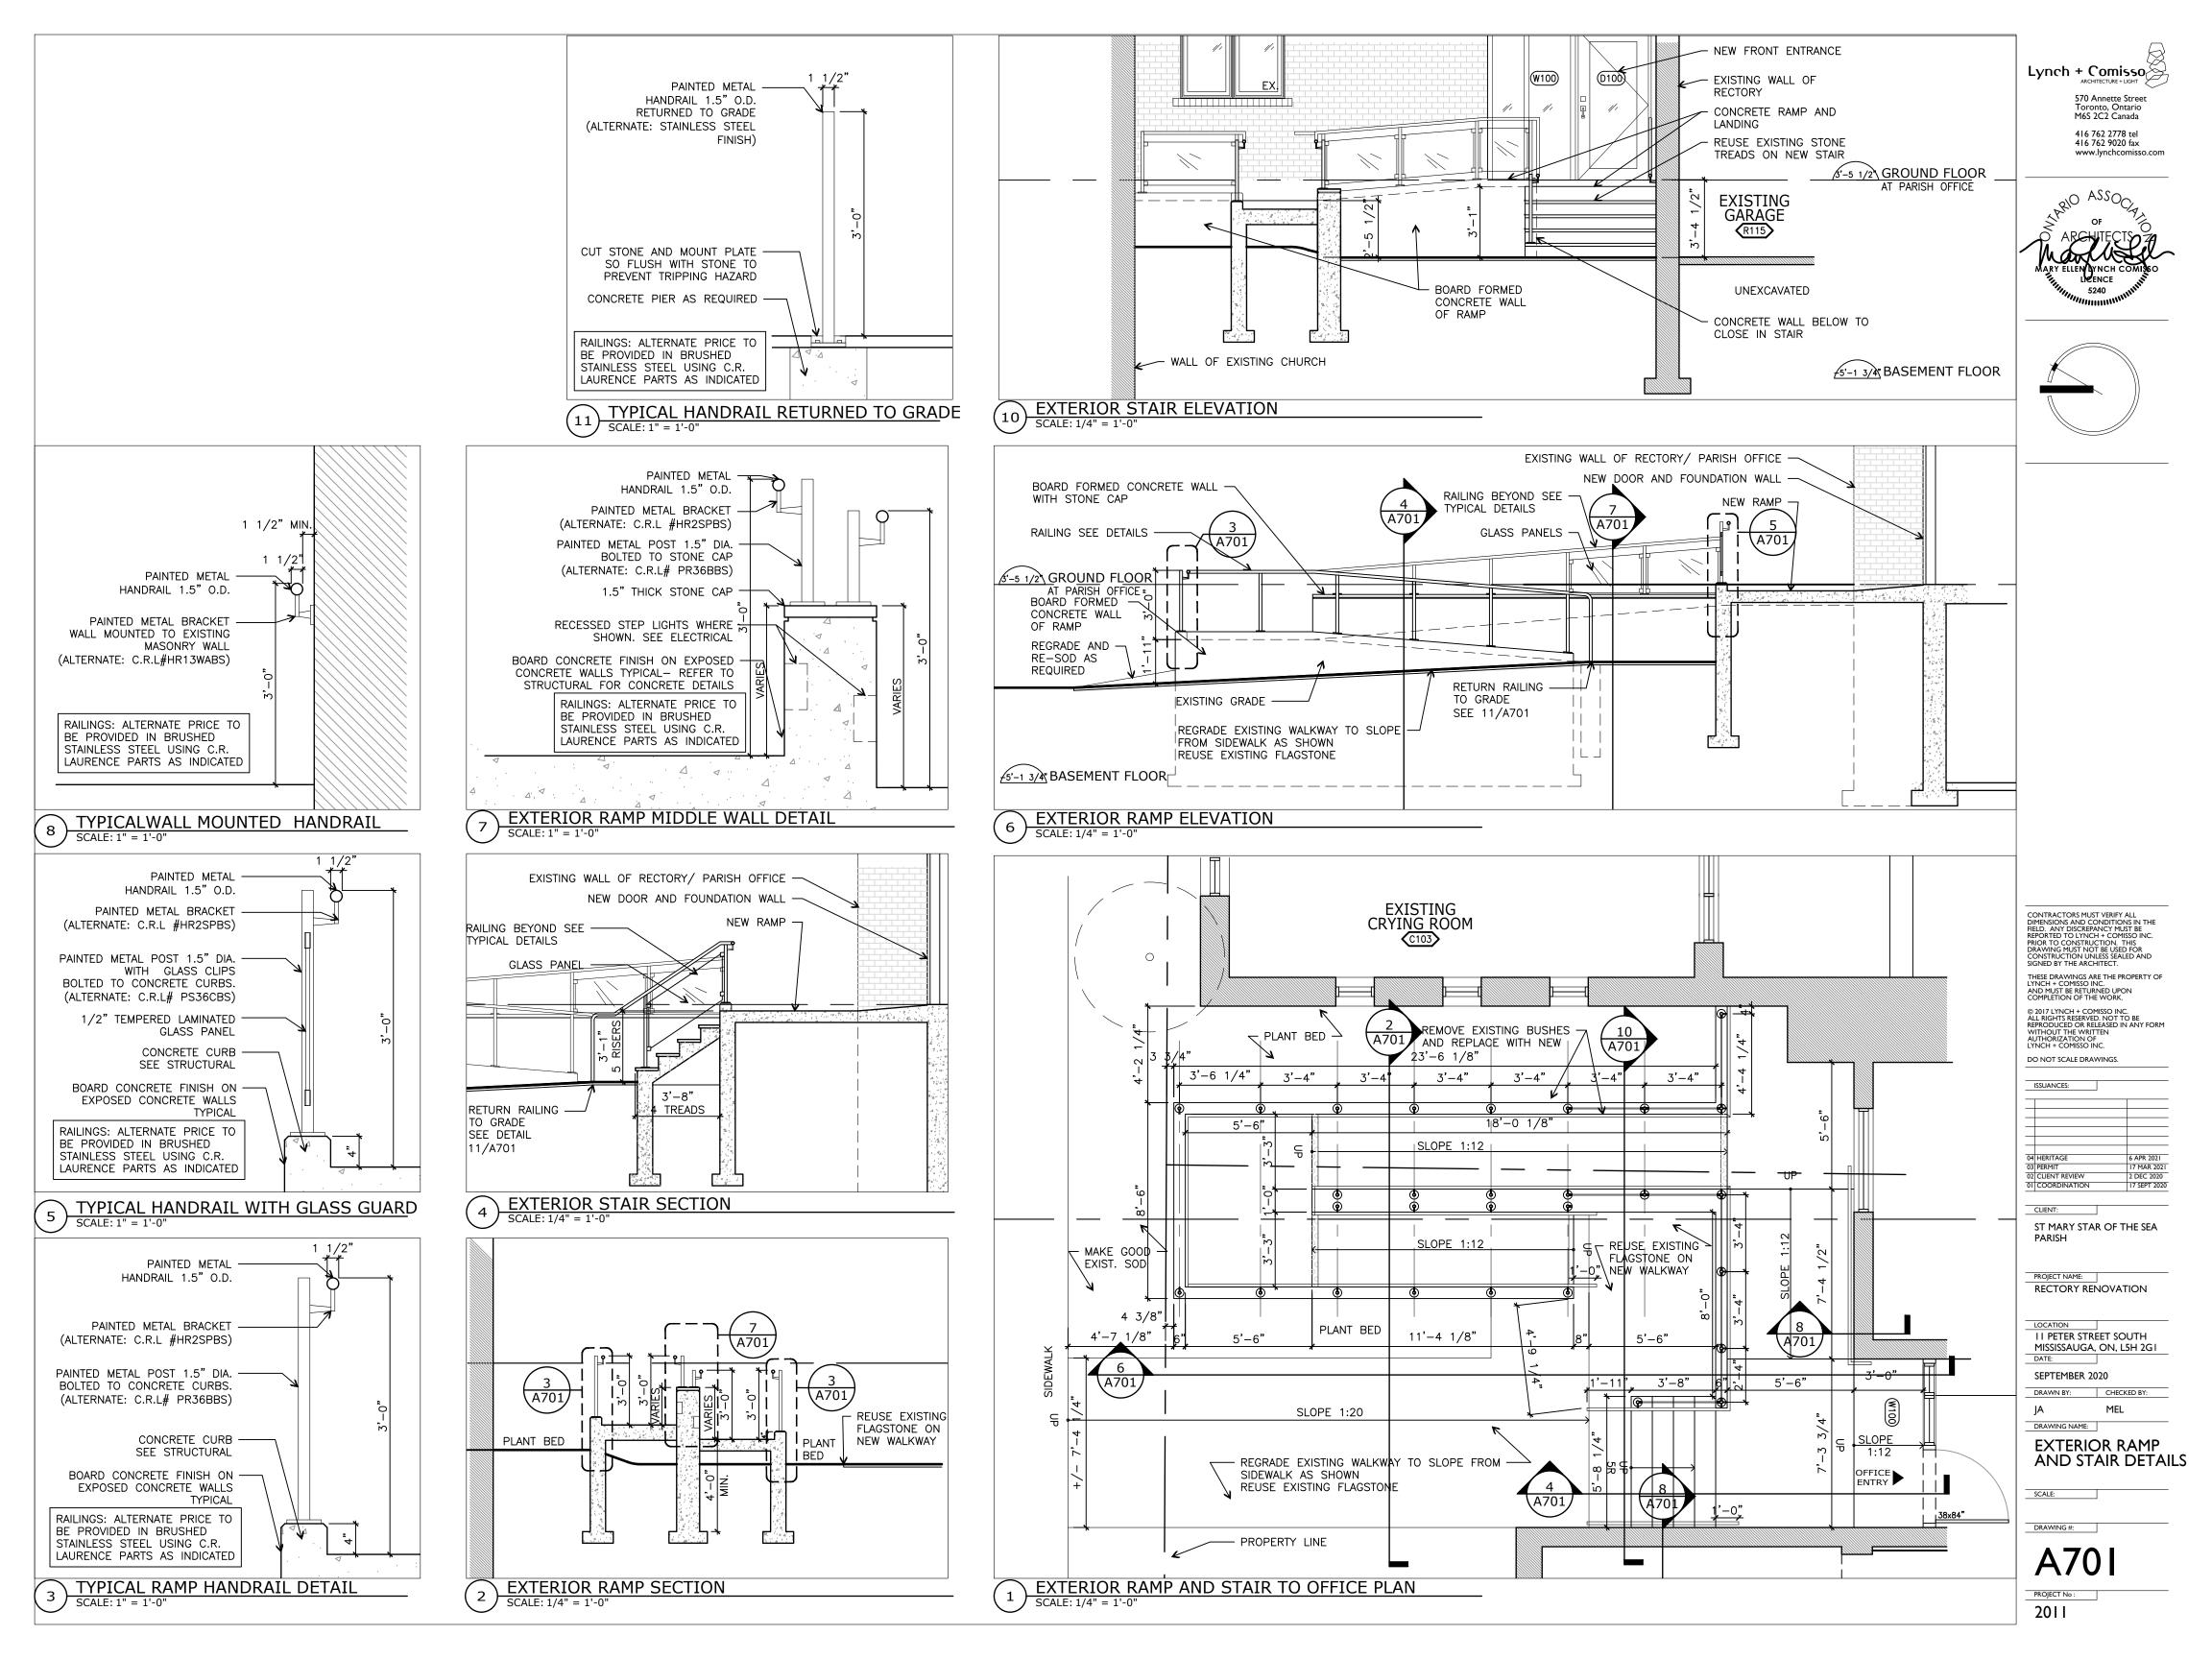
#### LEGEND

- B.U.L. DENOTES BOTTOM UPPER LAYER
- B.L.L DENOTES BOTTOM LOWER LAYER
- V & H DENOTES VERTICAL & HORIZONTAL
- E.F. DENOTES EACH FACE
- I.F. DENOTES INSIDE FACE
- E.W. DENOTES EACH WAY
   LLV DENOTES LONG LEG VERTICAL
- ADDITIONAL NOTES


SEE SHEETS S1 & S2



#### NOTE:

THE STRUCTURAL DRAWINGS ARE TO BE READ IN CONJUNCTION WITH THE ARCHITECTURAL DRAWINGS AND ANY INCONSISTENCIES TO BE REPORTED TO THE ARCHITECT BEFORE PROCEEDING WITH WORK.

ALL PRINTS OF THE STRUCTURAL DRAWINGS ARE THE PROPERTY OF NORTHERN ENGINEERING DESIGN & FORENSICS AND ARE NOT TO BE COPIED OR REPRODUCED IN ANY FORM WITHOUT THE WRITTEN PERMISSION OF NORTHERN ENGINEERING DESIGN & FORENSICS. ALL PRINTS MUST BE RETURNED UPON REQUEST TO NORTHERN ENGINEERING DESIGN & FORENSICS

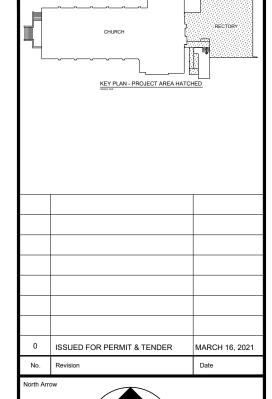

Project Title

ST. MARY STAR OF THE SEA PARISH RECTORY RENOVATION

11 PETER ST. S., MISSISSAUGA, ON L5H 2G1

Drawing T

EXTERIOR RAMP AND STAIR PLAN

NORTHERN ENGINEERING DESIGN & FORENSICS

1129-20 Carlton St. Toronto
ON M5B 2H

TELEPHONE: (416)792-6613

DESIGNED: N.M. JOB NO: 010-FE-20

PAGE: DATE: OCT. 27, 2020

SCALE: AS NOTED

WINDOW SCHEDULE									
WINDOW# LOCATION			CAT.	mat.	ROUGH OPENING SIZE			TYPE NOTES	
	Rm#	Room Name			Width	Height	Sill Ht.		
W101	R101	EX.PARISH OFFICE LOBBY	NE/CG	WD	VARIES	VARIES*	6"	A NEW WINDOW SCREEN W/ DOOR AND TRANSOME WINDOW ABOVE IN EXISTING OPENING	
W102	R102	EX. PARISH OFFICE 1	NE/F	VYL	45 1/4"	36 1/2"	43 1/2"	B NEW FIXED WINDOW IN EXISTING OPENING- SEE ALTERNATE PRICE 1	
W103	R107	EX. PARISH OFFICE LOUNGE	NE	WD	18 1/2"	72"	8"	C NEW DOOR W/ SIDE LIGHT IN EXISTING OPENING	
W104	R114	EXISTING LIVING ROOM	NE	WD	100 1/4"	74"	8"	D NEW WINDOW W/ DOOR AND NEW POST IN EXISTING OPENING	
W201	R205	EXISTING BEDROOM 1	NE/C	VYL	58"	63"	16"	F NEW CASEMENT WINDOW IN EXISTING OPENING	

\*WINDOW HEIGHT SLOPES SEE WINDOW TYPE DETAILS

## WINDOW LEGEND:

AP= ALTERNATE PRICE

N= NEW WINDOW IN NEW OPENING

NE= NEW WINDOW IN EXISTING OPENING

E = EXISTING STAINED GLASS TO BE RESTORED

C= CASEMENT

F= FIXED FILM= CUSTOM PATTERN ON FILM APPLIED TO NEW WINDOWS


TG= TEMPERED GLASS


# **GENERAL NOTES:**

- 1 VERIFY DIMENSIONS OF EXISTING WINDOWS ON SITE. VERIFY WALL AND MOUNTING CONDITIONS.
- 2 REPORT ANY DAMAGE TO WALLS TO CONSULTANT PRIOR TO ORDERING NEW WINDOWS.
- 3 SUPPLY AND INSTALL FILM PATTERN ON WINDOWS WHERE NOTED IN SCHEDULE.
- 4 REFER TO WINDOW TYPE DETAILS AND SPECIFICATIONS FOR MORE INFORMATION.
- 5 PROVIDE TEMPERED GLASS WHERE SHOWN ON ELEVATIONS.
- 6 SILL HEIGHTS ARE SHOWN FROM FINISHED FLOOR.
- 7 REFER TO INTERIOR ELEVATIONS FOR FINISH INFORMATION.
- 8 WOOD WINDOWS TO BE NORWOOD WINDOWS PREFINISHED W/FLEXACRON COATING STANDARD COLOUI
- 9 VINYL WINDOWS TO BE OSTACO
- 10 DISTRIBUTER CONTACT FOR NORWOOD & OSTACO WINDOWS JEFF CARINS OF RIDLEY, CELL 416-727-7673
- 11 REFER TO WINDOW AND DOOR COVERING SCHEDULE ON A1003







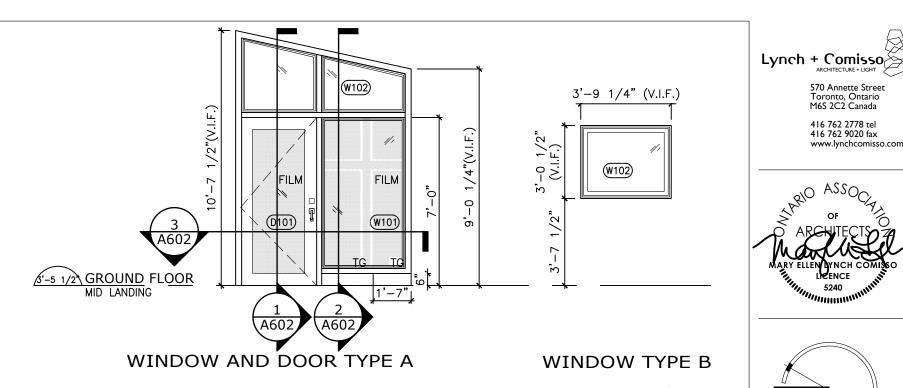

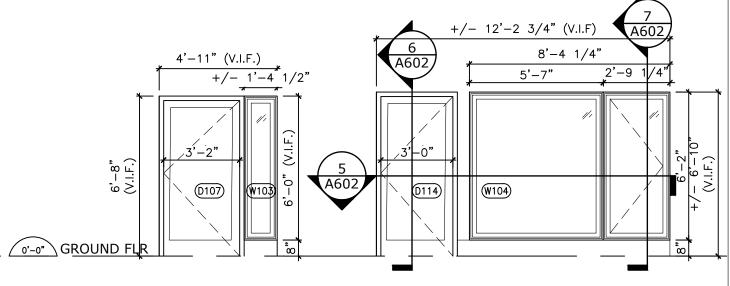


WINDOW & DOOR TYPE C WINDOW & DOOR TYPE D

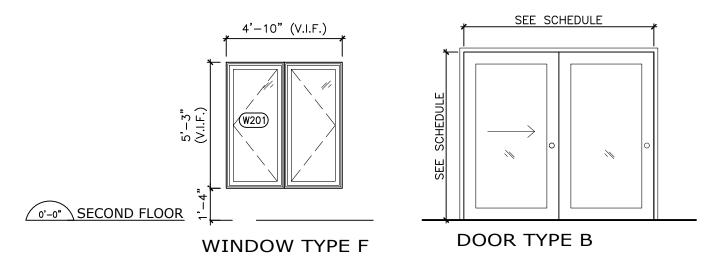

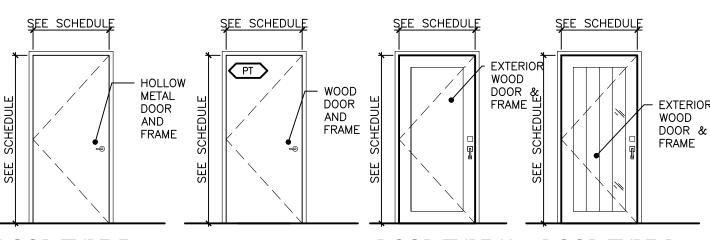

DOOR TYPE H DOOR TYPE J DOOR TYPE F DOOR TYPE G

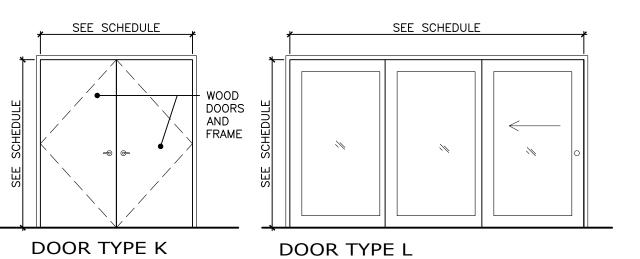

DOOR AND WINDOW TYPES SCALE: 1/4" = 1'-0'

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ST MARY STAR OF THE SEA

RECTORY RENOVATION

**II PETER STREET SOUTH** MISSISSAUGA, ON, L5H 2GI

SEPTEMBER 2020

DRAWN BY: CHECKED BY:

DRAWING NAME: DOOR AND

WINDOW **SCHEDULES** SCALE:

DRAWING #:

2011

DOOR SCHEDULE