

		Sheet Issue	Current
Sheet Number	Sheet Name	Date	Revision
A0-000	COVER	07/19/23	01
A0-001	SITE STATISTICS	07/19/23	02
A0-002	SITE PLAN	07/19/23	02
A0-003	FLOOR AREA PLAN	07/19/23	02
A0-004	CONSTRUCTION NOTES	07/19/23	02
A1-001	PROPOSED BASEMENT FLOOR PLAN	07/19/23	02
A1-002	PROPOSED GROUND FLOOR PLAN	07/19/23	02
A1-003	ROOF FLOOR PLAN	07/19/23	02
A2-001	PROPOSED NORTH & SOUTH ELEVATION	07/19/23	02
A2-002	PROPOSED EAST & WEST ELEVATION	07/19/23	02
A3-001	PROPOSED SECTION	07/19/23	01
A4-001	DOOR & WINDOW SCHEDULE	07/19/23	01
A4-002	DETAILS	07/19/23	01



1050 OLD DERRY RD MISSISSAUGA **ON L5W 1A1**

Owner



REVISIONS

No.	Description	Date
01	ISSUED FOR CLIENT	2023-07-19

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DRAWING TITLE

COVER

DRAWN CHECKED SA

SCALE @ ARCH D 07/19/23 As Noted

PROJECT NO.

230122

LOCATION
MISSISSAUGA

	FIRM NAME: QBS ARCHITECTS INC 1670 BAYVIEW AVENU TORONTO, ON M4G 3C2		401										ARCHI O ARCHI SAB	TECTS Z
	CERTIFICATE OF PRA	CTICE NU	IMBER: 5	5235									SABA AL I	ICE AND
	NAME OF PROJECT: 2	30122											The englished noted	ahawa haa awari
	LOCATION: 1050 OLD	DERRY RI	D MISSI	SAUGA									The architect noted a responsible control design activities. The number is the automatical control of the sign activities are sign activities.	ol with respect to he architect's seal
No.	ONTARIO'S BUILDING	CODE DA	TA MAT	RIX PART	9 RESID	ENTIA	L						OBC REFERENCE	
													References are to I noted [A] for Division Division C.	
1	PROJECT DESCRIPTION	ON:						=	NEW		PA	RT 11	PART 3	X PART 9
						LIANO			ADDITION		11.1 T	O 11.4	2.1.1.[A]	2.1.1.[A] 9.10.1.3
2	MA IOR OCCURANCY	2).		POLIDICE			E OF USE CCUPANCY		ALTERATIO	V			3.1.2.1.(1)	9.10.2
3	MAJOR OCCUPANCY(: BUILDING AREA (m²):	5):		XISTING: 9			NEW: 118.26						1.4.1.2.[A]	1.4.1.2.[A]
4	GROSS AREA (m²):			XISTING: 9			NEW: 118.26						1.4.1.2.[A]	1.4.1.2.[A]
5	NUMBER OF STOREYS	3		BOVE GR			BELOW GRA						1.4.1.2.[A] & 3.2.1.1.	
6	NUMBER OF STREET/I	FIRE FIGH	HTER AC	CCESS:	1								3.2.2.10 & 3.2.5	9.10.20
7	BUILDING CLASSIFICA	TION:											3.2.2.2083	9.10.2
8	SPRINKLER SYSTEM F	PROPOSE	:D:					ENTIRE BUILDIN	G				3.2.2.2083	9.10.8.2
								SELECTED COM		3			3.2.1.5	
							=	SELECTED FLOO				DE DOOF	3.2.2.17 INDEX	INDEX
								BASEMENT ONL' NOT REQUIRED	Y		ATING	OF ROOF	INDEX	INDEX
9	STANDPIPE REQUIRED	D:						YES		X N	IO		3.2.9	N/A
10	FIRE ALARM REQUIRE							YES		=	10		3.2.4	9.10.18
11	WATER SERVICE/SUP	PLY IS AD	EQUAT	E:			$\overline{\mathbf{X}}$	YES (MUNICIPAL	.)	□ N	Ю		3.2.5.7	N/A
12	HIGH BUILDING:						Ħ.	YES	•	X N	Ю		3.2.6	N/A
13	CONSTRUCTION REST	RICTION		NON-CON PERMITTE		.E	X	COMBUSTIBLE F	REQUIRED	В	ОТН		3.2.2.2083	9.10.6
	ACTUAL CONSTRUCTI	ON:		NON-CON		.E	\times	COMBUSTIBLE		В	ОТН			
14	MEZZANINE(S) AREA (m²):	N.	I/A									3.2.1.1.(3)-(8)	9.10.4.1
15	OCCUPANT LOAD BAS	ES ON:		m²/PERSO	NC		\times	DESIGN OF BUIL	DING				3.1.17	9.9.1.3
	BASEMENT:			CCUPANO	_			LOAD2_ PERS						
	1st FLOOR:			CCUPANO	_			LOA <u>D 4</u> PERSO LOAD PERSON						
	2nd FLOOR: 3rd FLOOR:			CCUPANO	_			LOAD_PERSON LOAD PERS						
	ROOF:			CCUPANO	_			LOAD PERS						
16	BARRIER-FREE DESIG	iN		\Box	YES [X	IO (EXPLA	AIN) BUILDING IS	A HOUSE (E	EXEMPT)		3.8	9.5.2
17	HAZARDOUS SUBSTAI	NCES			YES [X	10						3.3.1.2. & 3.3.1.19	9.10.1.3(4)
18	REQUIRED FIRE	НС	ORIZON	TAL ASSE	MBLIES	FRR (H	HOURS)	LISTED DE	SIGN No. OI	R DESCF	RIPTION	(SG-2)	3.2.2.2083	9.10.8
	RESISTANCE RATING (FRR)	FLOOR	S			0	HOURS						3.2.1.4	9.10.9
	()	ROOF				0	HOURS							
		MEZZAI					A HOURS							
				SUPPORT	ING MEN			LISTED DE	SIGN No. OI	R DESCF	RIPTION	(SG-2)		
		FLOOR	S				HOURS							
		ROOF	NIINIE				HOURS						-	
19	SPATIAL SEPERATION	MEZZAI		N OF EYT	ERIOP W		A HOURS							
13	WALL	AREA O		L.D.		L/H	PERMITTE		FRR	LIST		COMB.	COMB.	NON-COMB.
		E.B.F. (sq.ft)	(sq.m)	(ft)	(m)	OR H/L	MAX % OF OPENINGS		(HOURS)	DESIG DESCR		CONST.	CONST. NONC. CLADDING	CONSTR.
	FRONT		NG TO F					\ \ \ \ \ \ \ \ \ \ \ \ \ \ \ \ \ \ \				X		
	SIDE (NORTH)			REMAIN								X		
ı İ	REAR	39.97	3.7	49.21	15		100%					$\overline{\mathbb{X}}$		
	TILAIT	55.57	0.7	10.21	1.0		10070					_ لاكا		

NEW BY-LAW

					(sq.m)	(sq.f
ZONING: RD (RESIDENTIAL DETAC	CHED) R 01 -3	2				
MINIMUM LOT AREA ALLOWABLE COVERAGE: 25% ALLOWABLE FSI: -					1050 380 -	113 4089 -
EXISTING LOT AREA:					1520 m²	1635
EXISTING BASEMENT FLOOR: EXISTING GROUND FLOOR: EXISTING TOTAL GFA: EXISTING FSI:					104 m² 99 m² 99	1115 S 1066 S 106
EXISTING TOTAL COVERA	AGE: 6.5%				99	106
PROPOSED BASEMENT FLOOR PROPOSED GROUND FLOOR PROPOSED TOTAL GFA PROPOSED FSI					EXISTING 118.26 m ² 118.26 m ²	1273
					-	· .
PROPOSED TOTAL COVE	RAGE: 7.7	'6%			- 118.26 m ²	1273
PROPOSED TOTAL COVER	RAGE: 7.7		EXISTI	NG	118.26 m ²	
	1		EXISTII (m)	NG (ft)		

GENERAL NOTES

- ALL CONSTRUCTION TO COMPLY WITH CURRENT EDITION OF THE ONTARIO BUILDING CODE 2012 OBC, AS AMENDED.
- ALL WORKMANSHIP IS TO BE OF A STANDARD EQUAL IN ALL RESPECTS TO GOOD BUILDING PRACTICE.
- DRAWINGS AND SPECIFICATIONS ARE PROPERTY OF THE ARCHITECT AND MUST BE RETURNED ON COMPLETION OF THE PROJECT.
- REPORT IN WRITING ALL DISCOVERED ERRORS OR OMISSIONS TO THE ARCHITECT AT ONCE.
- DO NOT SCALE DRAWINGS. USE LATEST SCALE DRAWINGS ONLY.
- CONTRACTOR TO VERIFY ALL VERTICAL AND HORIZONTAL SITE DIMENSIONS PRIOR TO COMMENCING WORK -INCLUDING EXTERIOR LANDSCAPING DIMENSIONS.
- CONTRACTOR TO PROVIDE PLYWOOD HOARDING AROUND THE PERIMETER OF THE JOB SITE BETWEEN THE PROPOSED NEW STRUCTURE TO THE PROPERTY LINE. IF ADDITIONAL STAGING/STORAGE AREA IS REQUIRED, CONTRACTOR TO APPLY FOR PERMIT TO BUILD HOARDING ON CITY PROPERTY. IN LIEU OF PLYWOOD HOARDING, A 7'-0" HIGH CHAIN LINK FENCE BY "FAST FENCE" OR EQUAL IS TO BE USED.
- SITE MUST BE SAFE AND SECURE AT ALL TIMES. CONTRACTOR RESPONSIBLE FOR LOCKING THE CONSTRUCTION GATE
- CONTRACTOR MUST POST "NO TRESPASSING" AND "DANGER-CONSTRUCTION AREA" SIGNS AS WELL AS ANY OTHER SIGNS REQUIRED BY ANY GOVERNING BODY .G. HEALTH AND SAFETY, ETC.
- EXISTING GRADE DIMENSIONS DISTURBED DURING CONSTRUCTION TO BE MAINTAINED UNLESS OTHERWISE NOTED ON LOT DRAINAGE PLAN. ALL BACKFILL MUST BE EVELED. ADD 4" TOPSOIL AND SOD IN ALL AREAS DISTURBED DURING
- REPAIRS TO EXISTING LANDSCAPING USE TRIPLE MIX SOIL AT ALL PLANTING BEDS.
- REFER TO ARBORIST REPORT (WHERE APPLICABLE) FOR SPECIAL INSTRUCTION REGARDING EXCAVATION / CONSTRUCTION IN PROXIMITY TO MATURE TREES.
- EVERY EXCAVATION SHALL BE UNDERTAKEN IN SUCH A MANNER AS TO PREVENT MOVEMENT WHICH WOULD CAUSE DAMAGE TO ADJACENT PROPERTY, EXISTING STRUCTURES, UTILITIES, ROADS AND SIDEWALKS AT ALL STAGES OF
- ENSURE ADEQUATE BRACING OF FOUNDATION WALLS PRIOR TO BACKFILLING.
- ALL STRUCTURAL WOOD TO BE #2 SPRUCE OR BETTER UNLESS NOTED OTHERWISE.
- PROVIDE POSTS UNDER ALL BEAMS / GIRDER TRUSSES, ETC. POSTS TO RUN CONTINUOUS TO FOUNDATION OR EQUIVALENT SUPPORT.
- ALL STUMPS, ROOTS AND OTHER DEBRIS SHALL BE REMOVED FROM HE SOIL TO A MIN. DEPTH OF 12" IN UNEXCAVATED AREAS UNDER A BUILDING. WOOD DEBRIS REMOVAL SHALL EXTEND 2'- 0" MIN. BEYOND THE PERIMETER OF THE BUILDING.
- ALL WOOD SCRAPS AND FORMS SHALL BE REMOVED FROM AROUND THE FOUNDATIONS BEFORE BACKFILLING AND FROM UNDER EXTERIOR STEPS OR PORCHES BEFORE CONSTRUCTION IS COMPLETED.
- ALL EXISTING SURFACES ADJACENT TO NEW CONSTRUCTION AND THROUGH WHICH CONSTRUCTION MATERIALS AND CONTRACTOR'S FORCES MOVE ARE TO BE PROTECTED.
- PROVIDE TEMPORARY DUST BARRIERS AS REQUIRED TO MAINTAIN DUST FREE ENVIRONMENT FOR ALL BUILDING AREAS OCCUPIED BY OWNER / TENANTS.
- CONTRACTOR SHALL MAINTAIN THE JOB SITE AND WORK IN A TIDY CONDITION. DAILY CLEAN UP OF JOB SITE IS REQUIRED.
- REMOVE ALL CONSTRUCTION DEBRIS FROM SITE UNLESS OTHERWISE NOTED. ALL WOOD FRAMING MEMBERS SUPPORTED ON CONCRETE WHICH IS IN DIRECT CONTACT WITH SOIL IS TO BE SEPARATED FROM CONCRETE WITH DAMP PROOFING MATERIAL (9.23.2.3 OBC)
- GARAGE ACCESS DOOR TO BUILDING TO BE C/W SELF CLOSURE MECHANISM AND GAS TIGHT.
- ALL WINDOWS LOCATED WITHIN 6'7" FROM GRADE, SHALL CONFORM TO CLAUSE 10.13 OF CSA STANDARD A440-M90 AND 9.7.6.1 OBC (RESISTANCE TO FORCED ENTRY). SUPPLY AND INSTALL 6" SMOOTH CUT LIMESTONE THRESHOLD / SILL AT ALL EXTERIOR DOORS / WINDOWS (INCLUDING BASEMENT).
- ALL GUARD RAILS ARE TO SUSTAIN MINIMUM LOADING AS PER OBC 4.1.10.1 AND 9.8.8 FOR HEIGHT AND SPACING OF PICKETS. HANDRAILS AND TO CONFIRM WITH 9.8.8 OBC.
- ALL INTERIOR TRIM TO BE POPLAR (PAINT) UNLESS OTHERWISE NOTED, EXTERIOR TRIM TO BE #1 CLEAR PINE (PAINT). NOTE: USE KIL ON ALL KNOTS PRIOR TO PRIMER COAT. ALL WOOD TO BE KEPT DRY AND MUST NOT BE PAINTED IN TEMPERATURES OF LESS THAN 10 DEGREES CELSIUS.
- ALL TRIM TO BE PRE-PAINTED (PRIMER + ONE COAT) PRIOR TO INSTALLATION.
- CONTRACTOR MUST RECEIVE PERMISSION FROM OWNER PRIOR TO INSTALLATION OF JOB SIGN.
- SEE INSTRUCTIONS TO CONTRACTOR FOR ADDITIONAL SPECIFICATIONS AND CASH ALLOWANCES.
- CONTRACTOR TO USE FLEXIBLE CORNER BEAD AT ALL RADIUSES DRYWALL EDGES.
- THESE WORKING DRAWINGS ARE BASED ON "MEASURED DRAWINGS" OF THE EXISTING BUILDING, NOT "RECORD DRAWINGS", WHICH ARE THE ORIGINAL CONSTRUCTION DRAWINGS REVISED TO REFLECT "AS BUILT" CONDITIONS. MEASUREMENTS HAVE BEEN TAKEN TO EXTERIOR SURFACES ONLY, AND EXCEPT WHERE NOTED NO ATTEMPT HAS BEEN MADE TO VERIFY HIDDEN CONDITIONS.
- NO REPRESENTATION IS MADE THAT THE BUILDING CONFORMS TO ANY CODE REQUIREMENTS, OR ANY CONSTRUCTION DRAWINGS THAT MAY HAVE BEEN PREPARED BY OTHERS.

ELECTRICAL SYSTEM

- NOTE: REPORT ANY LAYOUT DISCREPANCIES TO THE ARCHITECT PRIOR TO THE INSTALLATION.
- SEE ALSO ATTACHED REFLECTED CEILING PLANS AND ELECTRICAL SPECIFICATIONS.
- ADEQUATE SIZE TO HANDLE ALL ELECTRICAL REQUIREMENTS.
- CONTRACTOR TO ENSURE EXISTING ELECTRICAL PANEL(S) IS ADEQUATE TO SERVE BOTH EXISTING AND PROPOSED ADDITION'S
- CONTRACTOR RESPONSIBLE FOR OBTAINING ONTARIO HYDRO

BUILDER / GENERAL CONTRACTOR MUST RETAIN THE SERVICES OF A PROFESSIONAL SURVEYOR FOR THE STAKING OUT OF NEW FOUNDATIONS, SURVEYOR MUST BE GIVEN 72 HOURS NOTICE BEFORE BEING REQUIRED ON SITE.

TO BEGIN DEMOLITION/CONSTRUCTION:

- SITE FENCING- BUILDER / GENERAL CONTRACTOR MUST ENLOSE ENTIRE SITE WITH A FENCE THAT IS IN BOTTOM WIRE THREADED THROUGH THE MESH AND LOOPED AROUND EACH POST.
- CONSTUCTION NOISE- ANY CONSTRUCTION WHICH GENERATES NOISE IS PROHIBITED IN RESIDENCIAL AREAS BETWEEN THE HOURS OF 7:00PM ONE DAY TO 7:00AM THE NEXT DAY, 9:00AM ON SATURDAYS, AND ALL DAY SUNDAY
- CALL FOR INSPECTIONS- THE BUILDER/ GENERAL CONTRACTOR IS REQUIRED TO NOTIFY THE BUILDING INSPECTION OFFICE AT VARIOUS STAGES OF CONSTRUCTION AS REQUIRED BY DIVISION C, PART 1, ARTICLE 1 3 5 1 OF THE ONTARIO BUILDING CODE THE PHONE NUMBER FOR THE BUILDING INSPECTION OFFICE RESPONABILE FOR THE PROJECT'S AREA WILL BE
- PERMIT PLANS- THE PERMIT PLANS AND SPECIFICATIONS MUST BE ON THE SITE AT ALL TIMES. THE PERMIT PLANS AND SPECIFICATIONS PROVIDED TO THE BUILDER/ GENERAL CONTRACTOR WILL BE USED FOR INSPECTIONS.

- CONTRACTOR TO COORDINATE STRUCTURAL JOISTS AND STUD LAYOUTS TO ACCOMMODATE THE ELECTRICAL POTLIGHTS, ETC.
- CONTRACTOR TO INSTALL APPROVED ELECTRICAL PANEL(S) OF

SURVEY NOTE

COMPLIANCE WITH THE CITY OF TORONTO MUNICIPAL CODE CHAPTER 363, ARTICLE III. THE MIN. REQUIREMENT IS A PLASTIC MESH FENCE, 1.2M HIGH, TIED TO POSTS SPACED NO MORE THAN 1.2M APART, WITH AN 11 GAUGE TOP AND

AND STATUTORY HOLIDAYS.

- INCULDED IN THE PERMIT DOCUMENTS.

1050 OLD DERRY **MISSISSAUGA ON L5W 1A1**

PROJECT



REVISIONS

No.	Description	Date
02	ISSUED FOR HERITAGE CONSULTANT	2023-10-26
01	ISSUED FOR CLIENT	2023-07-19

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CONSULTANTS





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DRAWING TITLE

SITE STATISTICS

DRAWN CHECKED

SCALE @ ARCH D DATE As Noted 12" = 1'-0"

GRAPHIC SCALE


PROJECT NO.

230122 STAGE DRAWING NO.

MISSISSAUGA

REVISION

07/19/23

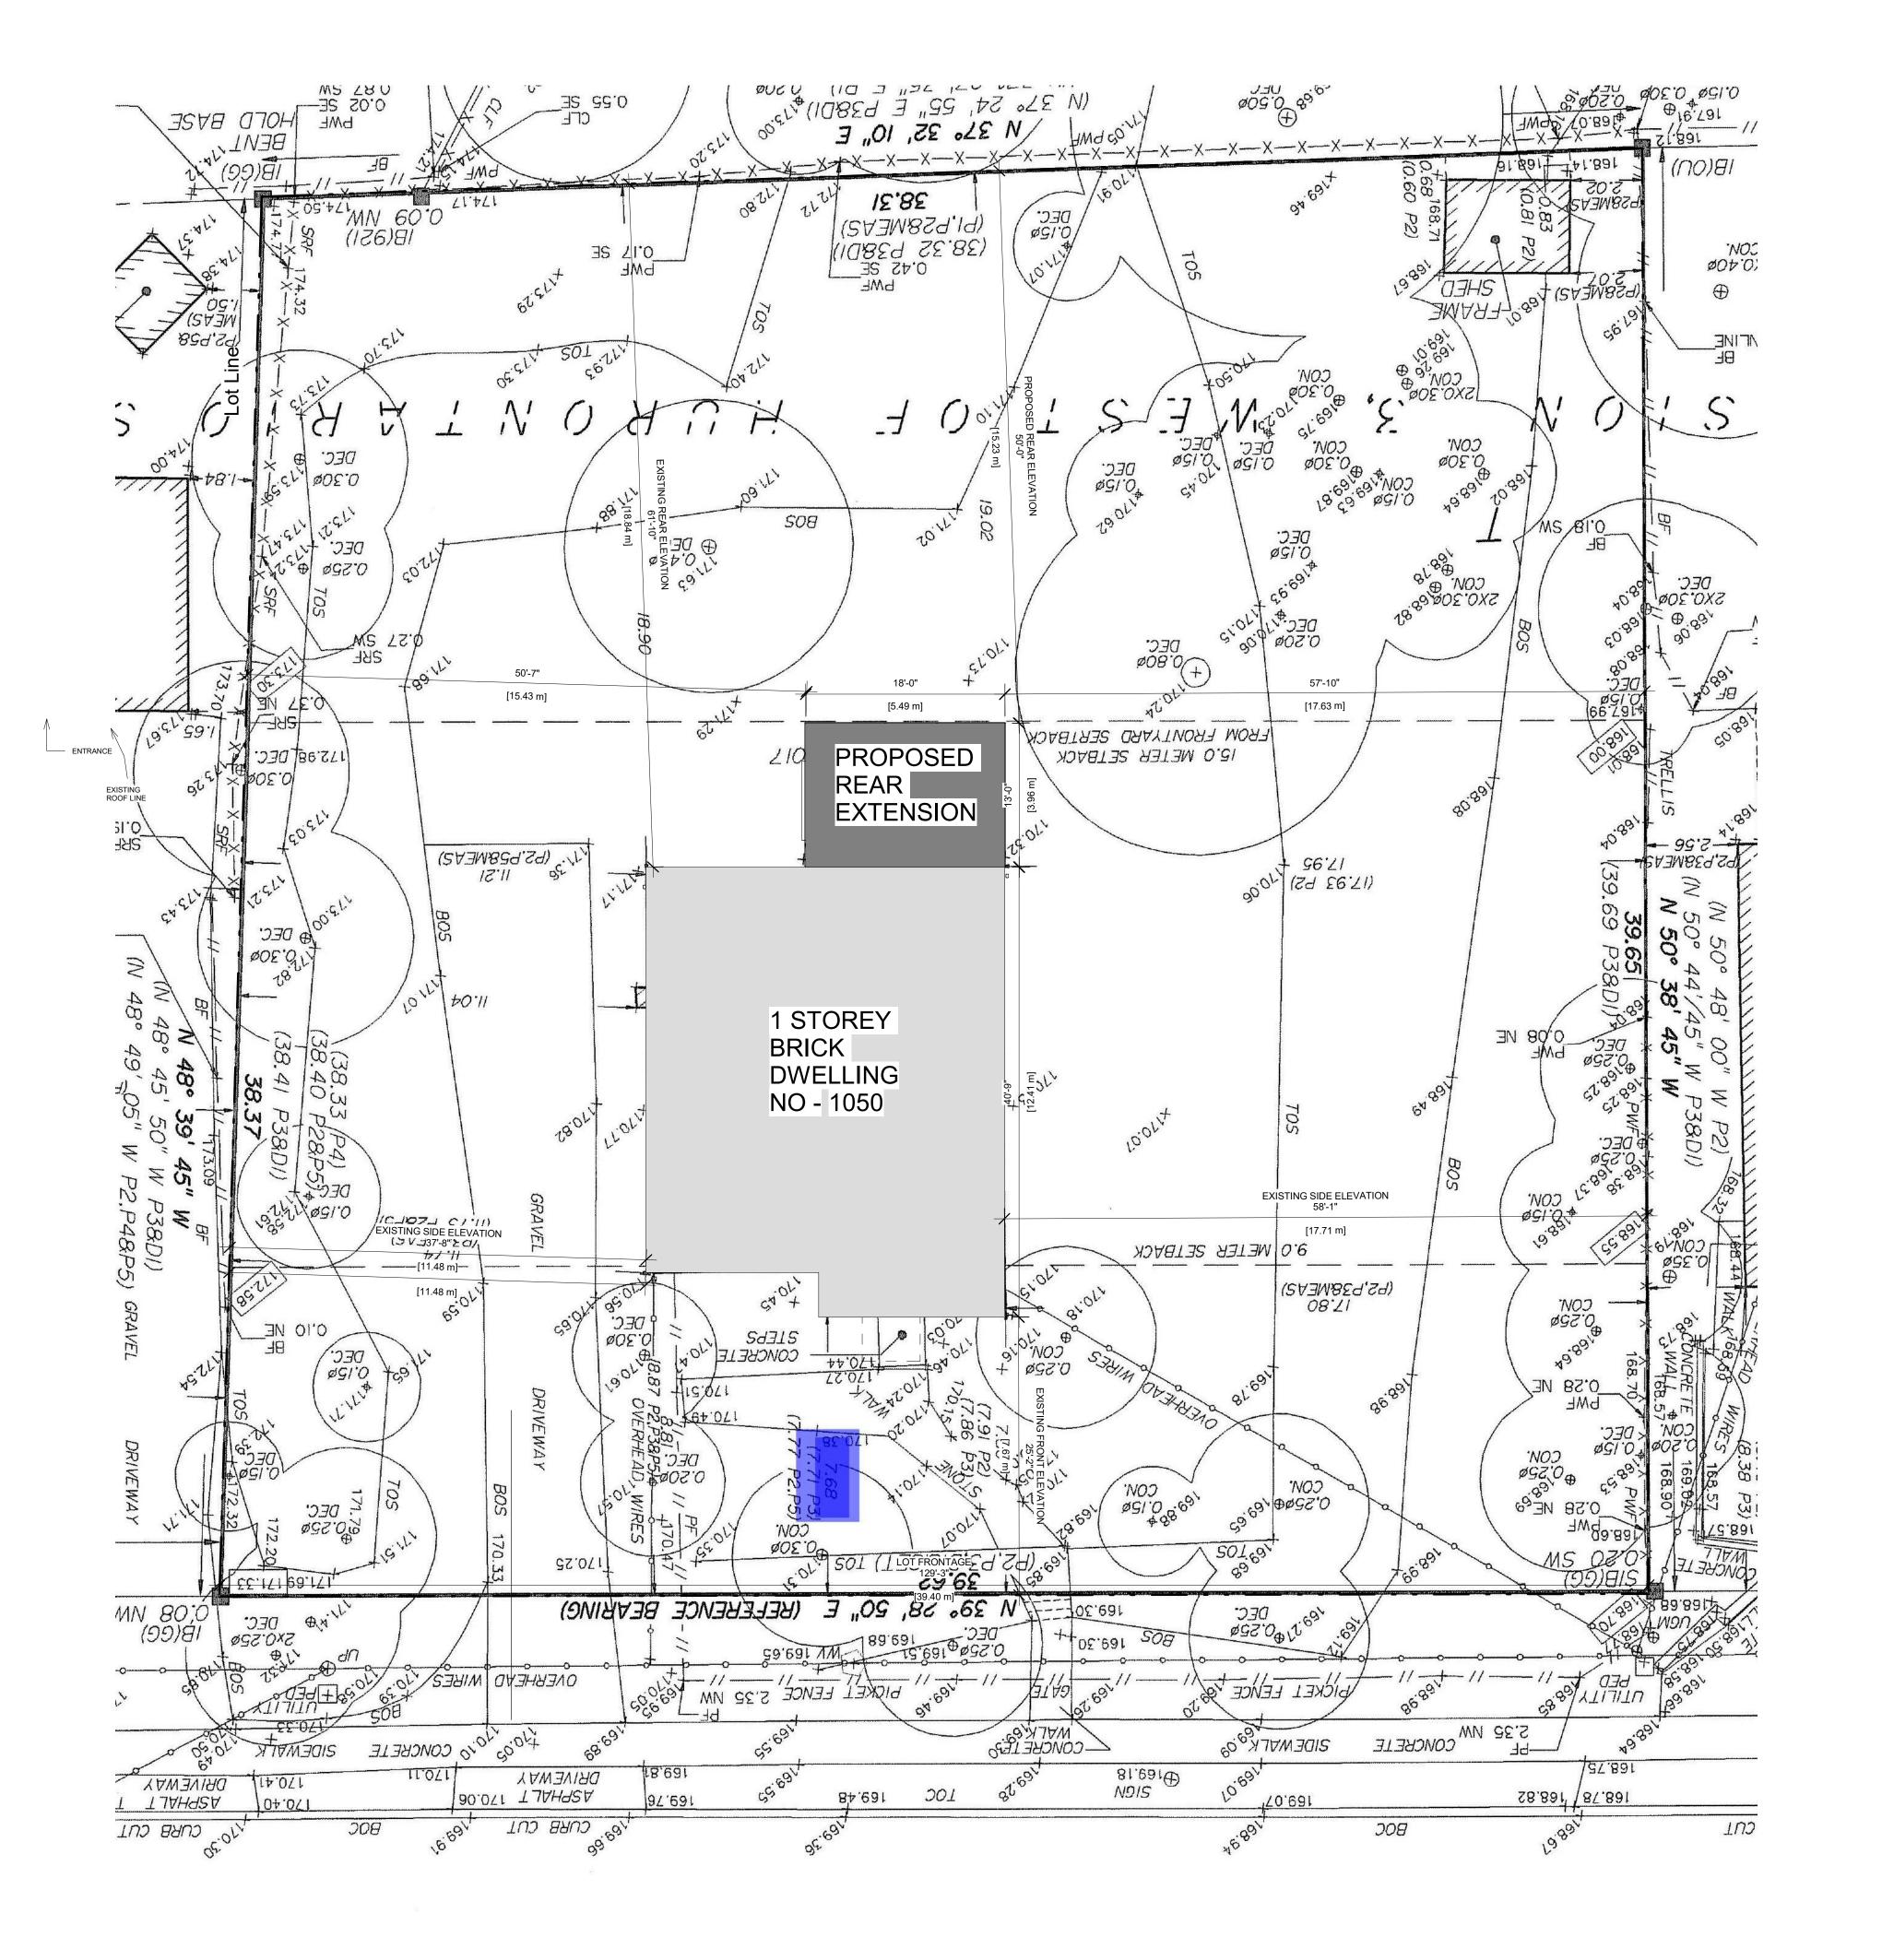

1050 OLD DERRY

8.1

MISSISSAUGA ON L5W 1A1

PROJECT

Owner



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DRAWING TITLE SITE PLAN

DRAWN CHECKED SA

SCALE @ ARCH D As Noted 1/8" = 1'-0"

07/19/23

PROJECT NO. 230122

STAGE

DRAWING NO. A0-002

MISSISSAUGA

02

SITE PLAN



1 BASEMENT 1/4" = 1'-0"

GROUND FLOOR GROSS AREA Gross Building Area PROPOSED AREA 207 SF GROUND FLOOR AREA 1066 SF

GROUND FLOOR

1/4" = 1'-0"

1050 OLD DERRY **MISSISSAUGA ON L5W 1A1**

Owner



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FLOOR AREA PLAN

CHECKED

As Noted 1/4" = 1'-0"

PROJECT NO. 230122

A0-003

LOCATION
MISSISSAUGA

1 EXTERIOR WALL - BRICK -3 1/2" NATURAL BRICK, COLOR TO MATCH EXISTING BRICK COLOR . - 'TYPAR' HOUSEWRAP BY REEMAY, INSTALL AS PER MANUFACTURER SPECIFICATIONS; LAP & TAPE ALL JOINTS

- 1/2" ORIENTED STRAND BOARD -1"AIR SPACE - 2 X 6 STUDS AT 16" O.C.

- BATT INSULATION (R-19 + 5ci) - 6 MIL. VAPOUR / AIR BARRIER "SUPER SIX". LAP ALL JOINTS MIN. 3" AND SEAL W/ACOUSTIC TYPE SEALANT

- 5/8" "TYPEX" DRYWALL, WHERE SETBACK IS LESS THAN 4' AWAY FROM PROPERTY LINE

(3) POST + BEAM WALL CONSTRUCTION - 1" X 8" / 1" X 10" CEDAR CLAPBOARD (PROFILE TO BE DETERMINED), PRE-STAINLESS STEEL NAILS

SPECIFICATIONS; LAP & TAPE ALL JOINTS

- 1/2" ORIENTED STRAND BOARD - R-28 STRUCTURAL INSULATED WALL PANELS - 6 MIL. VAPOUR / AIR BARRIER "SUPER SIX". LAP ALL JOINTS MIN. 3" AND SEAL ACOUSTIC TYPE SEALANT - TIMBER FRAME (SIZE AS PER PLANS) FULLY JOINED EASTERN WHITE PINE

- 'TYPAR' HOUSEWRAP BY REEMAY, INSTALL AS PER MANUFACTURER

- 1" X 8" T & G EASTERN WHITE PINE (STAIN TO BE DETERMINED)

4 ROOF CONSTRUCTION

- ASPHALT SHINGLES (25 YEARS) - COLOUR TO BE DETERMINED - 1/2" PLYWOOD SHEATHING (WITH 'H' CLIPS IF USING TRUSSES) - ROOF STRUCTURE AS SPECIFIED IN TRUSS PLAN AND LAYOUTS - PROVIDE ICE AND WATER SHIELD EAVES PROTECTION TO EXTEND 36" MIN. BEYOND INTERIOR FACE OF EXTERIOR WALL. MIN. 3" LAP AND 6" END LAP (AS

- PREFINISHED ALUMINUM DRIPEDGE BELOW SHINGLES - PREFIN. ALUMINUM EAVESTROUGH ON ALUMINUM FASCIA & VENTED ALUMINUM SOFFIT W/INSECT SCREEN TO MATCH EXIST. - 2 X 6 CEILING JOISTS @ 16" O.C. - 2 X 9 1/2" STANDARD OR 2 X 8" HIGH DENSITY (R-60) BATT INSULATION -

BAFFLE AS REQUIRED FOR VENTILATION - 6 MIL. VAPOUR / AIR BARRIER "SUPER SIX". LAP ALL JOINTS MIN. 3" AND SEAL - 1/2" DRYWALL.

5 SKYLIGHT (SLOPED ROOFS) $^{\prime}$ - SKYLIGHT BY "VELUX" OR SIMILAR W/ TEMPERED DOUBLE GLAZED SEALED UNIT LOW-E AND ARGON FILLED - INSTALL C/W FLASHING KIT (ACCORDING TO TYPE OF ROOFING) AND AS MANUFACTURER SPECIFICATIONS - NOTE: DOUBLE FRAME ALL SURROUNDING LUMBER AT SKYLIGHT ADJACENT FINISHED ROOF -TO COMPLY WITH CAN/CSSB - 12.2-M89-7.3 SLOPED GLAZING AND

6 EAVESTHROUGH / DOWNPIPES - 5" - 6" MAX WIDE PREFINISHED ALUMINUM EAVESTROUGH (COLOUR TO BE - 3" X 4" PREFINISHED ALUMINUM DOWNPIPES (COLOUR TO BE DETERMINED) C/W CONCRETE SPILL PAD (SLOPE AWAY FROM BUILDING) - NOTE: DOWNPIPES ROUTING TO BE DISCUSSED W/ ARCHITECT PRIOR TO

7 SOFFIT - PREFINISHED ALUMINUM SOFFIT WITH INSECT SCREENING - LAY ALUMINUM PANELS WITH CORRUGATIONS PERPENDICULAR TO FASCIA - SEE DRAWINGS FOR OVERHANG DIMENSION.

(8) EXTERIOR WINDOWS / DOORS (TO COMPLY WITH OBC 9.7) - ALL WINDOWS ARE TO BE WOOD FRAMED CASEMENTS SEALED CLEAR WOOD INTERIOR AND "FLEXACRON" FACTORY PREFINISHED EXTERIOR SURFACES c/w FOLDING TYPE CRANK HANDLE - ALL GLAZING TO BE CLEAR LOW "E" SEALED THERMOPANE UNITS, ARGON GAS FILLED, 7/8" OVERALL THICKNESS

- CONTRACTOR TO SUBMIT NAME AND TYPICAL DETAILS OF PROPOSED MANUFACTURER TO THE ARCHITECT FOR APPROVAL - NOTE: CONTRACTOR TO SUPPLY AND INSTALL 6" SMOOTH CUT LIMESTONE THRESHOLD AT ALL EXTERIOR DOORS AND 5" AT ALL WINDOWS (UNLESS

9 SILL PLATE

- 2 X 6 PRESSURE TREATED SILL PLATE SET ON CONTINUOUS MORTAR BED W/1/2" DIA., 12" LONG (MIN. 4" IN CONCRETE.) ANCHOR BOLTS AT 7'-10" MAX. O.C. - ROLL TYPE FOAM GASKET BETWEEN PLATE AND BEDDING & 6 MIL POLY VAPOUR / AIR BARRIER (BLACK).

 $\langle 10 \rangle$ DRYWALL INSTALLATION

- ALL DRYWALL TO BE INSTALLED WITH BEVELLED EDGE JOINTS FACING EACH - ONLY ONE HORIZONTAL JOINT WILL BE ALLOWED. IF AN ADDITIONAL HORIZONTAL JOINT IS REQUIRED DUE TO WALL HEIGHTS, THE JOINTS MUST BE PLACED AT THE BOTTOM OF THE WALL IN THE BASEBOARD AREA. - USE 4'-6" WIDE BOARDS FOR 9'-0" HIGH CEILINGS.

(11) ENGINEERED HARDWOOD FLOORING

- CONCRETE SUBFLOORS: MUST BE DRY, SMOOTH (LEVEL WITHIN 3/16" IN A 10' RADIUS 1/8" IN 6') AND FREE OF STRUCTURAL DEFECTS. HAND SCRAPE OR SAND WITH A 20-GRIT - #3-1/2" OPEN FACE PAPER TO REMOVE LOOSE, FLAKY CONCRETE. GRIND

HIGH SPOTS IN CONCRETE AND FILL LOW SPOTS WITH A PORTLAND BASED

LEVELING COMPOUND (MIN. 3,000 PSI). CONCRETE MUST BE FREE OF PAINT,

OIL. EXISTING ADHESIVES, WAX, GREASE, DIRT AND CURING COMPOUNDS. THESE MAY BE REMOVED MECHANICALLY BUT DO NOT USE SOLVENT-BASED STRIPPERS UNDER ANY CIRCUMSTANCES. THE USE OF RESIDUAL SOLVENTS CAN PROHIBIT THE SATISFACTORY BOND OF FLOORING ADHESIVES. - IT IS IMPORTANT TO ENSURE A PROPER BOND BETWEEN THE ADHESIVE AND THE CONCRETE, AND PLANKS OR STRIPS. ENGINEERED HARDWOOD FLOORING MAY BE INSTALLED ON-GRADE, ABOVE GRADE, AS WELL AS BELOW

GRADE WHERE MOISTURE CONDITIONS ARE ACCEPTABLE - LIGHTWEIGHT CONCRETE: LIGHTWEIGHT CONCRETE WITH A DRY DENSITY OF 100 POUNDS OR LESS PER CUBIC FOOT IS ONLY SUITABLE FOR ENGINEERED WOOD FLOORS WHEN USING THE FLOATING INSTALLATION METHOD. MANY PRODUCTS HAVE BEEN DEVELOPED AS SELF-LEVELING TOPPINGS OR FLOOR UNDERLAYMENTS. THESE INCLUDE CELLULAR CONCRETE, RESIN-REINFORCED CEMENTATIONS UNDERLAYMENTS, AND GYPSUM-BASED MATERIALS. ALTHOUGH SOME OF THESE PRODUCTS MAY HAVE THE NECESSARY QUALIFICATIONS FOR UNDERLAYMENT FOR WOOD FLOORING INSTALLATIONS, OTHERS DO NOT.

- TO TEST FOR LIGHTWEIGHT CONCRETE, SCRAPE A COIN OR KEY ACROSS THE SURFACE OF THE SUBFLOOR.

- IF THE SURFACE POWDERS EASILY OR HAS A DRY DENSITY OF 100 POUNDS OR LESS PER CUBIC FOOT. USE ONLY THE FLOATING INSTALLATION METHOD O ENSURE A LONG LASTING BOND, MAKE SURE THAT THE PERIMETER OF THE FOUNDATION HAS ADEQUATE DRAINAGE AND VAPOR BARRIER.

- WOOD SUBFLOORS: WOOD SUBFLOORS NEED TO BE WELL NAILED OR SECURED WITH SCREWS. NAILS SHOULD BE RING SHANKS AND SCREWS NEED

- THE WOOD SUBFLOOR NEEDS TO BE STRUCTURALLY SOUND AND DRY. IT - IF THE SUBFLOOR IS SINGLE LAYER, LESS THAN 3/4" THICK, ADD A SINGLE TOTAL 1" THICKNESS).

- THIS IS TO REDUCE THE POSSIBILITY OF SQUEAKING.

- WOOD SUBFLOORS MUST BE FREE OF PAINT, OIL, EXISTING ADHESIVES, WAX,

GREASE, DIRT, URETHANE, VARNISH, ETC. - UNDERLAYMENT GRADE OSB (NOT THE WAX SIDE) IS ALSO A SUITABLE SUBFLOOR. PARTICLEBOARD IS NOT AN ACCEPTABLE SUBFLOOR FOR STAPLE OR NAIL DOWN INSTALLATIONS BUT CAN BE USED AS A SUBFLOOR IN GLUE-DOWN INSTALLATIONS.

- WHEN INSTALLING OVER EXISTING WOOD FLOORING, INSTALL AT RIGHT ANGLES TO THE EXISTING FLOOR. - SUBFLOOR MOISTURE CHECK: ENGINEERED HARDWOOD FLOORING MAY BE USED FOR ABOVE-, ON-, AND BELOW-GRADE APPLICATIONS, ON ALL COMMON SUBSTRATES, ON-AND BELOW-GRADE APPLICATIONS ARE SUSCEPTIBLE TO MOISTURE AND SHOULD BE TESTED FOR MOISTURE PRIOR TO INSTALLATION

IN SEVERAL LOCATIONS WITHIN THE INSTALLATION AREA. - ACCEPTABLE CONDITIONS FOR ABOVE-, ON-, AND BELOW-GRADE APPLICATIONS ARE:

* LESS THAN 3 1BS. /1000 SF / 24 HRS. ON A CALCIUM CHLORIDE TEST * OR AN ACCEPTABLE READING ON AN ELECTRONIC CONCRETE MOISTURE * WOOD SUBSTRATES MUST HAVE A MOISTURE READING OF LESS THAN 13% IIMPORTANT NOTE: THE ABOVE IS A GUIDE LINE. INSTALLER MUST FOLLOW MANUFACTURES INSTALLATION INSTRUCTIONS ASSOCIATED WITH THE

(12) INSULATED FLOOR ASSEMBLY

- FINISHED FLOORING OVER 3/4" T & G PLY SHEATHING GLUED AND SCREWED TO JOISTS; STAGGER JOINTS - 6 MIL. VAPOUR / AIR BARRIER "SUPER SIX" WITH ALL JOINTS SEALED W/ $\,$ ACOUSTIC TYPE SEALANT - JOISTS (AND CROSS BRIDGING IF APPLICABLE) AS NOTED IN PLAN - 8" (R-30) HIGH DENSITY OR 9 1/2" (R-30) STANDARD BATT INSULATION ON GALVANIZED CHICKEN WIRE MESH STAPLED TO UNDERSIDE OF JOISTS - SPRAY 5" (R-32) OF 2 LB / FTCU. POLYURETHANE SPRAY FOAM BY "ISOFOAM" <13 DOORS

- SOLID WOOD (UNLESS NOTED OTHERWISE) 1 3/4" THICK WITH TWO RECESSED RAISED WOOD PANELS AS PER DETAIL SKETCH. DOOR HEIGHTS: ABOVE 9' CEILING 8'-0" DOORS

(14) <u>FLASHING</u>

- PROVIDE PREFINISHED ALUMINUM (COLOUR TO BE DETERMINED) IN ALL THE FOLLOWING LOCATIONS: * BENEATH JOINTED MASONARY SILLS

(INCLUDING BASEMENTS)

* OVER BACKS AND TOPS OF PARAPET WALLS
* OVER HEADS OF GLASS BLOCK PANELS * OVER HEADS OF WINDOWS AND DOORS SET FURTHER THAN 1/4 THE EAVES OVERHANG BELOW THE SOFFIT * AROUND CHIMNEYS, OR ANY ELEMENTS CROSSING ROOF SURFACES THAT ARE NOT SUPPLED WITH MANUFACTURERS FLASHING * AT INTERSECTION OF ROOF SURFACES WITH EXTEROR WALLS * AT ALL ROOF VALLEYS

- 'TYPAR' HOUSEWRAP BY REEMAY, INSTALL AS PER MANUFACTURER SPECIFICATIONS; LAP & TAPE ALL JOINTS - 1/2" ORIENTED STRAND BOARD

- 2 X 4 STUDS AT 16" O.C. - 3 1/2" DOW SM RIGID INSULATION / POLYURETHANE SPRAYED FOAM INSULATION

- 1/2" FOIL "THERMAX" INSULATION

COAT PRIOR TO INSTALLATION.

- 6 MIL. VAPOUR / AIR BARRIER "SUPER SIX". LAP ALL JOINTS MIN. 3" AND SEAL W/ACOUSTIC TYPE SEALANT - 1/2" DRYWALL.

(15) PAINTING

ALL INTERIOR WOOD TRIM: ONE COAT OIL BASED PRIMER, TWO (2) COATS SEMI- GLOSS OIL - ALL DRYWALL SURFACES: ONE COAT LATEX SEALER. TWO (2) COATS SATIN ${\it /}$ EGGSHELL LATEX - ALL EXTERIOR WOOD TRIM: ONE COAT OIL BASED PRIMER, 2 COATS OIL FINISH - ENAMEL GLOSS - ALL COLOURS TO BE SELECTED BY ARCHITECT / CLIENT. - NOTE: REPAINT ALL WOOD DOORS AND WINDOWS PRIME PLUS ONE FINISH

(16) <u>LEDGER BOARD</u>

- CONTINUOUS 2 - 2 X 10 OR AS PER PLANS GLUED LEDGER BOLTED WITH STAGGERED 3/4" DIA. RAM SET RED HEAD DYNA BOLTS @ 18" O.C. - MIN. 2 1/2" EMBEDMENT IN EXISTING SOLID MASONRY WALL. PROJECT

1050 OLD DERRY **MISSISSAUGA ON L5W 1A1**

CLIENT



REVISIONS

No.	Description	Date
02	ISSUED FOR HERITAGE CONSULTANT	2023-10-26
01	ISSUED FOR CLIENT	2023-07-19

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GRAPHIC SCALE

DATE

PROJECT NO.


230122

STAGE DRAWING NO.

REVISION

07/19/23

MISSISSAUGA

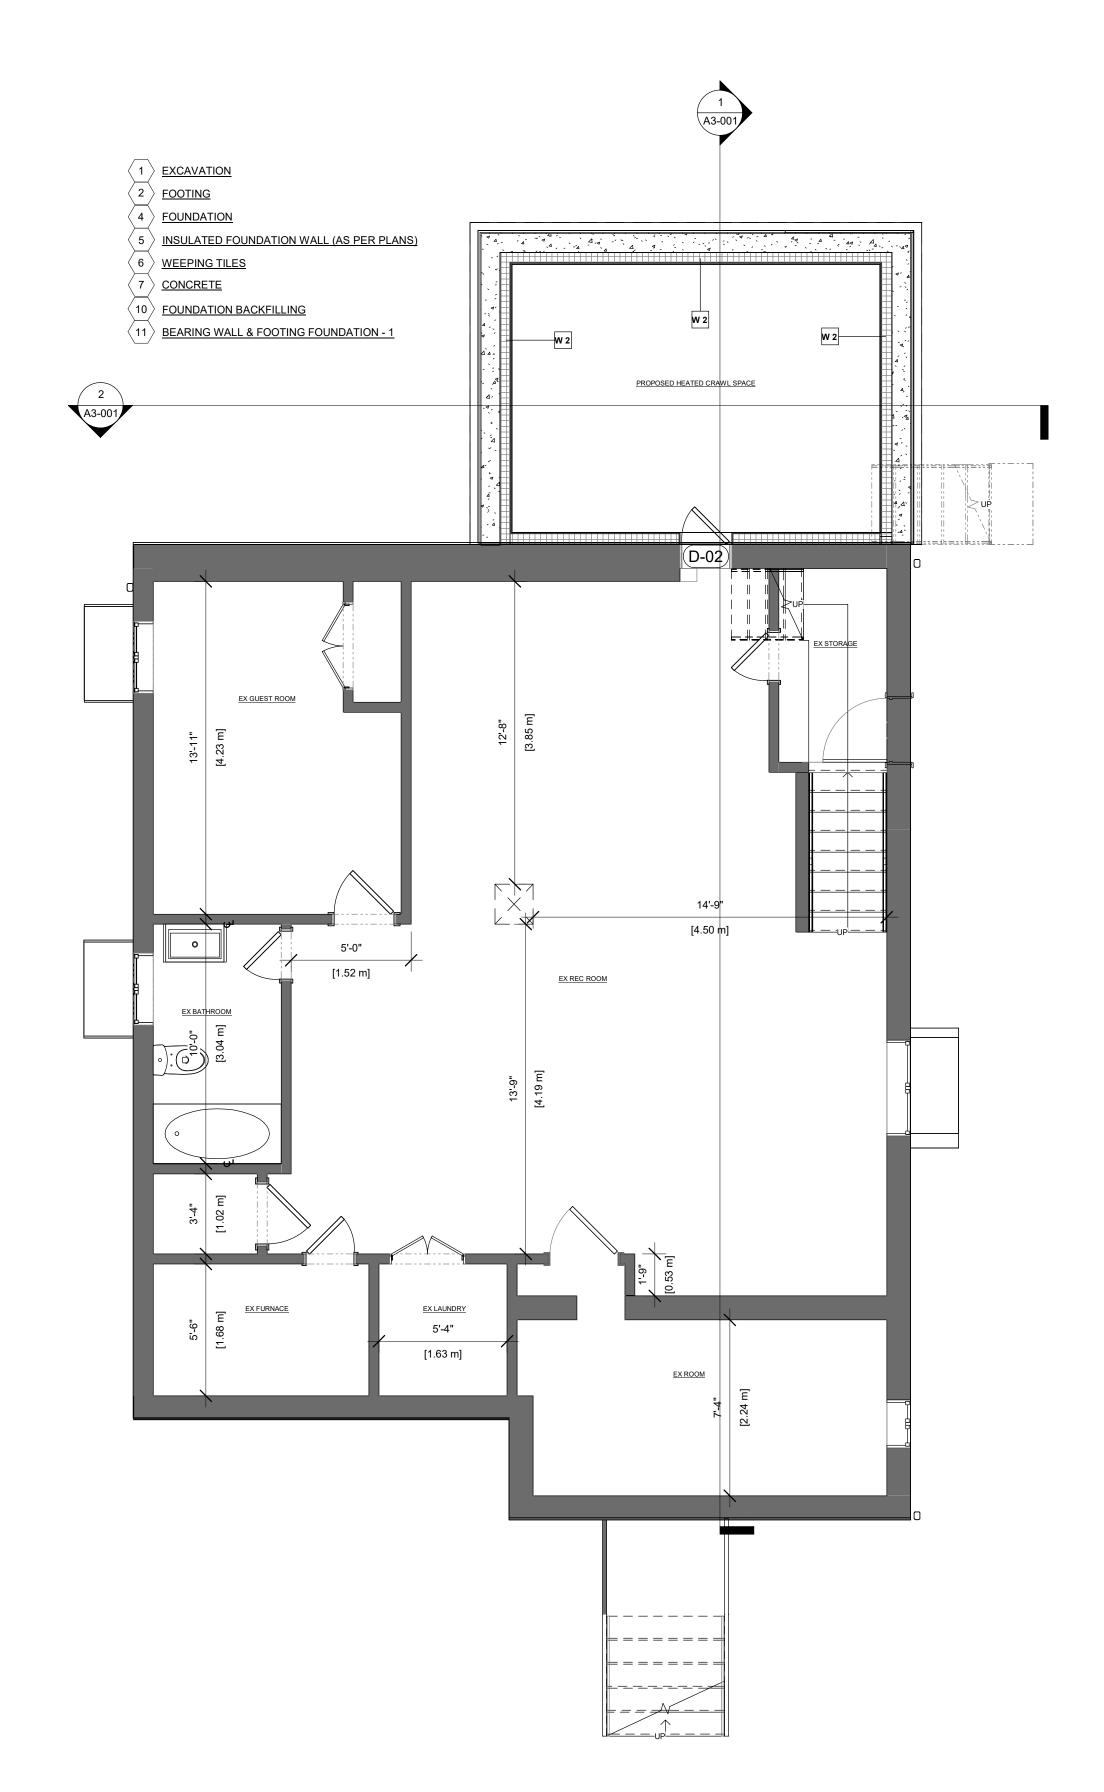

1 BASEMENT PLAN
1/4" = 1'-0"

PROJECT

1050 OLD DERRY RD MISSISSAUGA ON L5W 1A1

CLIENT

Owner



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RAWING TITLE

PROPOSED BASEMENT FLOOR PLAN

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PROJECT NO. 230122


70

A1-001

LOCATION RE MISSISSAUGA

02

07/19/23

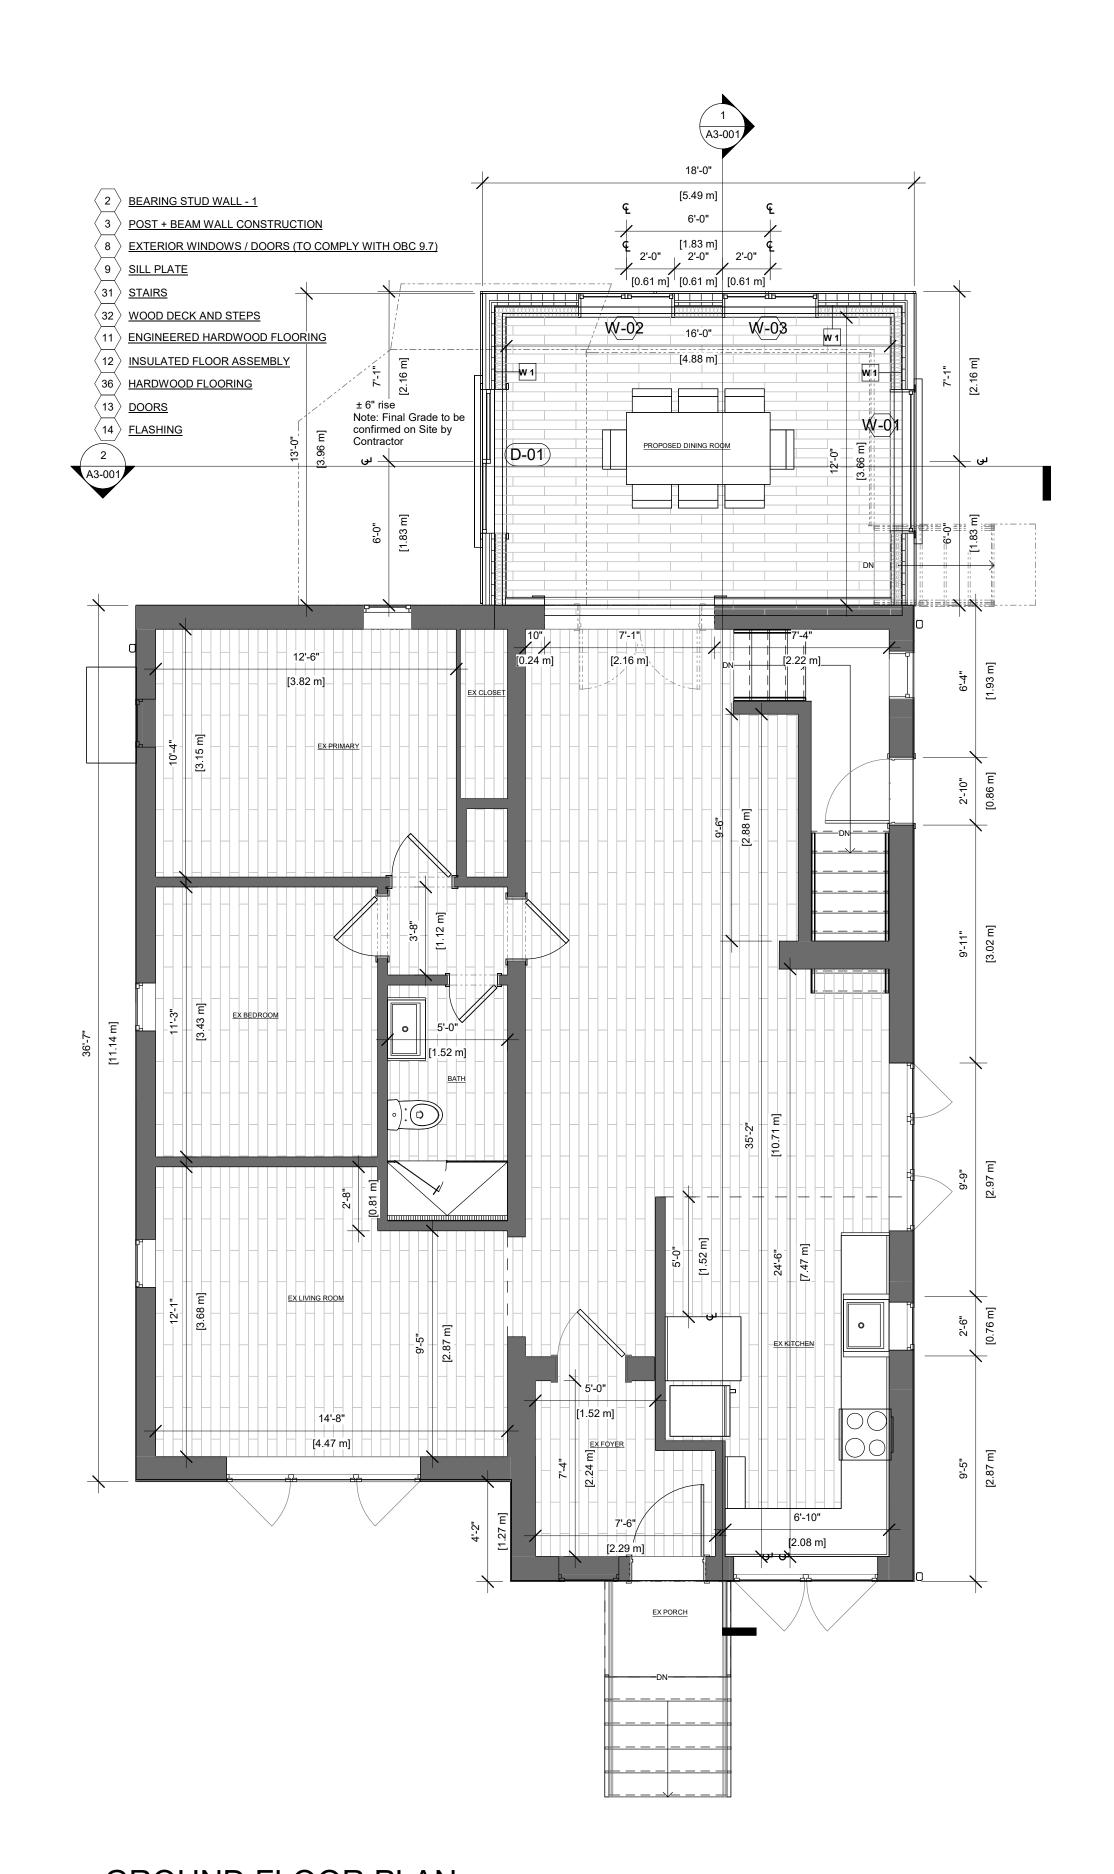

1 GROUND FLOOR PLAN
1/4" = 1'-0"

PROJECT

1050 OLD DERRY RD MISSISSAUGA ON L5W 1A1

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PLAN

PROPOSED GROUND FLOOR

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GRAPHIC SCALE

PROJECT NO. 230122


STAGE

A1-002

LOCATION
MISSISSAUGA

02

07/19/23

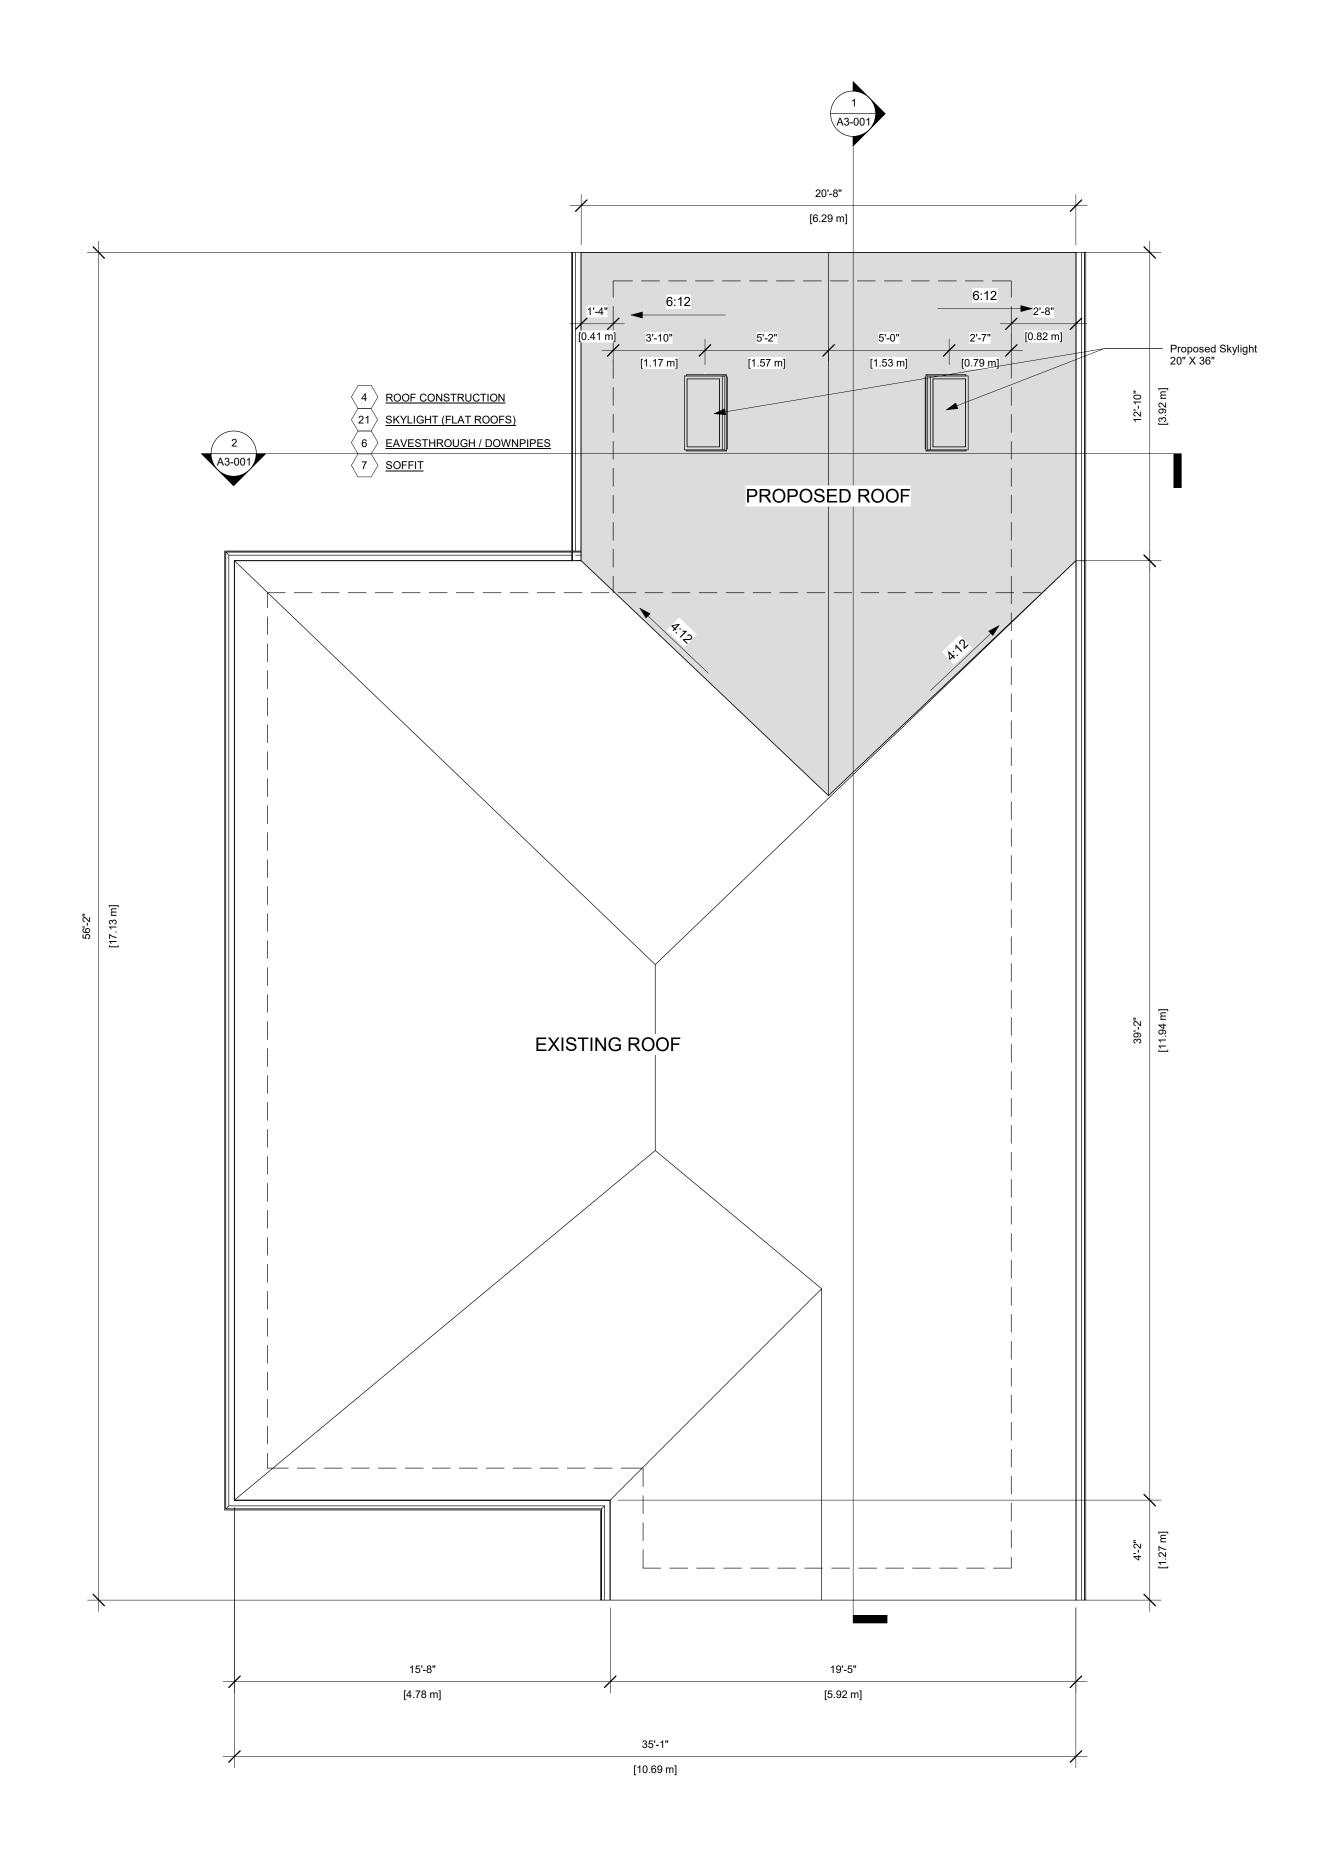



1050 OLD DERRY RD MISSISSAUGA ON L5W 1A1

CLIENT

Owner



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ROOF FLOOR PLAN

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As Noted 1/4" = 1'-0"

GRAPHIC SCALE

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PROJECT NO. 230122

STAGE

A1-003

LOCATION F




1050 OLD DERRY **MISSISSAUGA ON L5W 1A1**


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01	ISSUED FOR CLIENT	2023-07-19

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MISSISSAUGA





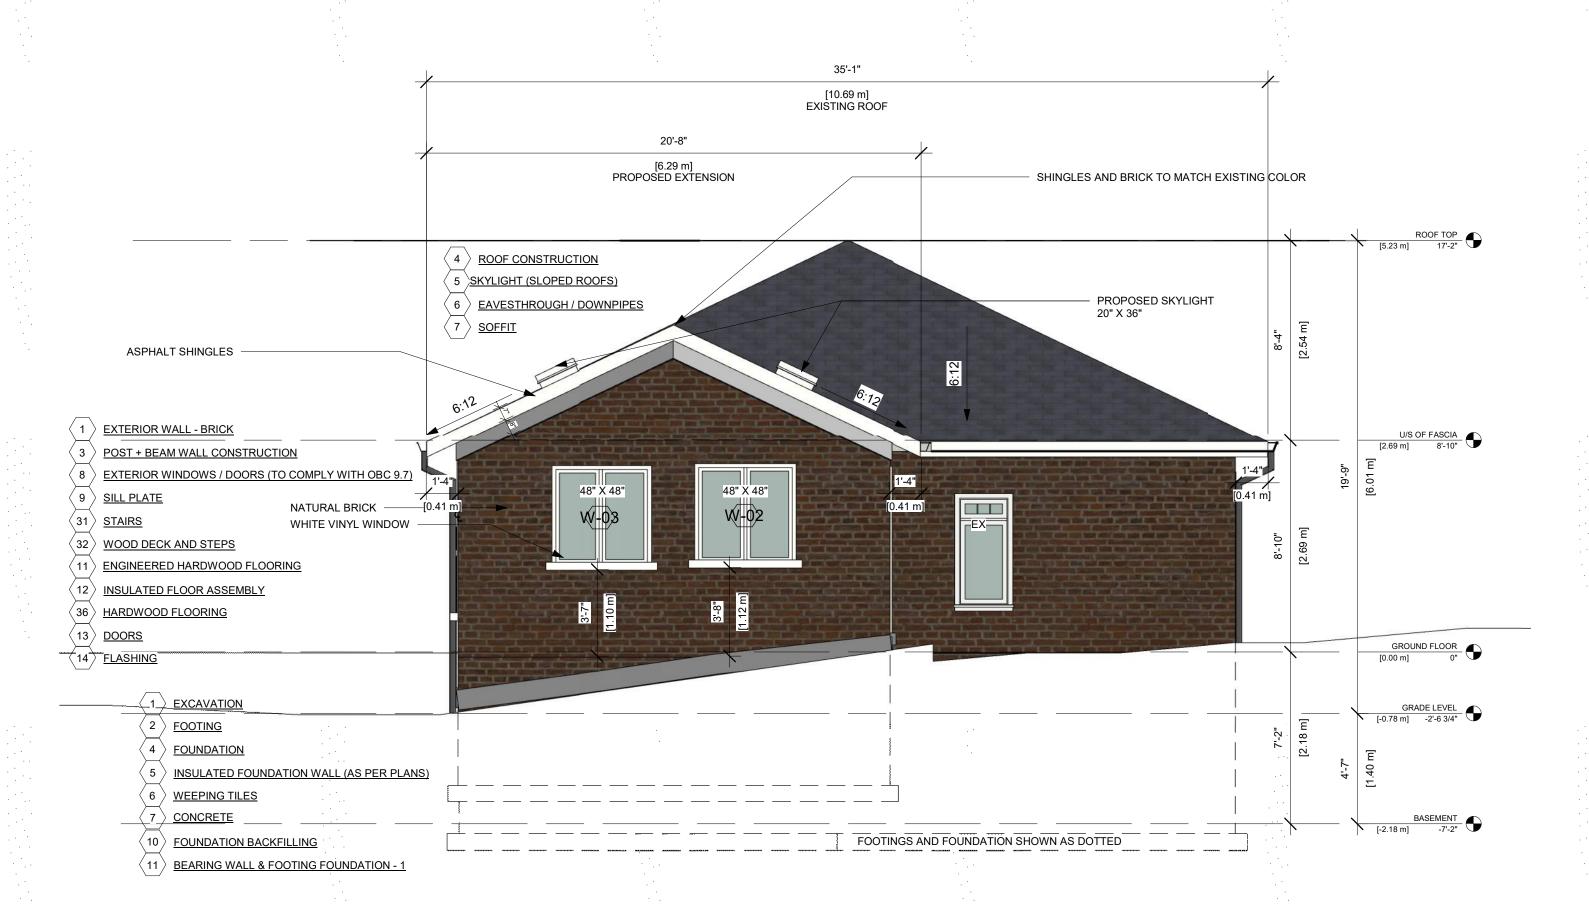

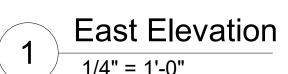West Elevation

1/4" = 1'-0"

- NATURAL BRICK TO MATCH EXISTING

- ASPHALT SHINGLES TO MATCH EXISTING

- WHITE VINYL WINDOWS

- WHITE VINYL SLIDING EXTERIOR DOOR

- WHITE ALUMINUM FRAME SKYLIGHT

PROJECT

1050 OLD DERRY RD MISSISSAUGA ON L5W 1A1

CLIENT

Owner



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DDODOCED EACT 9 IA

PROPOSED EAST & WEST ELEVATION

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SCALE @ ARCH D DATE

As Noted 1/4" = 1'-0"

PN N


PROJECT NO. 230122

STAGE 7

A2-002

LOCATION
MISSISSAUGA



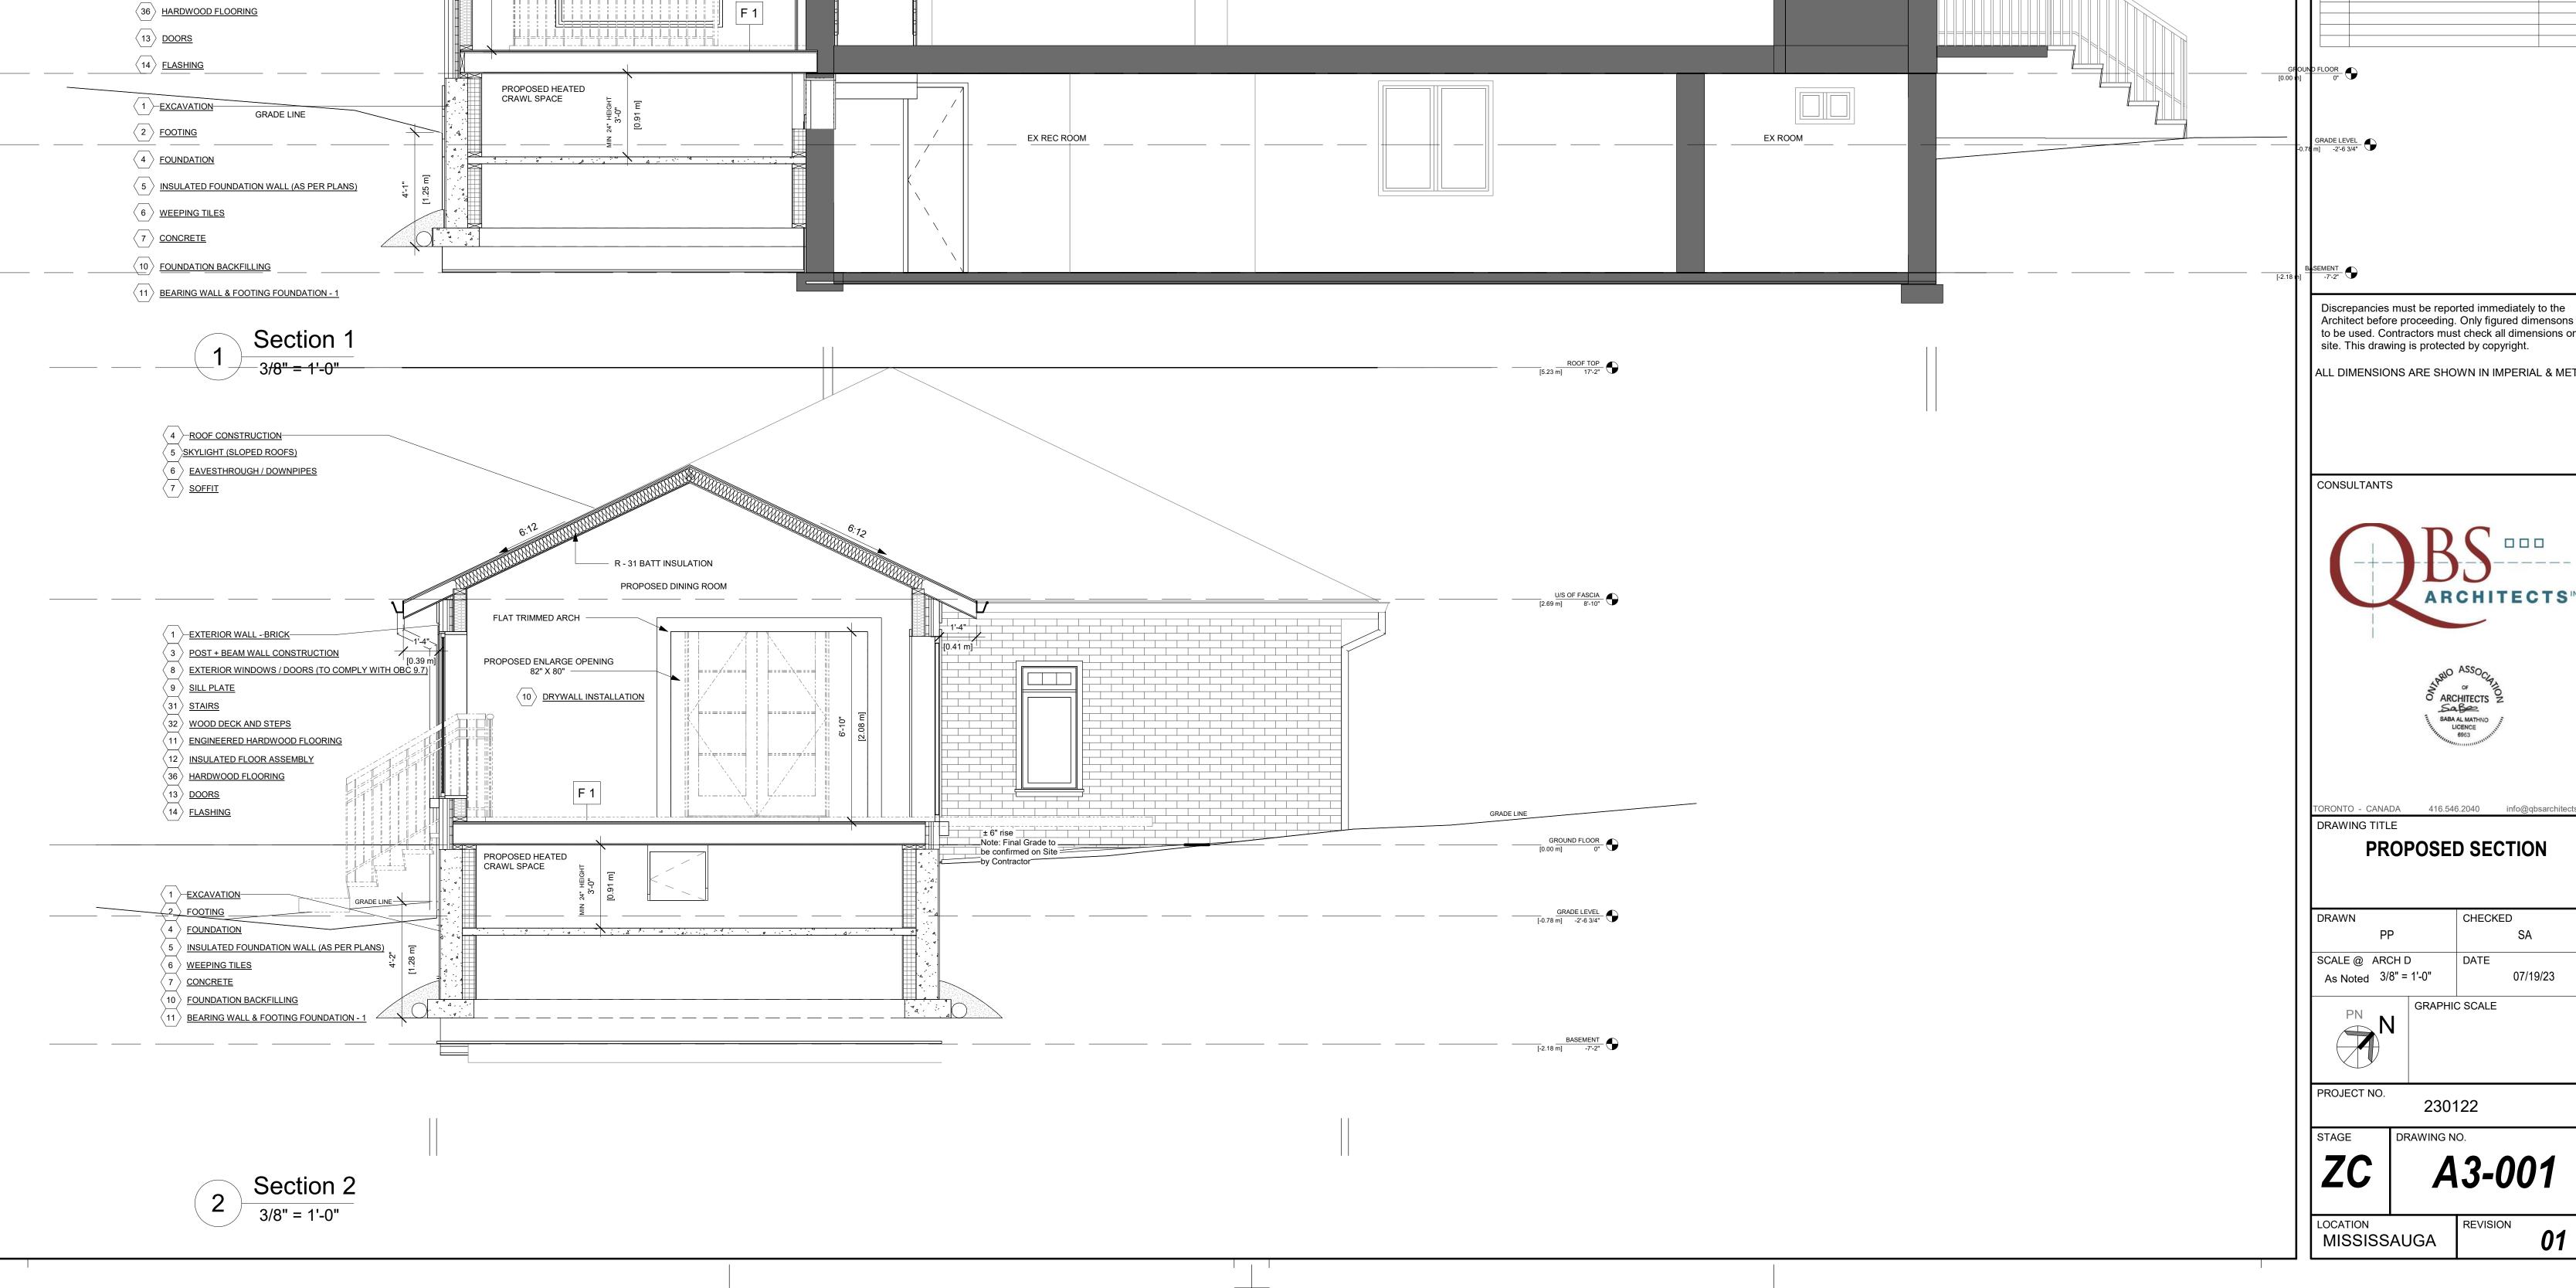

EX KITCHEN

4 -ROOF CONSTRUCTION-

7 SOFFIT

9 SILL PLATE

31 STAIRS

5 SKYLIGHT (SLOPED ROOFS)

1 -EXTERIOR WALL -BRICK-

32 WOOD DECK AND STEPS

12 INSULATED FLOOR ASSEMBLY

3 -POST + BEAM WALL CONSTRUCTION

11 ENGINEERED HARDWOOD FLOORING

8 EXTERIOR WINDOWS / DOORS (TO COMPLY WITH OBC 9.7)


6 EAVESTHROUGH / DOWNPIPES


R - 31 BATT INSULATION

PROPOSED DINING ROOM PROPOSED 6' X 6' WINDOW


Door Schedule					
Mark	Level	Width	Height	Phase Created	Comments
D-01	GROUND FLOOR	6'-0"	6'-8"	New Construction	
D-02	GROUND FLOOR	2'-0"	1'-9"	New Construction	

Window Schedule					
Mark	Level	Width	Height	Phase Created	Sill Height
W - 01	GROUND FLOOR	6'-0"	6'-0"	New Construction	1'-8"
W - 02	GROUND FLOOR	4'-0"	4'-0"	New Construction	3'-8"
W - 03	GROUND FLOOR	4'-0"	4'-0"	New Construction	3'-9"

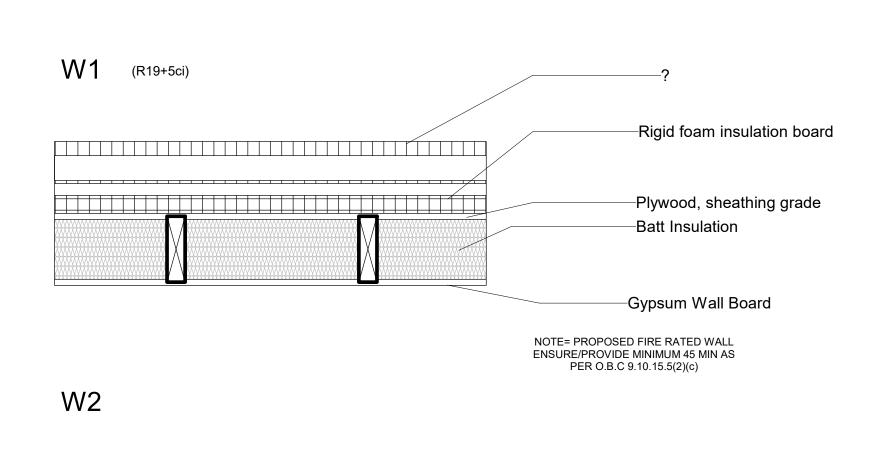

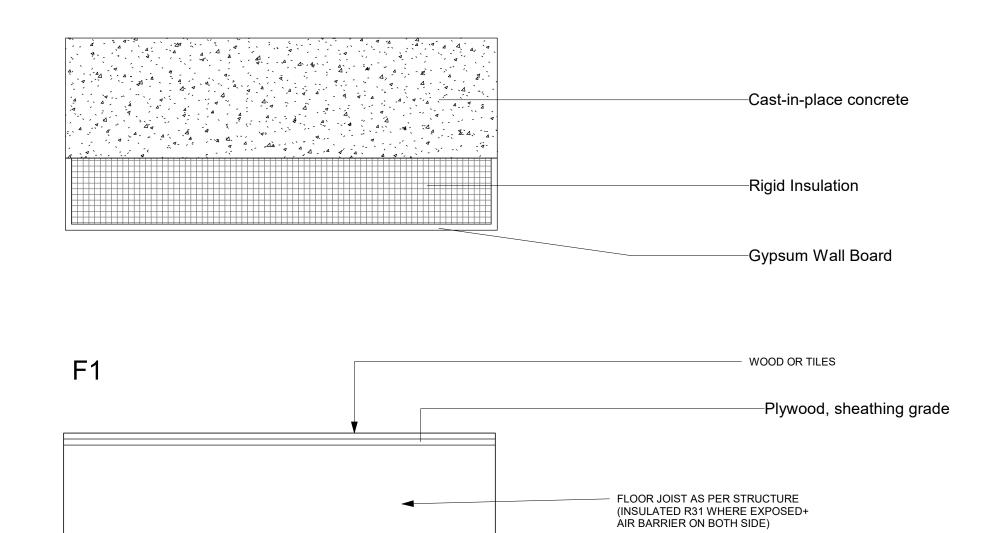

R31 WHERE EXPOSED

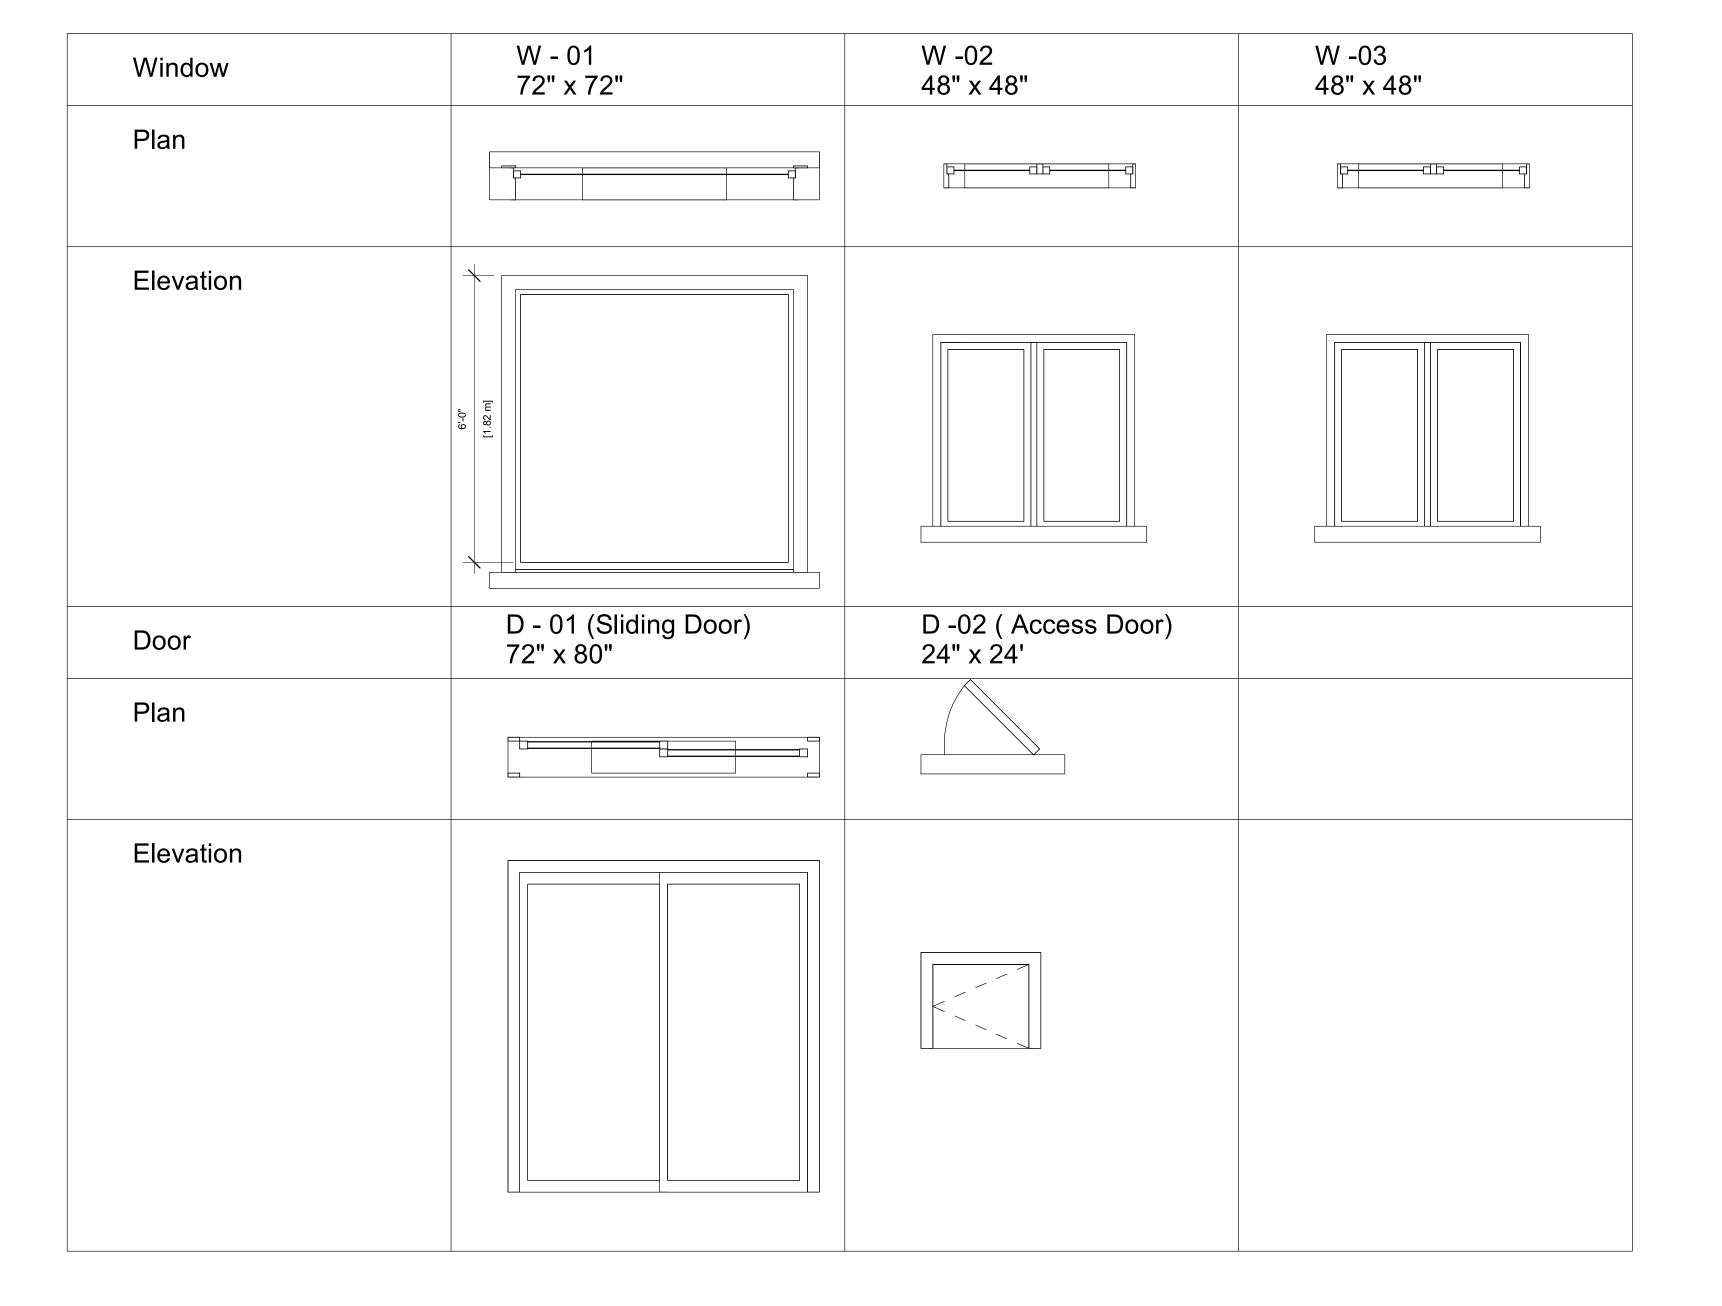

PROJECT

1050 OLD DERRY RD MISSISSAUGA ON L5W 1A1

CLIENT

Owner



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DOOR & WINDOW SCHEDULE

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As Noted As indicated

s indicated 07/19/23

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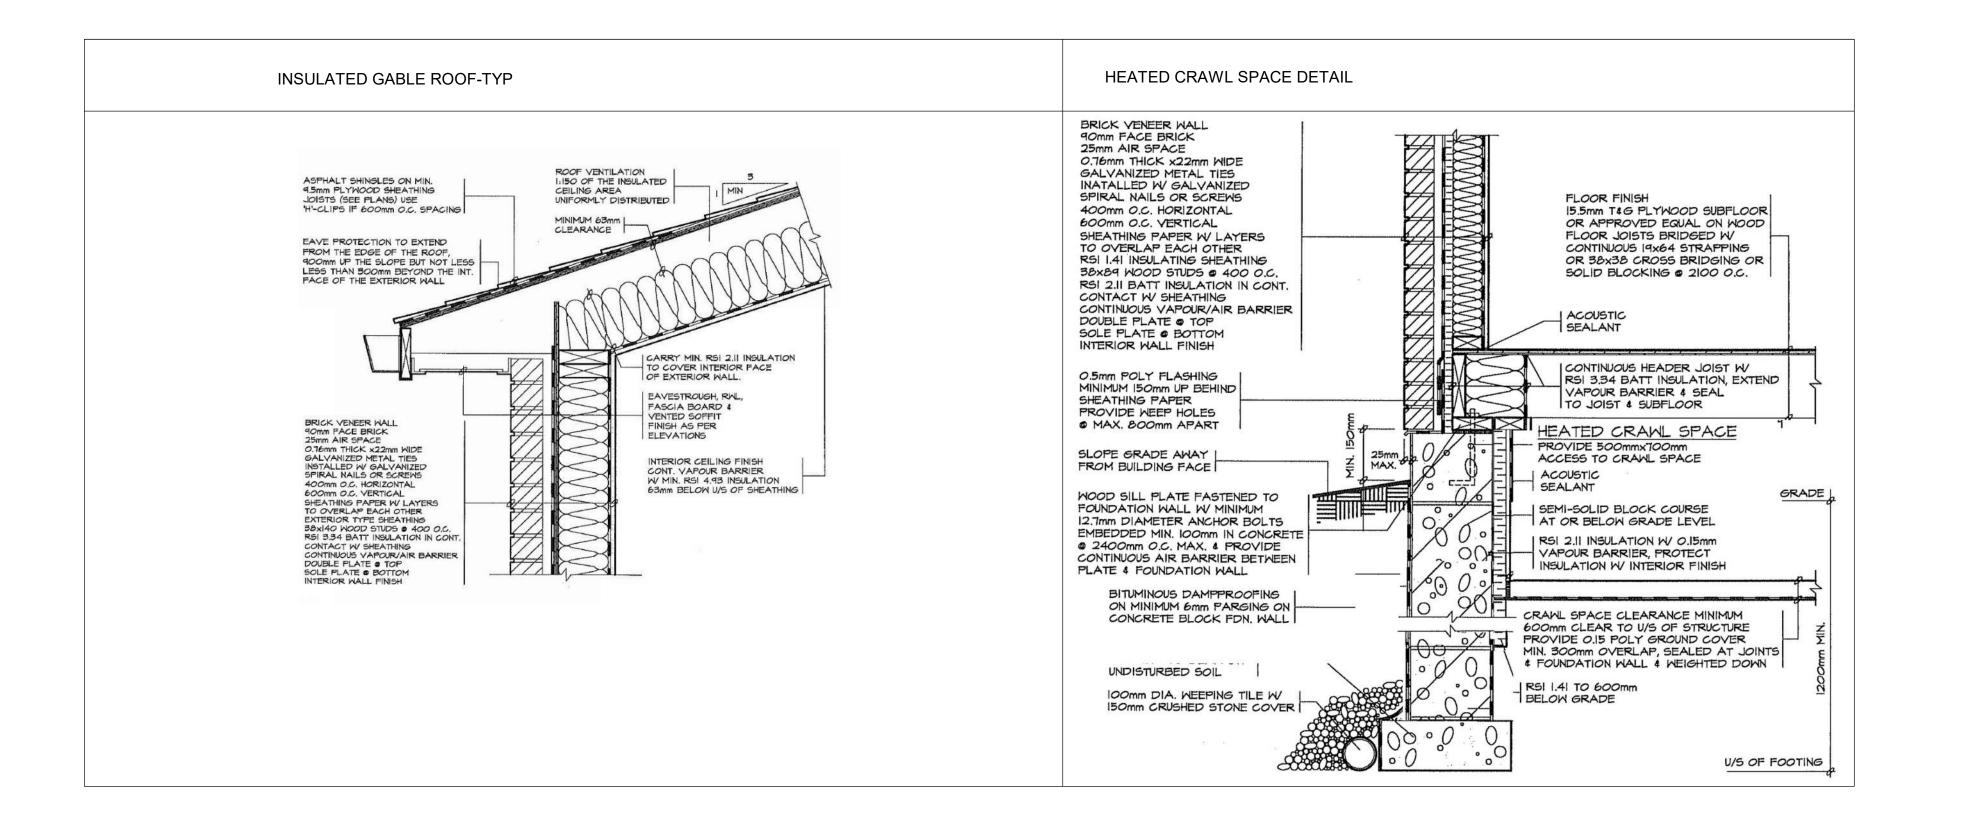
PROJECT NO.

230122

STAGE DRAWING NO.

ZC A

LOCATION REVISION MISSISSAUGA



1050 OLD DERRY RD MISSISSAUGA ON L5W 1A1

CLIENT

Owner



REVISIONS

No.	Description	Date
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DRAWING TITLE

DETAILS

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As Noted 3/16" = 1'-0"

'-0" DATE 07/19/23

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PROJECT NO. 230122

STAGE

DRAWING NO.

LOCATION RE MISSISSAUGA

REVISION 01